
# CONSTRUCTION DRAWINGS

**SEPTEMBER 26, 2011** 

# PLAYGROUNDS FOR THE GLASTONBURY EAST HARTFORD ELEMENTARY MAGNET SCHOOL

95 OAK STREET, GLASTONBURY, CONNECTICUT

STATE PROJECT NO: 0054-0095 MAG/N/PS STATE PROJECT NO: 0054-0096 MAG/N/PS Phase 4 of 4

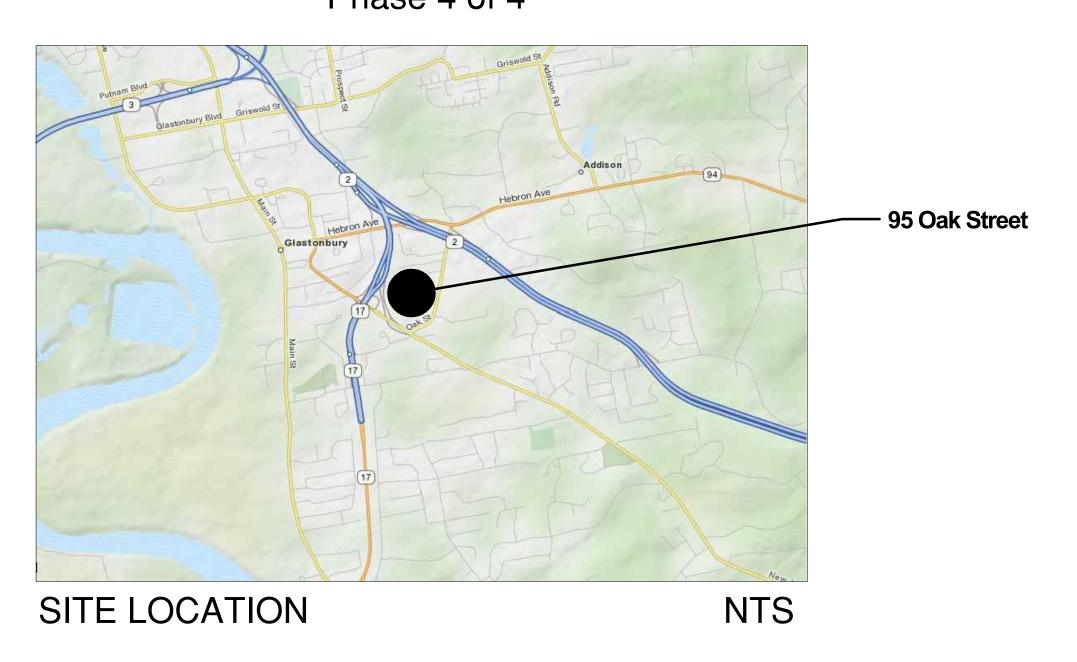

# CONTENTS

- L-1.0 Playground Locator Map L-2.0 Playground Layout -
- Age 2-5 L-2.1 Playground Layout -
- Age 5 12

  L-3.0 Playground Grading and


  Drainage Plan 
  Age 2- 5
- L-3.1 Playground Grading and Drainage Plan -
- Age 5 12
- L-4.0 Footing Plan Age 2 5 L-4.1 Footing Plan - Age 5 - 12
- L-5.0 Surfacing Plans
- L-6.0 Playground Details
- L-6.1 Playground Details
- L-6.2 Playground Details
- L-7.0 Elevations Age 2 5 L-7.1 Elevations - Age 5 - 12
- L-8.0 Isometric Age 2 5
- L-8.1 Isometric Age 5 12
- \_-9.0 Rendering Age 2 5
- Rendering Age 5-12

Prepared by:



P 860.612.1700 F 860.612.1757

www.todesignllc.com

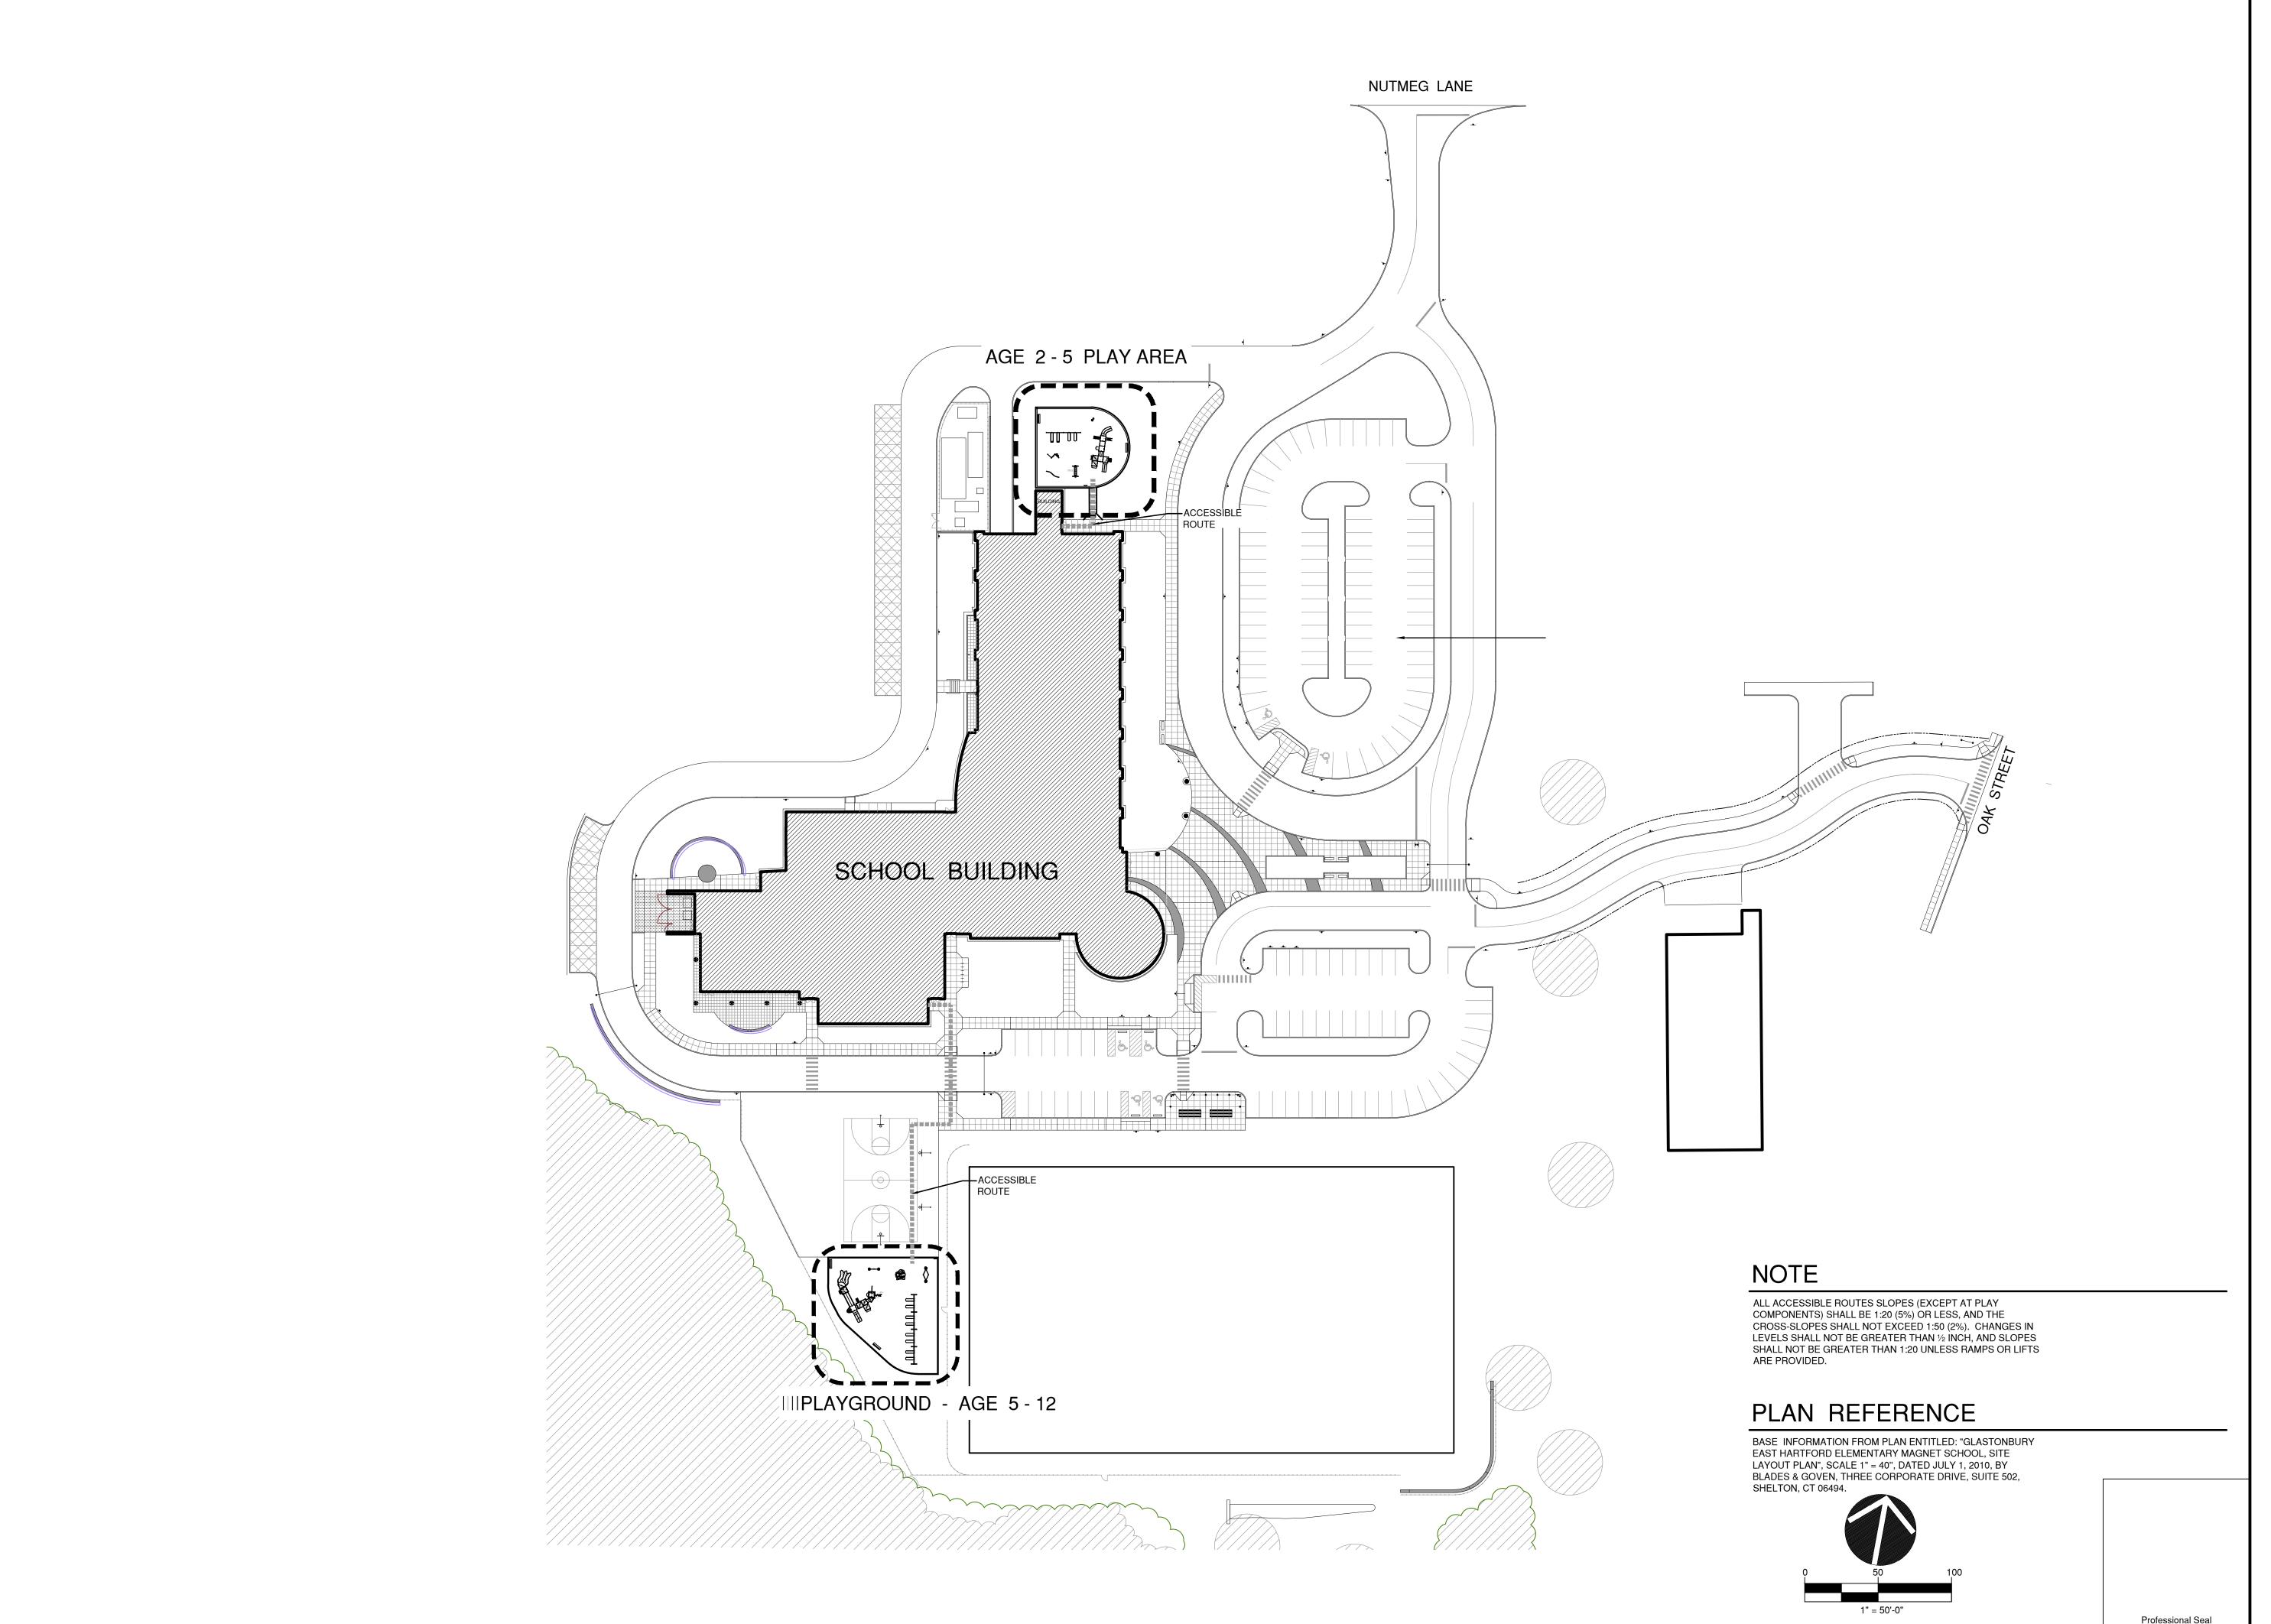

Sophisticated Site Design Landscape Architecture Civil Engineering

114 West Main Street, Suite 201 New Britain, CT 06051 P 860.612.1700 F 860.612.1757

www.todesignIIc.com

TOWN OF GLASTONBURY 2155 MAIN STREET

STATE PROJECT NO. 054-0095 MAG/N/PS 054-0096 MAG/N/PS Phase 4 of 4

BID NO.

GL-2011-04-BP-120

Sheet Description:

# **Playground** Locator Map


SEPTEMBER 26, 2011

1" = 50'-0"

Project number:

L-1.0

Drawn by:

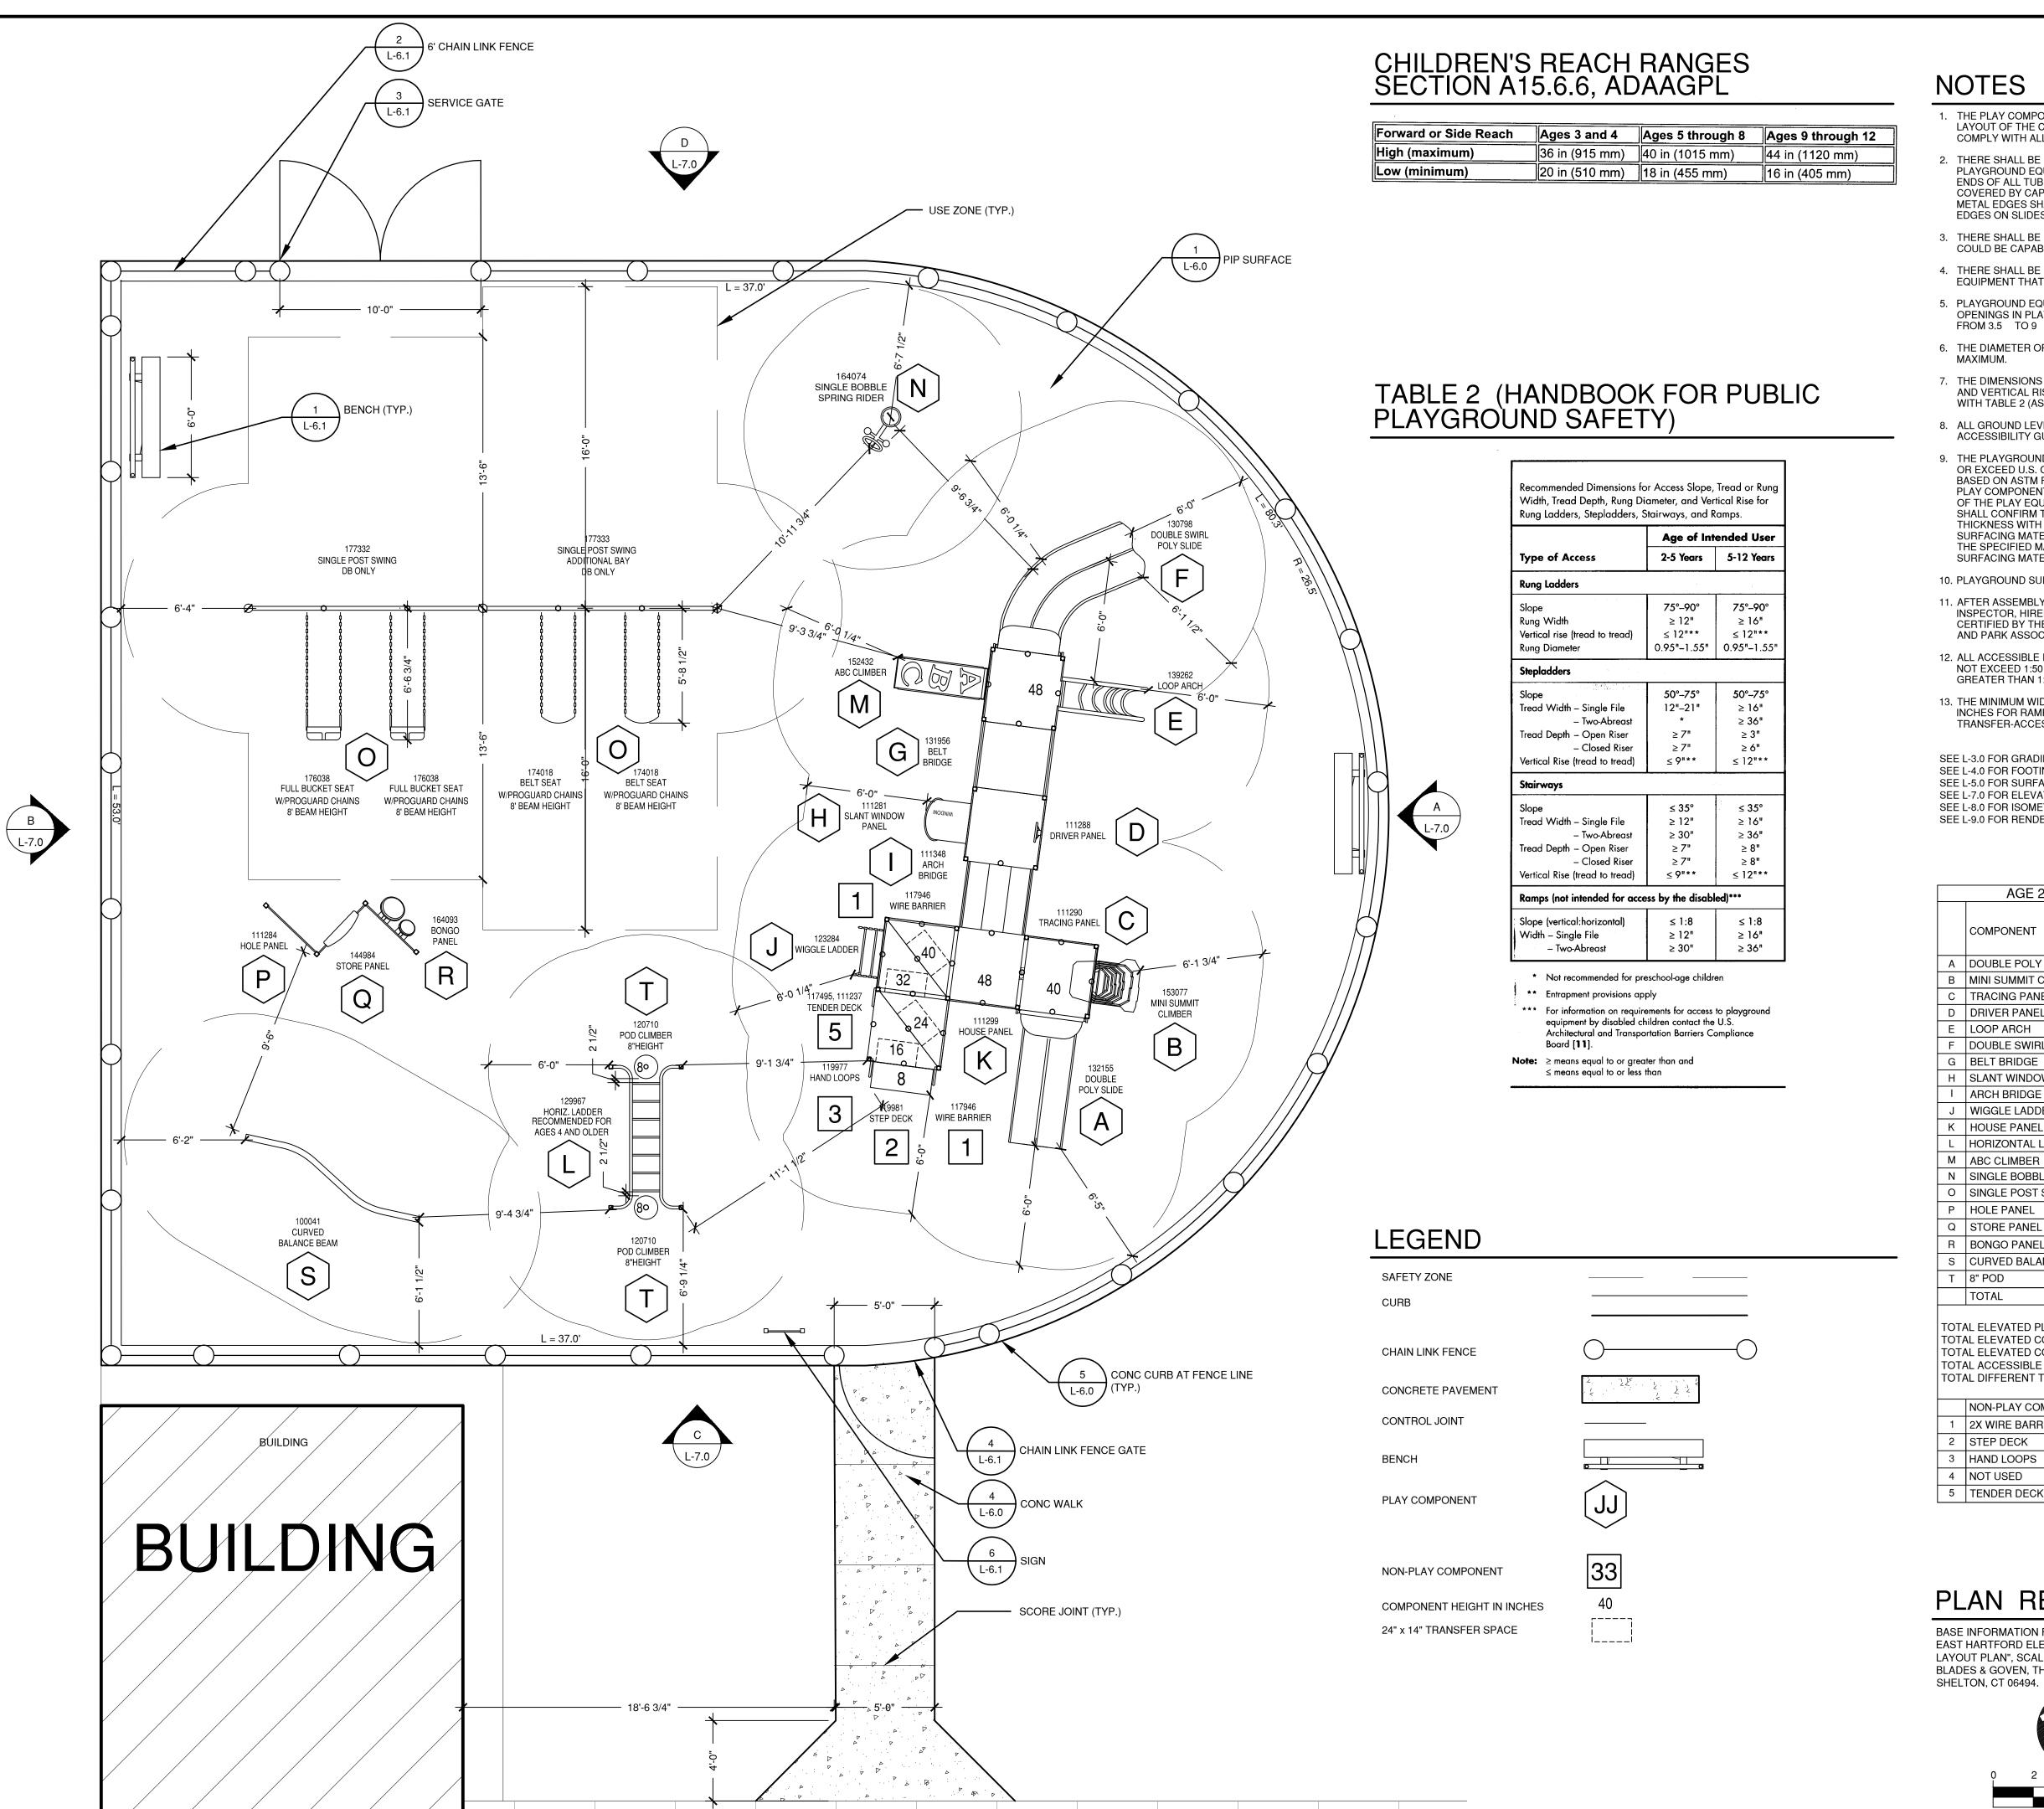

### NOTES

- 1. THE PLAY COMPONENTS IDENTIFIED ON THESE PLANS SHALL BE IPEMA CERTIFIED. THE USE AND LAYOUT OF THE COMPONENTS SHALL CONFORM TO THE REQUIREMENTS OF ASTM F1487, AND COMPLY WITH ALL APPLICABLE CPSC, ADA, AND ASTM STANDARDS.
- 2. THERE SHALL BE NO SHARP POINTS, CORNERS, OR EDGES ON ANY COMPONENTS OF THE PLAYGROUND EQUIPMENT THAT COULD CUT OR PUNCTURE CHILDREN'S SKIN. THE EXPOSED OPEN ENDS OF ALL TUBING NOT RESTING ON THE GROUND OR OTHERWISE COVERED SHALL BE COVERED BY CAPS OR PLUGS THAT CANNOT BE REMOVED WITHOUT THE USE OF TOOLS. ALL METAL EDGES SHALL BE ROLLED OR HAVE ROUNDED CAPPING. THERE SHALL BE NO SHARP
- 3. THERE SHALL BE NO PROTRUSIONS OR PROJECTIONS ON THE PLAYGROUND EQUIPMENT THAT COULD BE CAPABLE OF ENTANGLING CHILDREN'S CLOTHING.
- 4. THERE SHALL BE NO ACCESSIBLE PINCH, CRUSH OR SHEARING POINTS ON THE PLAYGROUND EQUIPMENT THAT COULD CAUSE INJURY OR CATCH CHILDREN'S CLOTHING.
- 5. PLAYGROUND EQUIPMENT SHALL BE DESIGNED AND CONSTRUCTED SO THAT ACCESSIBLE OPENINGS IN PLAY EQUIPMENT AND STRUCTURES CAN NOT PASS A SPHERE RANGING IN SIZE
- 6. THE DIAMETER OR WIDTH OF HANDRAILS SHALL BE 0.95 INCHES MINIMUM TO 1.55 INCHES
- 7. THE DIMENSIONS FOR ACCESS SLOPE, TREAD OR RUNG WIDTH, TREAD DEPTH, RUNG DIAMETER, AND VERTICAL RISE FOR RUNG LADDERS, STEPLADDERS, STAIRWAYS, AND RAMPS SHALL COMPLY
- 8. ALL GROUND LEVEL PLAY COMPONENTS SHALL COMPLY WITH THE REACH RANGE IN THE ADA ACCESSIBILITY GUIDELINES FOR BUILDINGS AND FACILITIES; PLAY AREAS (A15.6.6).
- 9. THE PLAYGROUND SAFETY SURFACING SHALL BE STABLE, FIRM, SLIP-RESISTANT, AND SHALL MEET OR EXCEED U.S. CONSUMER PRODUCT SAFETY COMMISION GUIDELINES FOR CRITICAL HEIGHT BASED ON ASTM F-1292 IMPACT ATTENUATION TESTING FOR THE FALL HEIGHTS REQUIRED BY THE PLAY COMPONENTS INCLUDED IN THE DESIGN. THE CURRENT DESIGN, PER THE MANUFACTURER OF THE PLAY EQUIPMENT, CALLS FOR MEETING A FALL HEIGHT OF 8' - 0 . THE CONTRACTOR SHALL CONFIRM THE FINAL MAXIMUM FALL HEIGHT REQUIREMENTS AND APPROPRIATE SURFACING THICKNESS WITH THE PLAYSCAPE MANUFACTURER PRIOR TO CONSTRUCTION. FOR LOOSE FILL SURFACING MATERIALS, THE INITIAL FILL SHALL BE 25% GREATER THAN WHAT IS REQUIRED FOR THE SPECIFIED MAXIMUM FALL HEIGHT, TO ACCOMMODATE COMPACTION/WEATHERING. SURFACING MATERIALS SHALL ALSO COMPLY WITH ASTM F-1487, ASTM F-1951, AND ASTM F-1292.
- 10. PLAYGROUND SURFACE SLOPES SHALL NOT EXCEED 2% (1:48) IN ANY DIRECTION.
- 11. AFTER ASSEMBLY AND BEFORE IT'S USE, EQUIPMENT MUST BE THOROUGHLY INSPECTED BY AN INSPECTOR, HIRED BY THE OWNER. THE INSPECTOR MUST BE A PLAYGROUND INSPECTOR CERTIFIED BY THE NATIONAL PLAYGROUND SAFETY INSTITUTE AND THE NATIONAL RECREATION AND PARK ASSOCIATION.
- 12. ALL ACCESSIBLE ROUTES SLOPES SHALL BE 1:20 (5%) OR LESS, AND THE CROSS-SLOPES SHALL NOT EXCEED 1:50 (2%). CHANGES IN LEVEL SHALL NOT EXCEED ½ , AND SLOPES SHALL NOT BE GREATER THAN 1:20 UNLESS A RAMP OR A LIFT IS PROVIDED.
- 13. THE MINIMUM WIDTH OF THE ACCESSIBLE ROUTE THROUGH THE PLAY EQUIPMENT SHALL BE: 36 INCHES FOR RAMP-ACCESSIBLE ELEVATED PLAY COMPONENTS, AND 24 INCHES FOR TRANSFER-ACCESSIBLE ELEVATED PLAY COMPONENTS.


SEE L-3.0 FOR GRADING AND DRAINAGE PLAN. SEE L-4.0 FOR FOOTING PLAN.

- SEE L-5.0 FOR SURFACING LAYOUT PLAN.
- SEE L-7.0 FOR ELEVATIONS.
- SEE L-8.0 FOR ISOMETRICS.
- SEE L-9.0 FOR RENDERINGS.

| OUBLE POLY SLIDE INI SUMMIT CLIMBER RACING PANEL RIVER PANEL OOP ARCH | X<br>X<br>X  |   | X<br>X<br>X   |
|---|--|---|---|
| RACING PANEL<br>RIVER PANEL   | Х  |   |   |
| RIVER PANEL   |  |   | Х   |
|   | Х  |   |   |
| OOP ARCH  |  |   | Х   |
|   | Х  |   | Х   |
| OUBLE SWIRL POLY SLIDE  | Х  |   | Х   |
| ELT BRIDGE  | Х  |   | Х   |
| LANT WINDOW PANEL   | Х  |   | Х   |
| RCH BRIDGE  | Х  |   | Х   |
| /IGGLE LADDER   | Х  |   | Х   |
| OUSE PANEL  | Х  |   | Х   |
| ORIZONTAL LADDER  |  | Х   | Х   |
| BC CLIMBER  | Х  |   | Х   |
| INGLE BOBBLE RIDER  |  | Х   | Х   |
| INGLE POST SWINGS 2 BAYS  |  | Х   | Х   |
| OLE PANEL   |  | Х   | Х   |
| TORE PANEL  |  | Х   | Х   |
| ONGO PANEL  |  | Х   | Х   |
| URVED BALANCED BEAM   |  | X   | Х   |
| ' POD   |  | X   | Х   |
| OTAL  | 12   | 8   | 20  |
|   | ANT WINDOW PANEL RCH BRIDGE GGLE LADDER OUSE PANEL ORIZONTAL LADDER BC CLIMBER NGLE BOBBLE RIDER NGLE POST SWINGS 2 BAYS OLE PANEL TORE PANEL ONGO PANEL URVED BALANCED BEAM POD | ANT WINDOW PANEL  RCH BRIDGE  X  IGGLE LADDER  X  OUSE PANEL  CRIZONTAL LADDER  BC CLIMBER  NGLE BOBBLE RIDER  NGLE POST SWINGS 2 BAYS  OLE PANEL  TORE PANEL  ONGO PANEL  URVED BALANCED BEAM  POD | ANT WINDOW PANEL RCH BRIDGE X RIGGLE LADDER X OUSE PANEL DRIZONTAL LADDER X SC CLIMBER NGLE BOBBLE RIDER NGLE POST SWINGS 2 BAYS OLE PANEL TORE PANEL X DNGO PANEL X DNGO PANEL X POD X |

### PLAN REFERENCE

BASE INFORMATION FROM PLAN ENTITLED: "GLASTONBURY EAST HARTFORD ELEMENTARY MAGNET SCHOOL, SITE LAYOUT PLAN", SCALE 1" = 40", DATED JULY 1, 2010, BY BLADES & GOVEN, THREE CORPORATE DRIVE, SUITE 502,

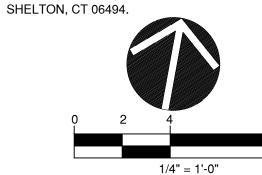

Sophisticated Site Design **Landscape Architecture** Civil Engineering

114 West Main Street, Suite 201 New Britain, CT 06051 P 860.612.1700 F 860.612.1757

www.todesignllc.com

**TOWN OF GLASTONBURY** 2155 MAIN STREET

STATE PROJECT NO. 054-0095 MAG/N/PS 054-0096 MAG/N/PS Phase 4 of 4


BID NO. GL-2011-04-BP-120

Sheet Description:

Playground Layout -Age 2 - 5

**SEPTEMBER 26, 2011** Drawn by: MWF 1/4" = 1'-0"

Project number:

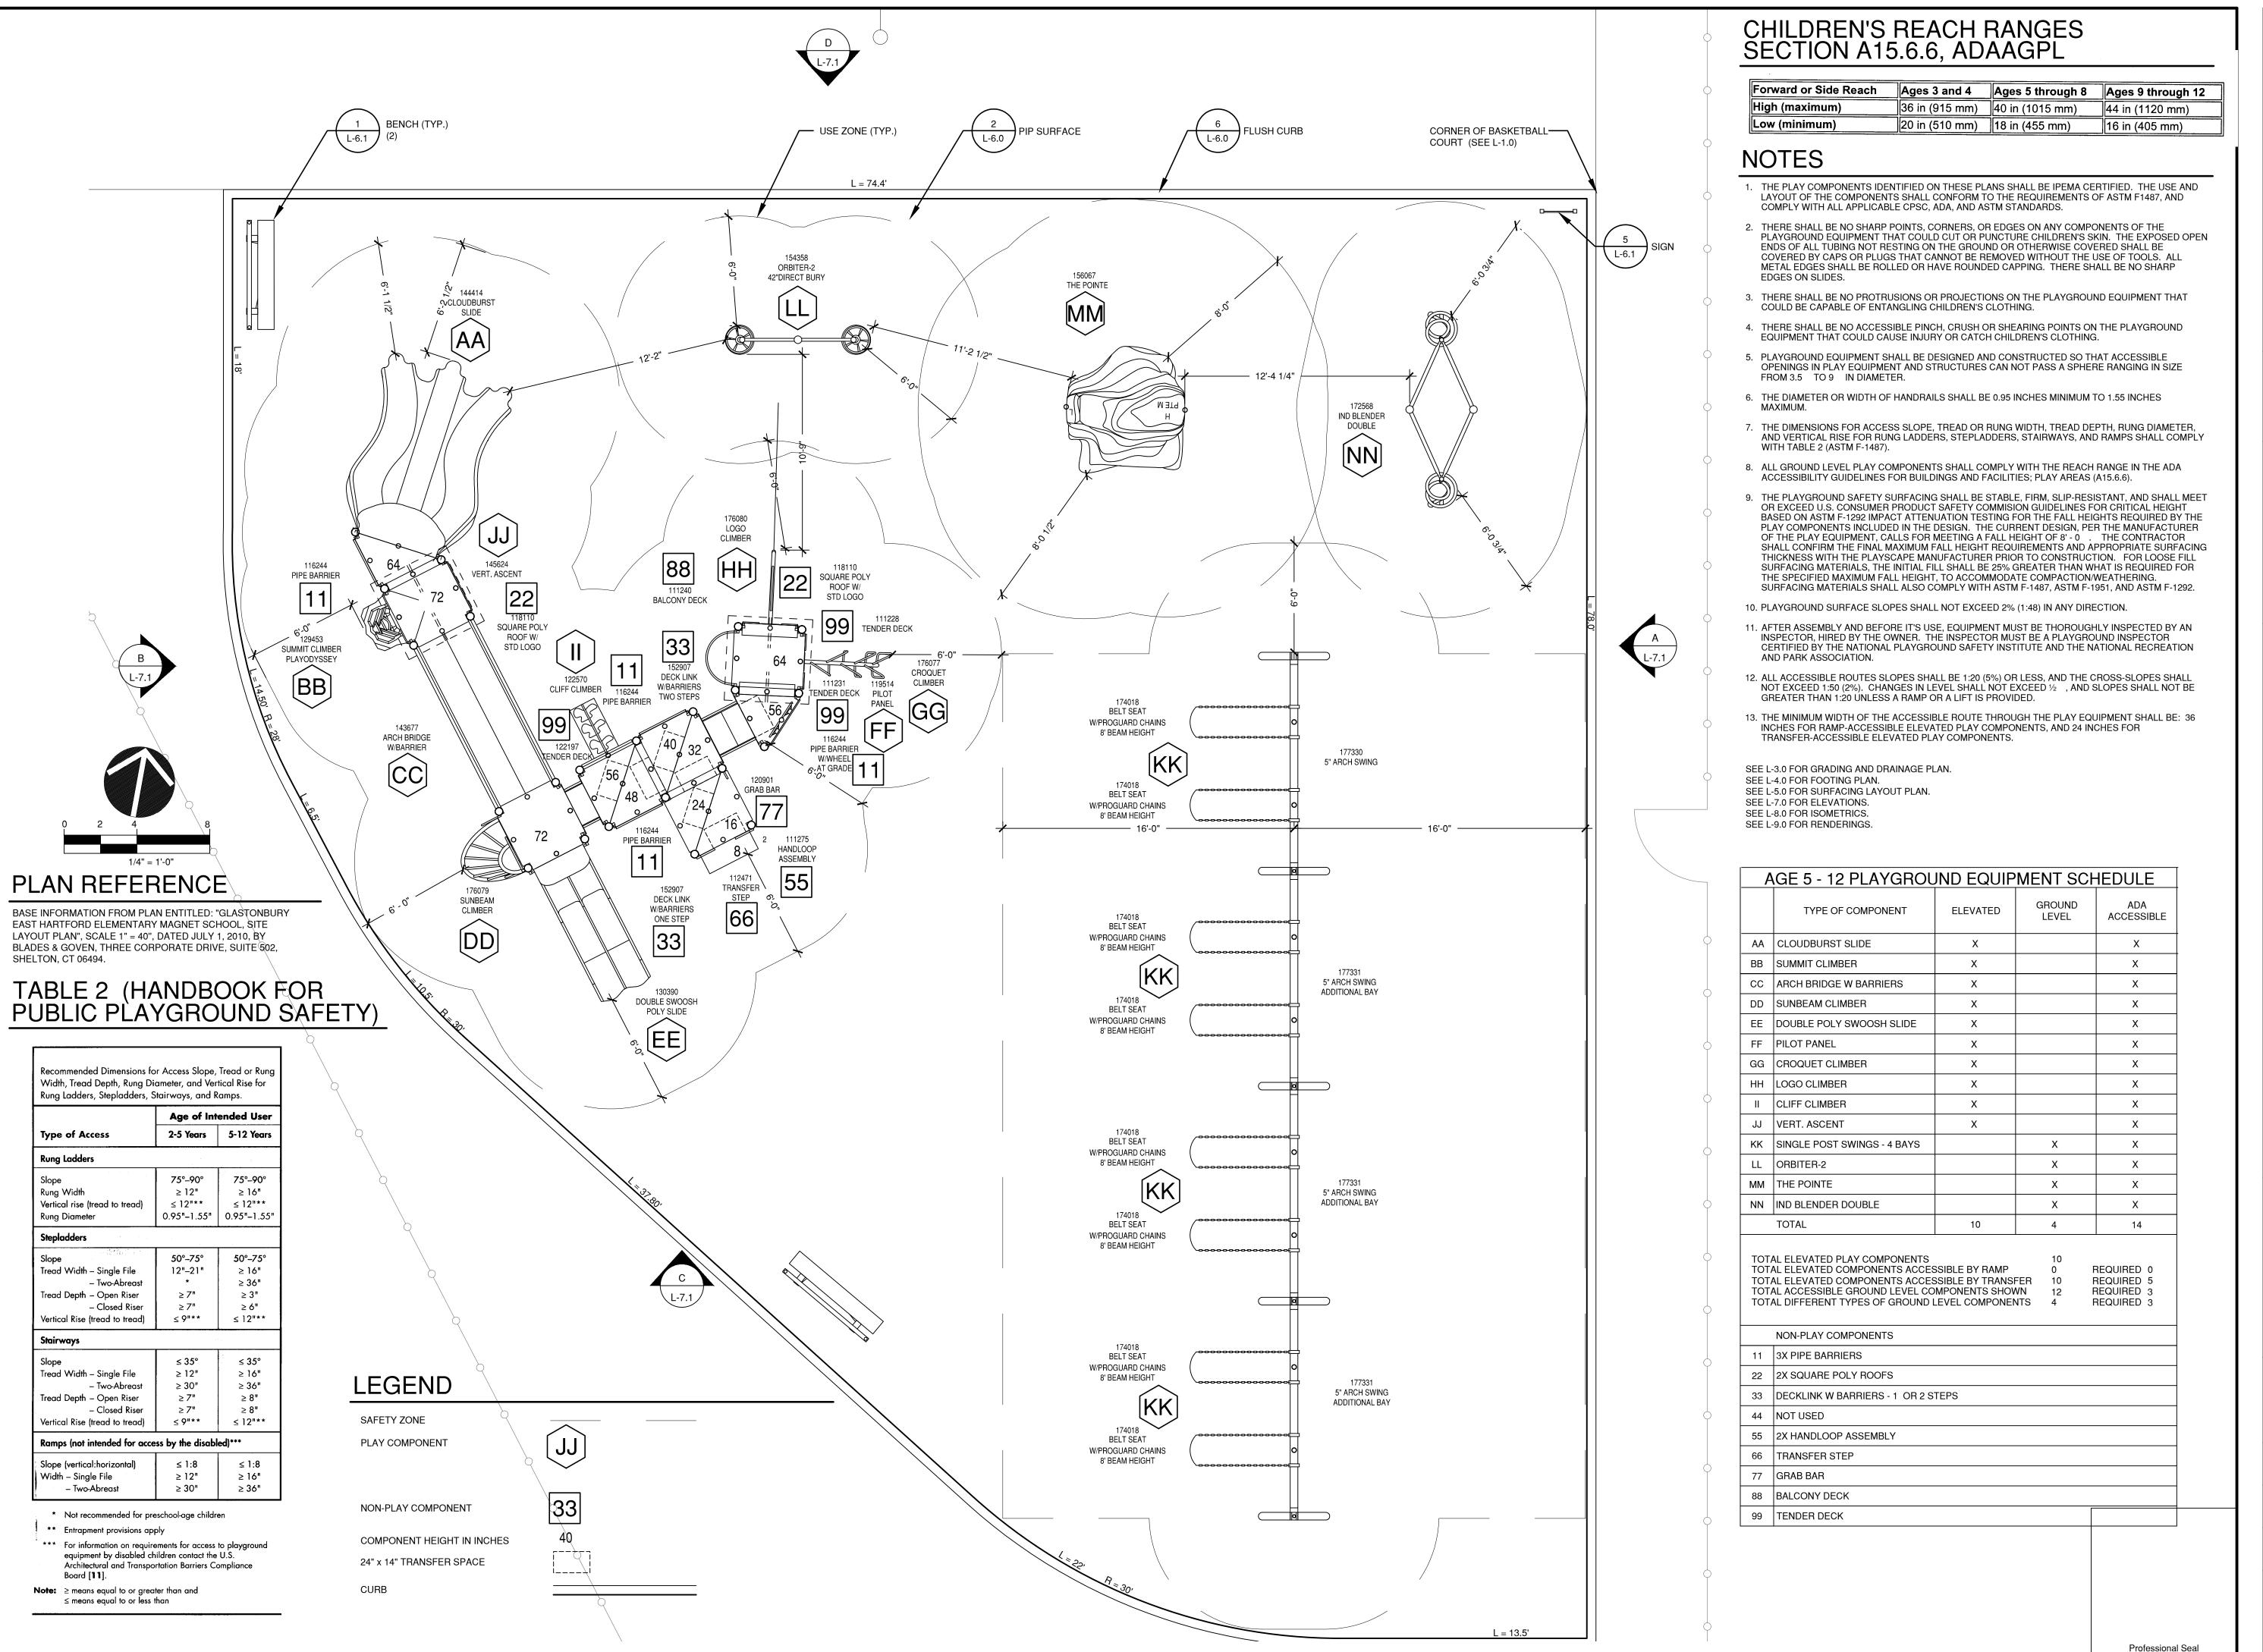

DESIGNILO

Sophisticated Site Design Landscape Architecture Civil Engineering

114 West Main Street, Suite 201 New Britain, CT 06051 P 860.612.1700 F 860.612.1757

www.todesignIIc.com

TOWN OF GLASTONBURY 2155 MAIN STREET

state PROJECT NO. 054-0095 MAG/N/PS 054-0096 MAG/N/PS Phase 4 of 4

BID NO. GL-2011-04-BP-120

> RD TSCHOOL

ONBURY ARTFORD

ļ

Sheet Description:

Playground Layout -Age 5 - 12

Rev:

Date:

SEPTEMBER 26, 2011


cale: Drawn by:

1/4" = 1'-0" MWF

Project number:

5484-L Sheet #:

L-2.1

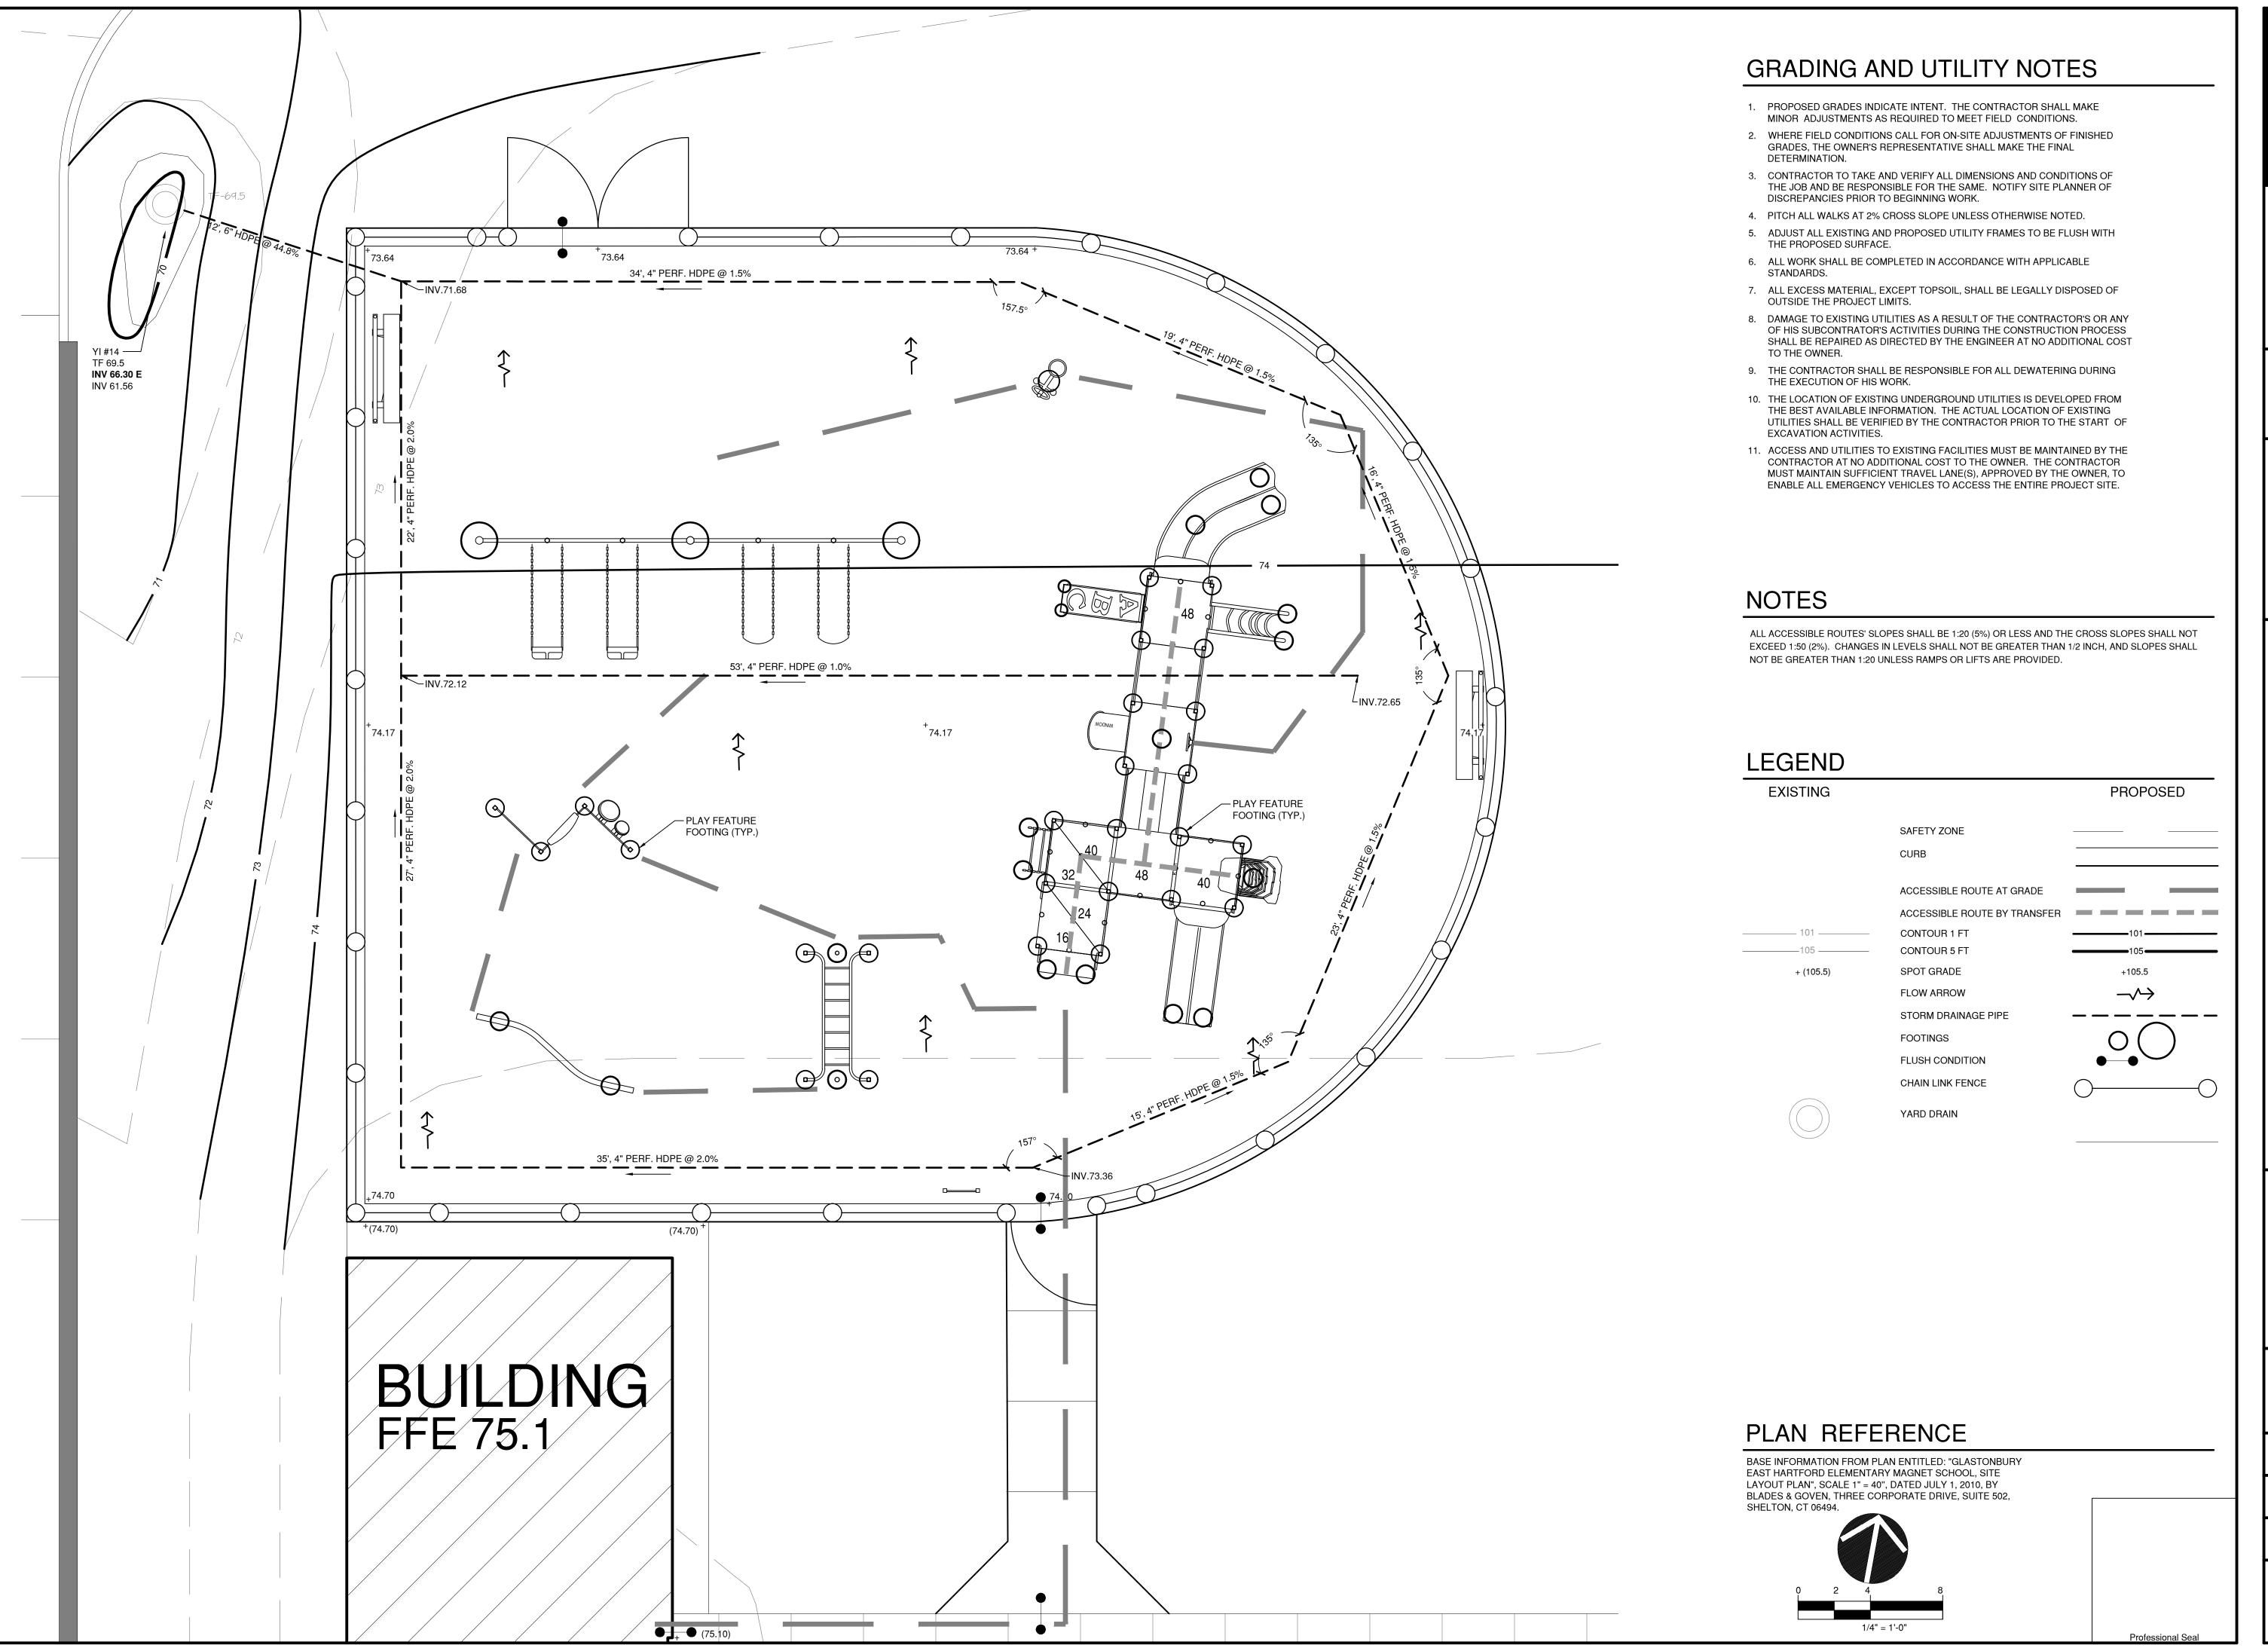

Sophisticated Site Design Landscape Architecture **Civil Engineering** 

114 West Main Street, Suite 201 New Britain, CT 06051 P 860.612.1700 F 860.612.1757

www.todesignllc.com Prepared For:

TOWN OF **GLASTONBURY** 2155 MAIN STREET

STATE PROJECT NO. 054-0095 MAG/N/PS 054-0096 MAG/N/PS Phase 4 of 4

BID NO. GL-2011-04-BP-120

Sheet Description:

Playground Grading and Drainage Plan Age 2 - 5


SEPTEMBER 26, 2011 Drawn by:

MWF

1/4" = 1'-0"

Project number:

L-3.0

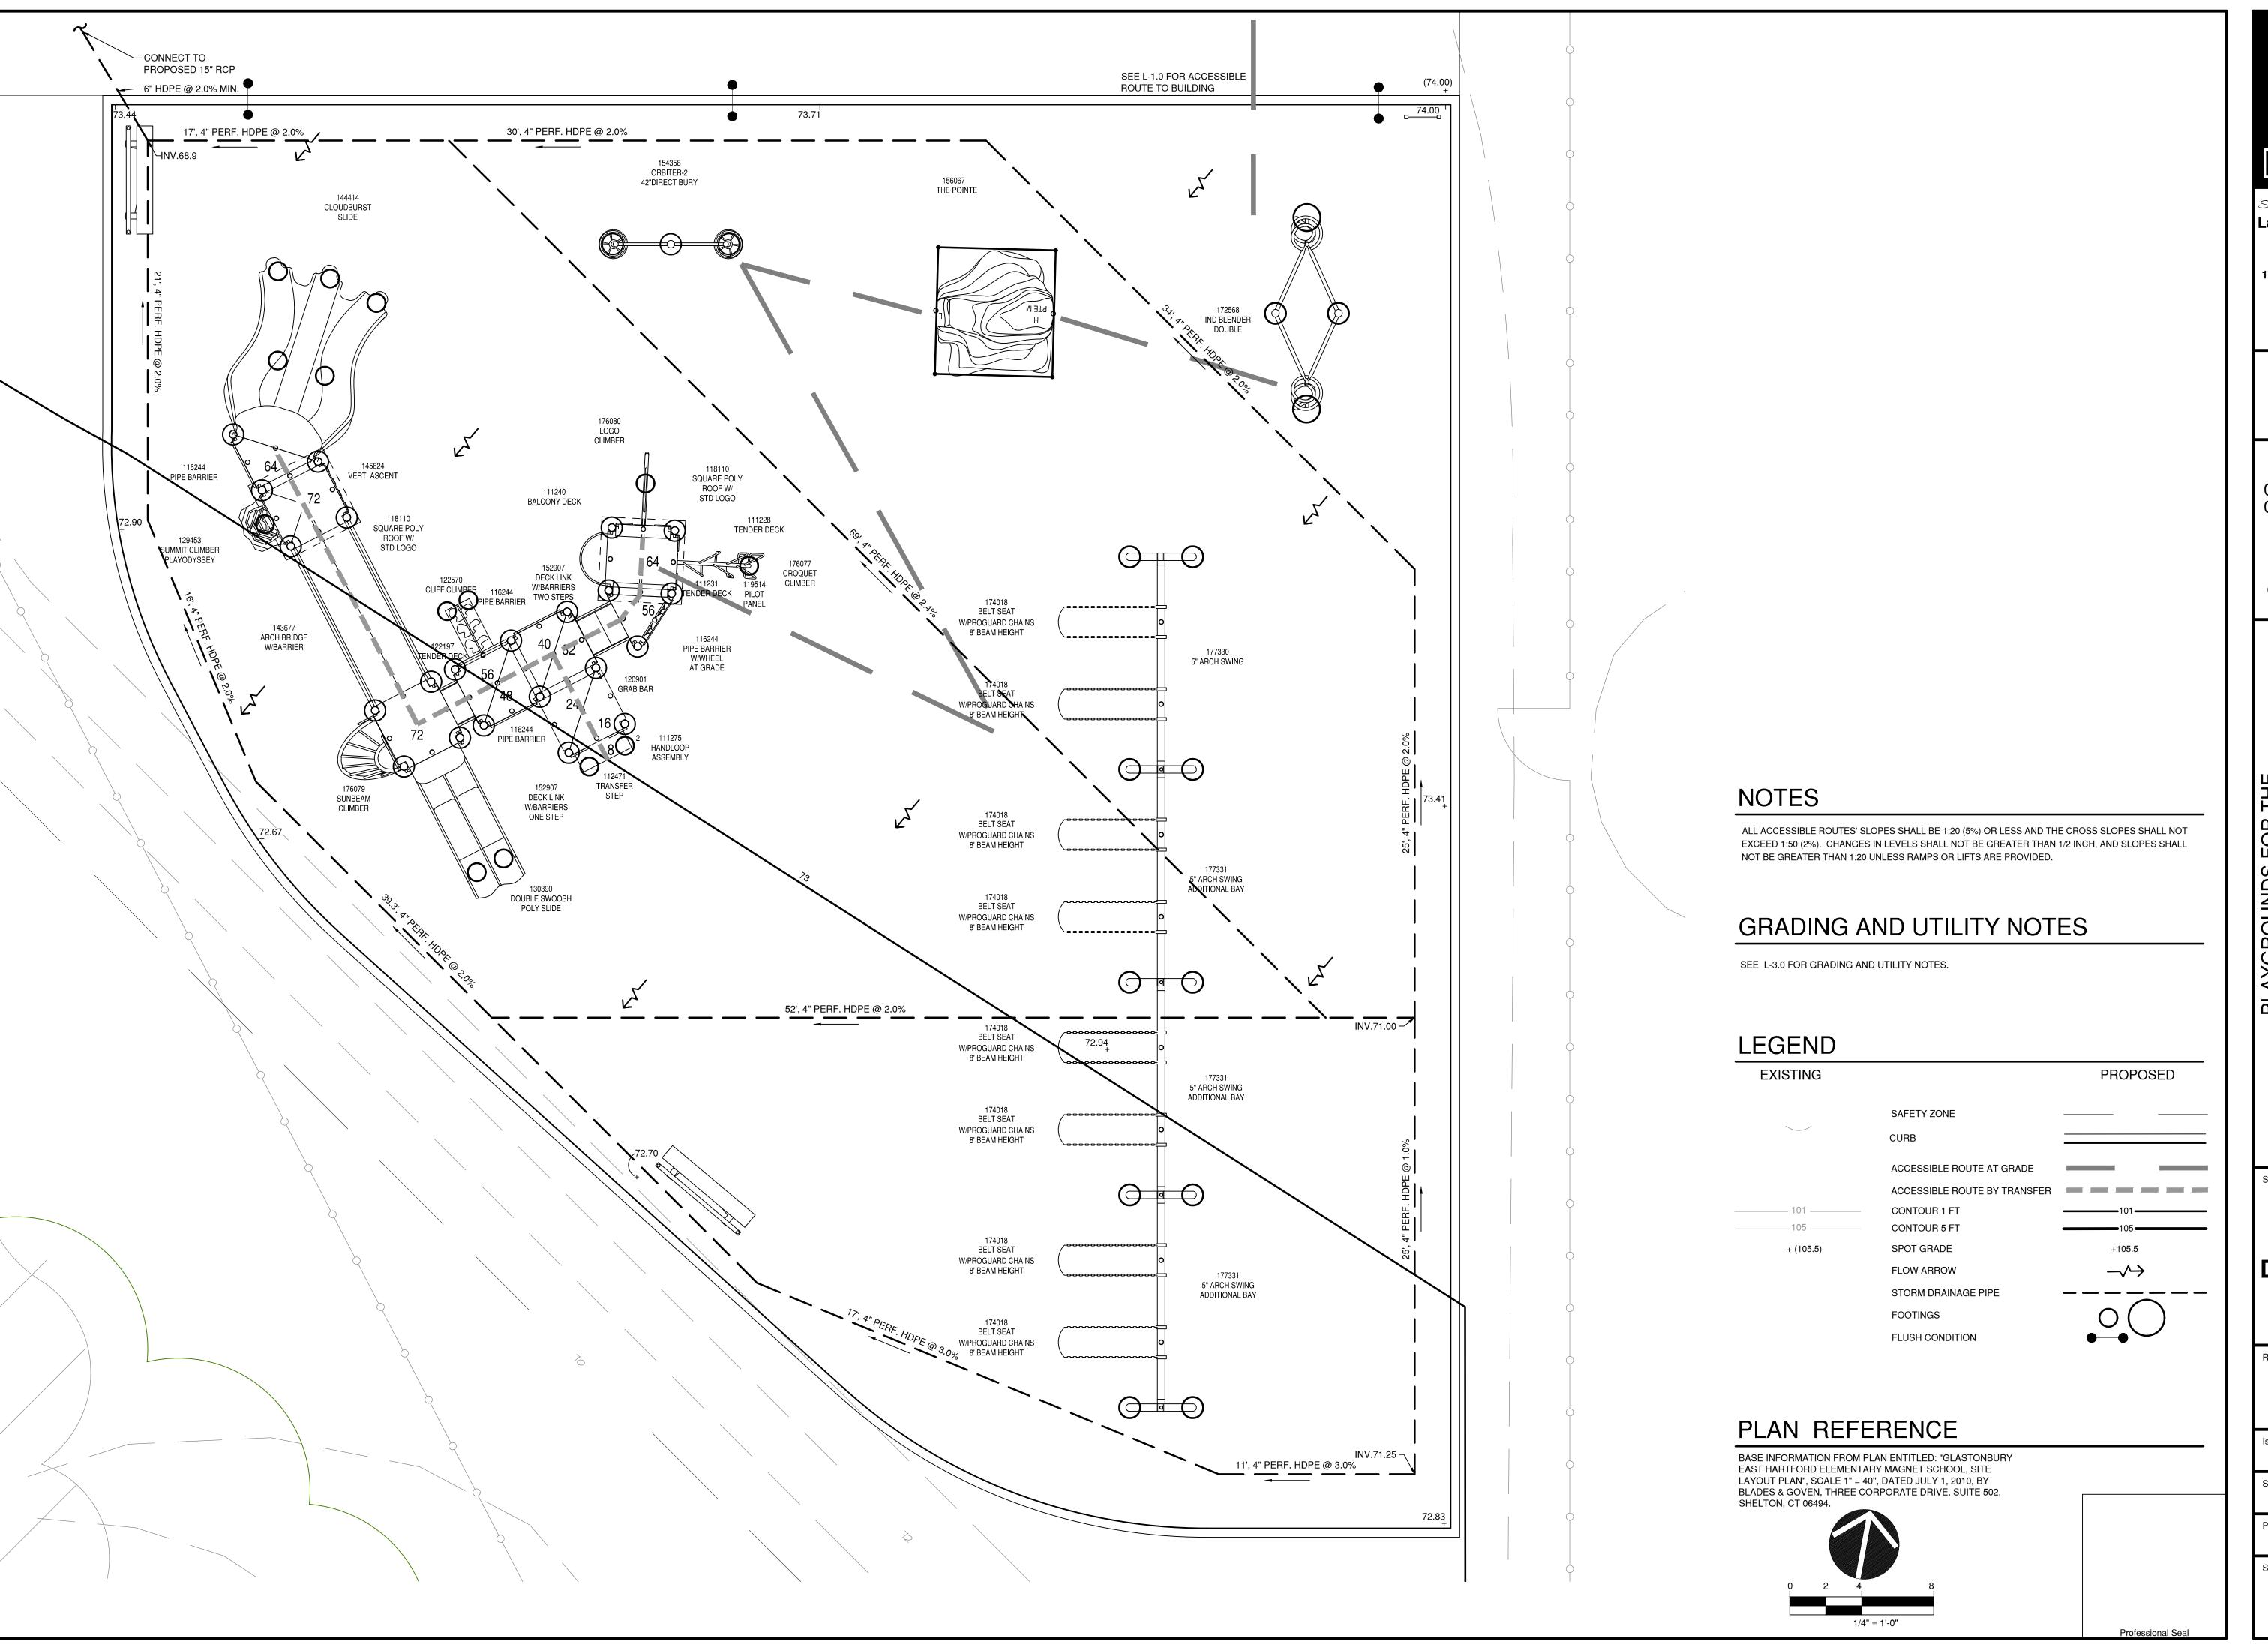

DESIGNILO

Sophisticated Site Design
Landscape Architecture
Civil Engineering

114 West Main Street, Suite 201 New Britain, CT 06051 P 860.612.1700 F 860.612.1757

www.todesignllc.com

TOWN OF GLASTONBURY 2155 MAIN STREET

state PROJECT NO. 054-0095 MAG/N/PS 054-0096 MAG/N/PS Phase 4 of 4

BID NO. GL-2011-04-BP-120

> ONBURY ARTFORD AGNET SCHOOL

GLASTONBU
EAST HARTFC
EMENTARY MAGNE

Playground
Grading and
Drainage Plan
Age 5 - 12

lev:

sue Date:

SEPTEMBER 26, 2011


Scale: Drawn by:

1/4" = 1'-0" MWF

Project number:

5484-L

L-3.1

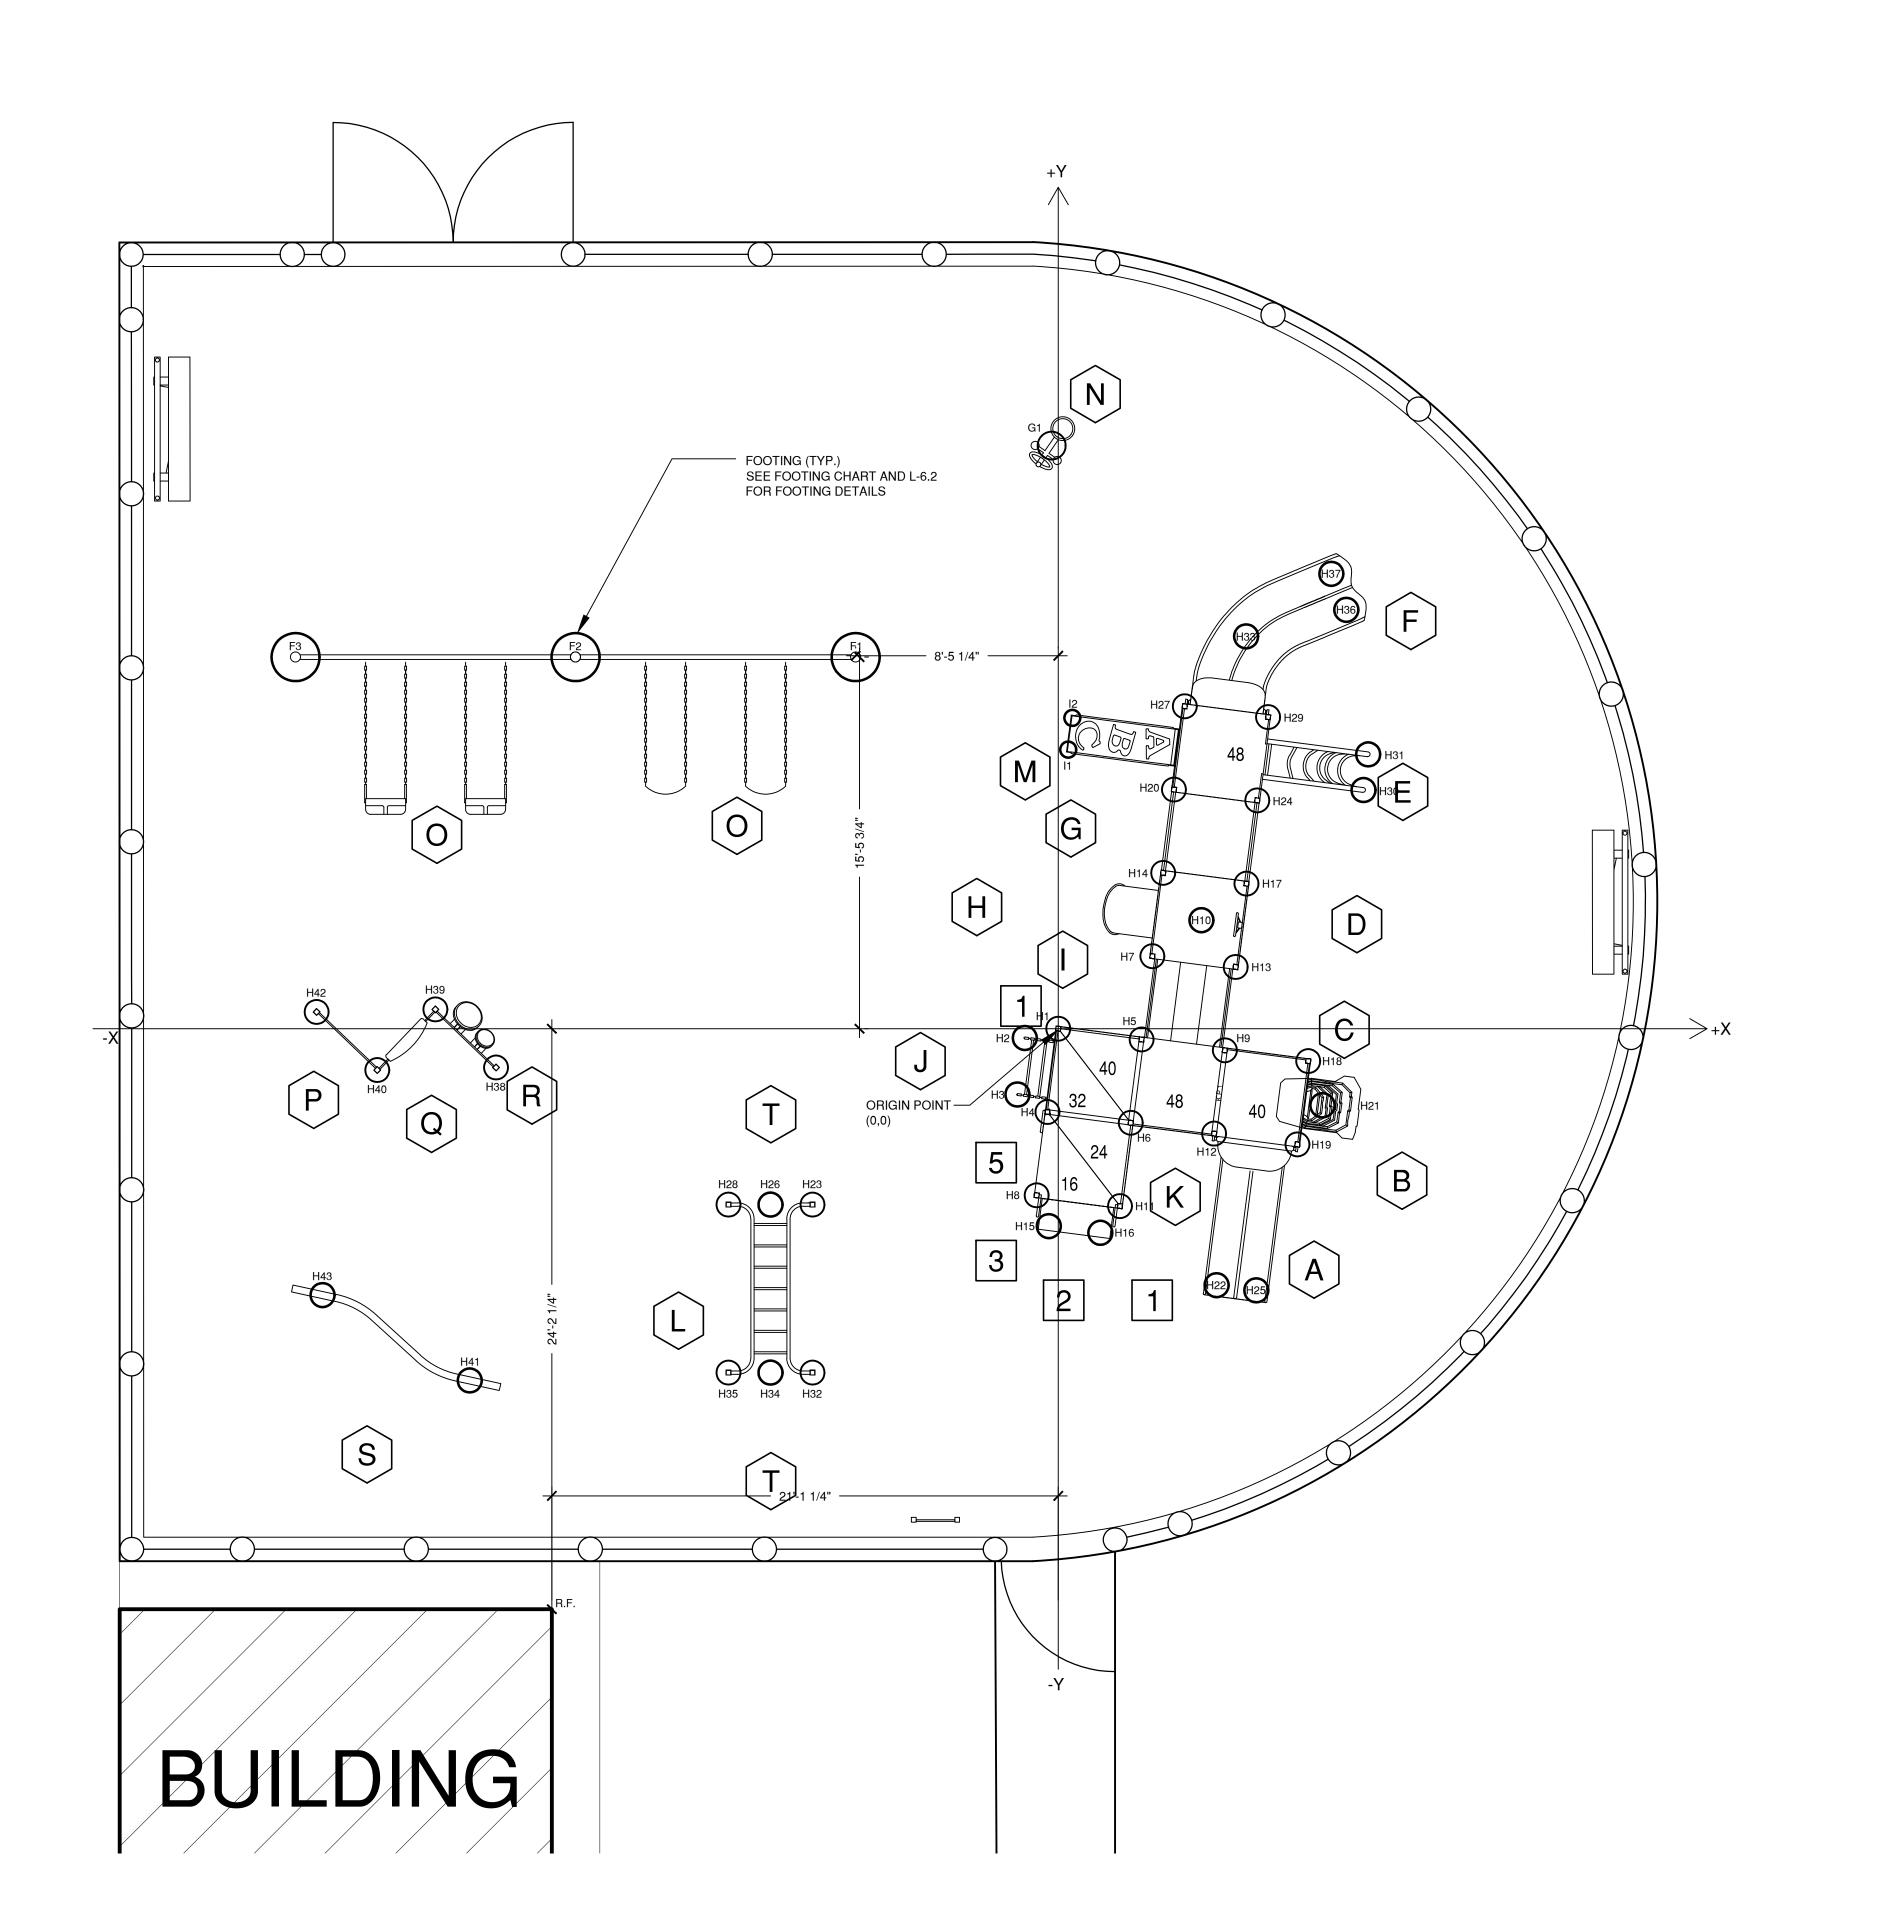

# NOTES: 1. SEE PRODUCT CU 2. SEE DRAWING L-2.

AGE 2 - 5 EQUIPMENT SCHEDULE

TYPE OF COMPONENT

F DOUBLE SWIRL POLY SLIDE

H SLANT WINDOW PANEL

HORIZONTAL LADDER

N SINGLE BOBBLE RIDER

S CURVED BALANCED BEAM

O SINGLE POST SWINGS 2 BAYS

A DOUBLE POLY SLIDE
B MINI SUMMIT CLIMBER

C TRACING PANEL
D DRIVER PANEL
E LOOP ARCH

G BELT BRIDGE

J WIGGLE LADDER
K HOUSE PANEL

M ABC CLIMBER

P HOLE PANEL

Q STORE PANEL
R BONGO PANEL

1 2X WIRE BARRIER
2 STEP DECK
3 HAND LOOPS
4 NOT USED
5 TENDER DECK

T 8" POD

SEE PRODUCT CUT SHEETS FOR PRECISE DIMENSIONS.
 SEE DRAWING L-2.0 FOR EQUIPMENT & MATERIALS INFORMATION.
 ALL EQUIPMENT SHOULD USE CONCRETE FOOTING INSTALLATION.

3. ALL EQUIPMENT SHOULD USE CONCRETE FOOTING INSTALLATION DO NOT USE SURFACE MOUNT INSTALLATION.


4. SEE L-6.2 FOR SPECIFIC CONCRETE FOOTING. 5. ALL FOOTINGS TO BE A MIN. DEPTH OF 42".

# FOOTING CHART

| N. | I.D. | X (ft-in) | Y (ft-in)               | Dist. to O | DIA (in) | Detail on L-6.2 |
|----|------|-----------|-------------------------|------------|----------|-----------------|
| 1  | R.F. | -21'-1"   | -24'-2"                 | 32'-1"     | NA       | NA              |
| 2  | F1   | -8'-5"    | 15'-6"                  | 17'-8"     | 24       | 5               |
| 3  | F2   | -20'-1"   | 15'-6"                  | 25'-5"     | 24       | 5               |
| 4  | F3   | -31'-9"   | 15'-6"                  | 35'-4"     | 24       | 5               |
| 5  | G1   | -3"       | 24'-4"                  | 24'-4"     | 14       | 4               |
| 6  | H1   | 0"        | 0"                      | 0"         | 12       | 2               |
| 7  | H2   | -1'-5"    | -5"                     | 1'-5"      | 12       | 2               |
| 8  | Н3   | -1'-8"    | -2'-9"                  | 3'-3"      | 12       | 2               |
| 9  | H4   | -5"       | -3'-6"                  | 3'-6"      | 12       | 2               |
| 10 | H5   | 3'-6"     | -5"                     | 3'-6"      | 12       | 2               |
| 11 | H6   | 3'        | -3'-11"                 | 4'-11"     | 12       | 2               |
| 12 | H7   | 3'-11"    | 3'                      | 4'-11"     | 12       | 2               |
| 13 | H8   | -11"      | -6'-11"                 | 7'         | 12       | 2               |
| 14 | Н9   | 6'-11"    | -11"                    | 7'         | 12       | 2               |
| 15 | H10  | 6'        | 4'-6"                   | 7'-6"      | 12       | 2               |
| 16 | H11  | 2'-7"     | -7 <b>'</b> -5 <b>"</b> | 7'-10"     | 12       | 2               |
| 17 | H12  | 6'-6"     | -4'-4"                  | 7'-10"     | 12       | 2               |
| 18 | H13  | 7'-5"     | 2'-7"                   | 7'-10"     | 12       | 2               |
| 19 | H14  | 4'-4"     | 6'-6"                   | 7'-10"     | 12       | 2               |
| 20 | H15  | -5"       | -8'-3"                  | 8'-3"      | 12       | 2               |
| 21 | H16  | 1'-9"     | -8'-6"                  | 8'-8"      | 12       | 2               |
| 22 | H17  | 7'-10"    | 6'-1"                   | 9'-11"     | 12       | 2               |
| 23 | H18  | 10'-5"    | -1'-4"                  | 10'-6"     | 12       | 2               |
| 24 | H19  | 10'       | -4'-10"                 | 11'-1"     | 12       | 2               |
| 25 | H20  | 4'-10"    | 10'                     | 11'-1"     | 12       | 2               |
| 26 | H21  | 11'       | -3'-2"                  | 11'-6"     | 12       | 2               |
| 27 | H22  | 6'-7"     | -10'-8"                 | 12'-7"     | 12       | 2               |
| 28 | H23  | -10'-3"   | -7'-4"                  | 12'-7"     | 12       | 2               |
| 29 | H24  | 8'-3"     | 9'-6"                   | 12'-7"     | 12       | 2               |
| 30 | H25  | 8'-3"     | -10'-11"                | 13'-8"     | 12       | 2               |
| 31 | H26  | -12'      | -7'-4"                  | 14'-1"     | 12       | 2               |
| 32 | H27  | 5'-3"     | 13'-5"                  | 14'-5"     | 12       | 2               |
| 33 | H28  | -13'-9"   | -7'-4"                  | 15'-7"     | 12       | 2               |
| 34 | H29  | 8'-9"     | 13'                     | 15'-8"     | 12       | 2               |
| 35 | H30  | 12'-9"    | 9'-11"                  | 16'-2"     | 12       | 2               |
| 36 | H31  | 12'-11"   | 11'-5"                  | 17'-3"     | 12       | 2               |
| 37 | H32  | -10'-3"   | -14'-4"                 | 17'-7"     | 12       | 2               |
| 38 | H33  | 7'-10"    | 16'-4"                  | 18'-1"     | 12       | 2               |
| 39 | H34  | -12'      | -14'-4"                 | 18'-8"     | 12       | 2               |
| 40 | H35  | -13'-9"   | -14'-4"                 | 19'-10"    | 12       | 2               |
| 41 | H36  | 12'       | 17'-5"                  | 21'-2"     | 12       | 2               |
| 42 | H37  | 11'-5"    | 18'-11"                 | 22'-1"     | 12       | 2               |
| 43 | H38  | -23'-5"   | -1'-7"                  | 23'-6"     | 12       | 2               |
| 44 | H39  | -25'-11"  | 10"                     | 26'        | 12       | 2               |
| 45 | H40  | -28'-4"   | -1'-9"                  | 28'-5"     | 12       | 2               |
| 46 | H41  | -24'-6"   | -14'-8"                 | 28'-7"     | 12       | 2               |
| 47 | H42  | -30'-11"  | 8"                      | 30'-11"    | 12       | 2               |
| 48 | H43  | -30'-8"   | -11'-1"                 | 32'-7"     | 12       | 2               |
| 49 | l1   | 5"        | 11'-8"                  | 11'-8"     | 8        | 1               |
| 50 | 12   | 7"        | 12'-11"                 | 13'        | 8        | 1               |
|    |      |           | <del></del>             |            |          |                 |

# PLAN REFERENCE

BASE INFORMATION FROM PLAN ENTITLED: "GLASTONBURY EAST HARTFORD ELEMENTARY MAGNET SCHOOL, SITE LAYOUT PLAN", SCALE 1" = 40", DATED JULY 1, 2010, BY BLADES & GOVEN, THREE CORPORATE DRIVE, SUITE 502, SHELTON, CT 06494.

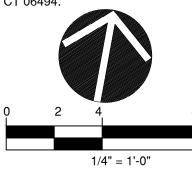

DESIGNILC
Sophisticated Site Design

Landscape Architecture
Civil Engineering

114 West Main Street, Suite 201 New Britain, CT 06051 P 860.612.1700 F 860.612.1757

www.todesignIlc.com

TOWN OF GLASTONBURY 2155 MAIN STREET

state PROJECT NO. 054-0095 MAG/N/PS 054-0096 MAG/N/PS Phase 4 of 4

> BID NO. 31 -2011-04-RP-120

GL-2011-04-BP-120

STONBURY
THARTFORD
TO MAGNET SCHOC

Sheet Description:

Footing Plan -Age 2 - 5


Dovu

Issue Date: SEPTEMBER 26, 2011

Scale: Drawn by: 1/4" = 1'-0" MWF

Project number: 5484-L

L-4<sub>-</sub>C

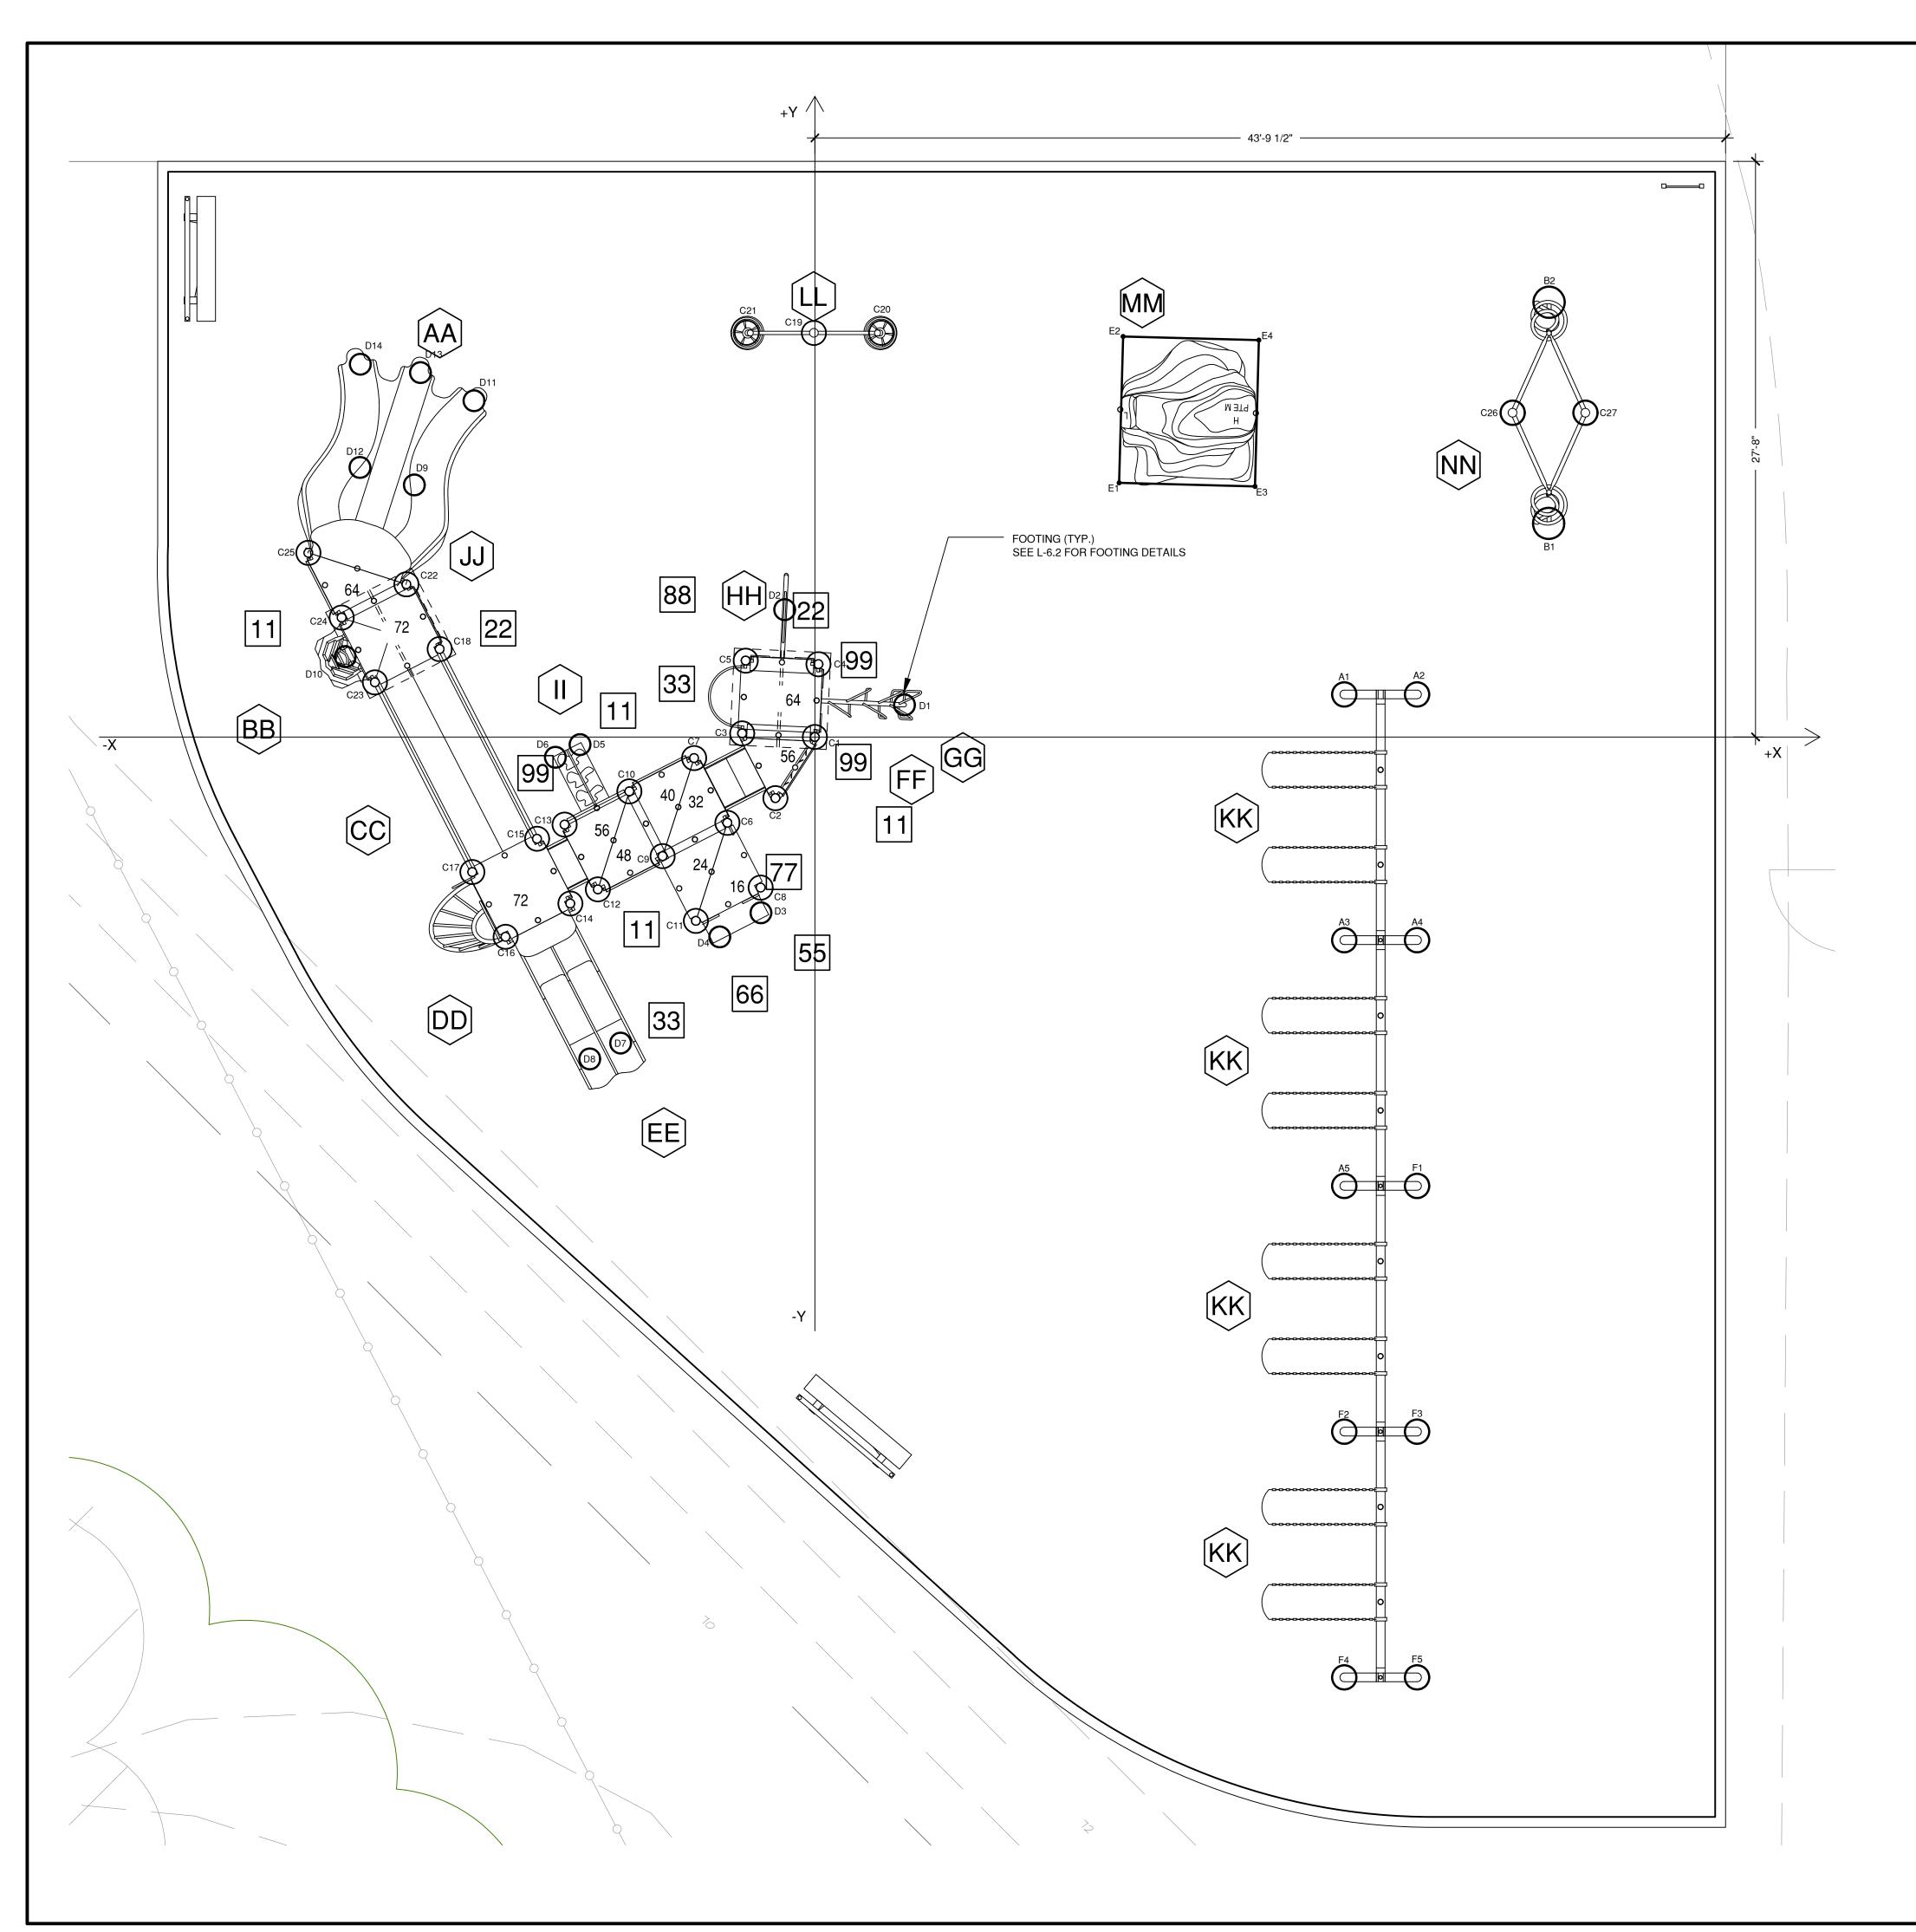

| GR/ | ADE 2-5 EQUIPMENT SCHEDULE  |
|-----|-----------------------------|
|     | TYPE OF<br>COMPONENT        |
| AA  | CLOUDBURST SLIDE            |
| BB  | SUMMIT CLIMBER              |
| СС  | ARCH BRIDGE W BARRIERS      |
| DD  | SUNBEAM CLIMBER             |
| EE  | DOUBLE POLY SWOOSH SLIDE    |
| FF  | PILOT PANEL                 |
| GG  | CROQUET CLIMBER             |
| НН  | LOGO CLIMBER                |
| II  | CLIFF CLIMBER               |
| JJ  | VERT. ASCENT                |
| KK  | SINGLE POST SWINGS - 4 BAYS |
| LL  | ORBITER-2                   |
| ММ  | THE POINTE                  |
| NN  | IND BLENDER DOUBLE          |
| 11  | 3X PIPE BARRIERS            |
| 22  | 2X SQUARE POLY ROOFS        |
| 33  | DECKLINK W BARRIERS         |
| 44  | NOT USED                    |
| 55  | 2X HANDLOOP ASSEMBLY        |
| 66  | TRANSFER STEP               |
| 77  | GRAB BAR                    |
| 88  | BALCONY DECK                |
| 99  | TENDER DECK                 |

# FOOTING CHART

| •  |      | • • • •                 | u Ui                      | 17 (1 (           | •        |                |
|----|------|-------------------------|---------------------------|-------------------|----------|----------------|
| N. | I.D. | X (ft-in)               | Y (ft-in)                 | Dist. to O        | DIA (in) | Detail on L-6. |
| 1  | A1   | 25'-5"                  | -9'-9"                    | 27'-3"            | 14       | 5              |
| 2  | A2   | 28'-11"                 | 2'-1"                     | 29'               | 14       | 5              |
| 3  | A3   | 25'-5"                  | -9'-9"                    | 27'-3"            | 14       | 5              |
| 4  | A4   | 28'-11"                 | _9 <b>'</b> -9"           | 33'-4"            | 14       | 5              |
|    | A5   | 25'-5"                  | -21'-7"                   | 33'-4"            | 14       | 5              |
| 6  | B1   | 35'-4"                  | 10'-3"                    | 36'-9"            | 18       | 6              |
| 7  | B2   | 35'-4"                  | 20'-11"                   | 41'               | 18       | 6              |
| 8  | C1   | 0"                      | 0"                        | 0"                | 14       | 3              |
| 9  | C2   | -1'-11"                 | -2'-11"                   | 3'-6"             | 14       | 3              |
| 10 | C3   | -3'-6"                  | 2"                        | 3'-6"             | 14       | 3              |
| 11 | C4   | 2"                      | 3'-6"                     | 3'-6"             | 14       | 3              |
| 12 | C5   | -3'-4"                  | 3'-8"                     | 4'-11"            | 14       | 3              |
| 13 | C6   | -4'-2"                  | -4'-2"                    | 5'-11"            | 14       | 3              |
| 14 | C7   | -5'-10"                 | -4-2                      | 5'-11"            | 14       |                |
|    | 1    |                         |                           |                   |          | 3              |
| 15 | C8   | -2'-7"                  | -7'-3"                    | 7'-8"             | 14       | 3              |
| 16 | C9   | -7 <b>'</b> -4 <b>"</b> | -5'-9"                    | 9'-4"             | 14       | 3              |
| 17 | C10  | -8'-11"                 | -2'-7"                    | 9'-4"             | 14       | 3              |
| 18 | C11  | -5'-9"                  | -8'-10"                   | 10'-6"            | 14       | 3              |
| 19 | C12  | -10'-5"                 | -7'-4"                    | 12'-9"            | 14       | 3              |
| 20 | C13  | -12'                    | -4'-3"                    | 12'-9"            | 14       | 3              |
| 21 | C14  | -11'-9"                 | -8'                       | 14'-3"            | 14       | 3              |
| 22 | C15  | -13'-4"                 | -4'-11"                   | 14'-3"            | 14       | 3              |
| 23 | C16  | -14'-10"                | -9'-7"                    | 17'-8"            | 14       | 3              |
| 24 | C17  | -16'-6"                 | -6'-6"                    | 17'-8"            | 14       | 3              |
| 25 | C18  | -18'                    | 4'-3"                     | 18'-6"            | 14       | 3              |
| 26 | C19  | -1"                     | 19'-5"                    | 19'-5"            | 14       | 5              |
| 27 | C20  | 3'-2"                   | 19'-5"                    | 19'-8"            | 14       | 7              |
| 28 | C21  | -3'-3"                  | 19'-5"                    | 19'-8"            | 14       | 7              |
| 29 | C22  | -19'-8"                 | 7'-4"                     | 21'               | 14       | 3              |
| 30 | C23  | -21'-2"                 | 2'-7"                     | 21'-4"            | 14       | 3              |
| 31 | C24  | -22'-9"                 | 5'-9"                     | 23'-6"            | 14       | 3              |
| 32 | C25  | -24'-4"                 | 8'-10"                    | 25'-11"           | 14       | 3              |
| 33 | C26  | 33'-7"                  | 15'-7"                    | 37'               | 14       | 3              |
| 34 | C27  | 37'-1"                  | 15'-7"                    | 40'-2"            | 14       | 3              |
| 35 | D1   | 4'-4"                   | 1'-6"                     | 4'-7"             | 12       | 2              |
| 36 | D2   | -1'-5"                  | 6'-1"                     | 6'-3"             | 12       | 2              |
| 37 | D3   | -2'-7"                  | -8'-5"                    | 8'-10"            | 12       | 1              |
| 38 | D4   | -4'-7"                  | -9'-7"                    | 10'-8"            | 12       | 1              |
| 39 | D5   | -11'-3"                 | -4"                       | 11'-4"            | 12       | 1              |
| 40 | D6   | -12'-6"                 | -1'                       | 12'-6"            | 12       | 1              |
| 41 | D7   | -9'-4"                  | -14'-9"                   | 17'-5"            | 12       | 2              |
| 42 | D8   | -10'-10"                | -15'-6"                   | 18'-11"           | 12       | 2              |
| 43 | D9   | -19'-3"                 | 12'-1"                    | 22'-9"            | 12       | 2              |
| 44 | D10  | -22'-7"                 | 3'-10"                    | 22'-11"           | 12       | 2              |
| 45 | D10  | -16'-5"                 | 16'-2"                    | 23'               | 12       | 2              |
| 46 | D12  | -21'-10"                | 12'-11"                   | 25'-5"            | 12       | 2              |
| 47 | D12  |                         |                           |                   |          | 2              |
|    | _    | -19'<br>-21'-10"        | 17'-6"<br>17 <b>'-11"</b> | 25'-10"<br>28'-3" | 12<br>12 |                |
| 48 | D14  |                         |                           |                   |          | 2              |
| 49 | E1   | 14'-8"                  | 12'-3"                    | 19'-1"            | TRENCH   | 8              |
| 50 | E2   | 14'-10"                 | 19'-3"                    | 24'-4"            | TRENCH   | 8              |


|    |      |           |           |            | -        |                |
|----|------|-----------|-----------|------------|----------|----------------|
| N. | I.D. | X (ft-in) | Y (ft-in) | Dist. to O | DIA (in) | Detail on L-6. |
| 51 | E3   | 21'-2"    | 12'-1"    | 24'-4"     | TRENCH   | 8              |
| 52 | E4   | 21'-4"    | 19'–1"    | 28'-8"     | TRENCH   | 8              |
| 53 | F1   | 28'-11"   | -21'-7"   | 36'-1"     | 14       | 5              |
| 54 | F2   | 37'-1"    | 15'-7"    | 40'-2"     | 14       | 5              |
| 55 | F3   | 28'-11"   | -33'-5"   | 44'-2"     | 14       | 5              |
| 56 | F4   | 25'-5"    | -45'-2"   | 51'-11"    | 14       | 5              |
| 57 | F5   | 28'-11"   | -45'-2"   | 53'-8"     | 14       | 5              |

# NOTES:

- SEE PRODUCT CUT SHEETS FOR PRECISE DIMENSIONS.
   SEE DRAWING L-2.1 FOR EQUIPMENT & MATERIALS INFORMATION.
   ALL EQUIPMENT SHOULD USE CONCRETE FOOTING INSTALLATION. DO NOT USE SURFACE MOUNT INSTALLATION.
   SEE L-6.2 FOR SPECIFIC CONCRETE FOOTING.
   ALL FOOTINGS TO BE A MIN. DEPTH OF 42".

## PLAN REFERENCE

BASE INFORMATION FROM PLAN ENTITLED: "GLASTONBURY EAST HARTFORD ELEMENTARY MAGNET SCHOOL, SITE LAYOUT PLAN", SCALE 1" = 40", DATED JULY 1, 2010, BY BLADES & GOVEN, THREE CORPORATE DRIVE, SUITE 502, SHELTON, CT 06494.

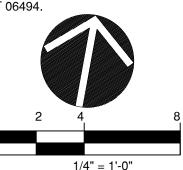

Landscape Architecture Civil Engineering

114 West Main Street, Suite 201 New Britain, CT 06051 P 860.612.1700 F 860.612.1757

www.todesignIlc.com

TOWN OF GLASTONBURY 2155 MAIN STREET

STATE PROJECT NO. 054-0095 MAG/N/PS 054-0096 MAG/N/PS Phase 4 of 4

GL-2011-04-BP-120


Sheet Description:

Footing Plan - Age 5 - 12

SEPTEMBER 26, 2011

Drawn by: 1/4" = 1'-0"

Project number:

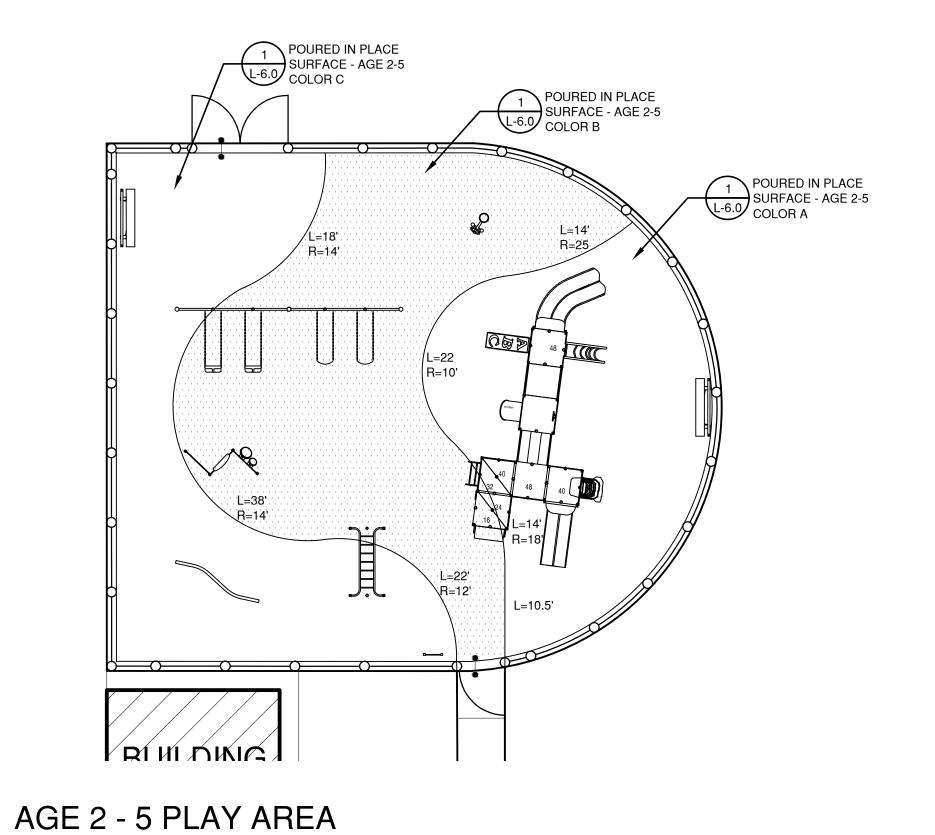

TOTAL AREA OF PLAYGROUND

2,986 SF

POURED IN PLACE
SURFACE - AGE 5-12

L-6

L-1

R-14

R-29

L-12

R-17

L-17


L-

AGE 5 - 12 PLAY AREA

TOTAL AREA OF PLAYGROUND

# PLAN REFERENCE

BASE INFORMATION FROM PLAN ENTITLED: "GLASTONBURY EAST HARTFORD ELEMENTARY MAGNET SCHOOL, SITE LAYOUT PLAN", SCALE 1" = 40", DATED JULY 1, 2010, BY BLADES & GOVEN, THREE CORPORATE DRIVE, SUITE 502, SHELTON, CT 06494.

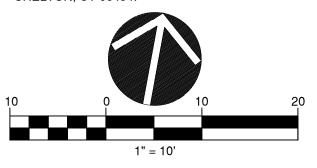

esional Soal

DESIGNLLC

Sophisticated Site Design

Landscape Architecture

Civil Engineering

114 West Main Street, Suite 201 New Britain, CT 06051 P 860.612.1700 F 860.612.1757

www.todesignIlc.com

Prepared For:

TOWN OF GLASTONBURY 2155 MAIN STREET

state PROJECT NO. 054-0095 MAG/N/PS 054-0096 MAG/N/PS Phase 4 of 4

BID NO. GL-2011-04-BP-120

> BURY FFORD SNET SCHOOL GLASTONBURY, CT

GLASTONBU EAST HARTFC EMENTARY MAGNE

Sheet Description:

Surfacing Plans

Rev:


Issue Date: SEPTEMBER 26, 2011

Scale: Drawn by:


Project number:

5484-L


L-5.0

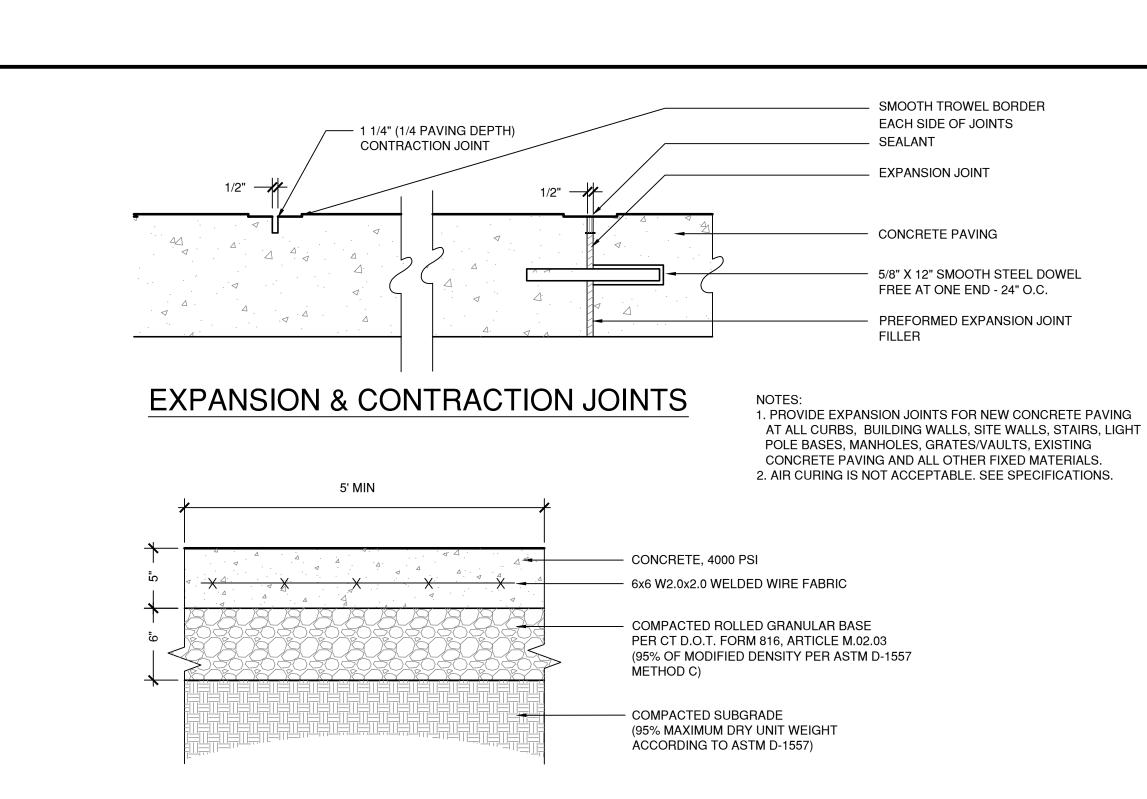



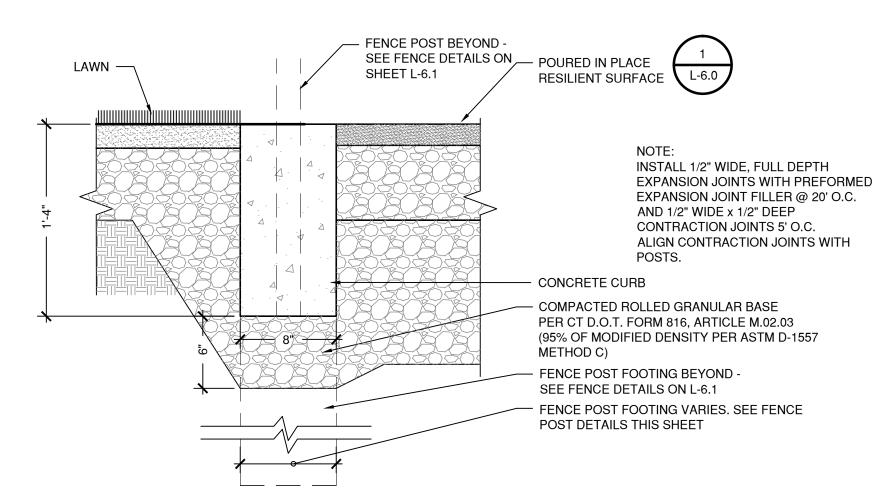

CONCRETE CURB AT FENCE LINE

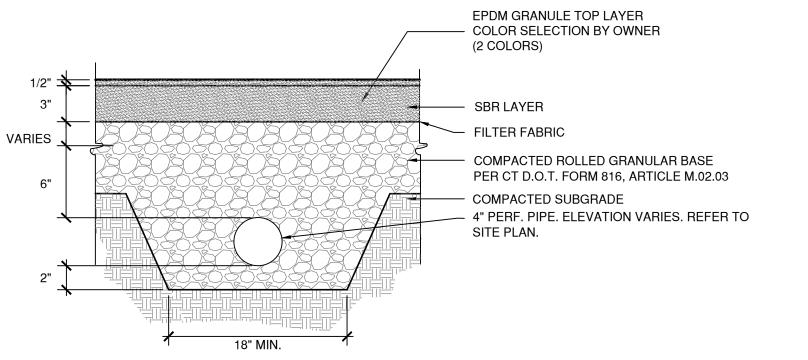


ARTICLE M.02.03:

THE MATERIALS FOR THE "ROLLED GRANULAR BASE" SHALL CONSIST OF SOUND, TOUGH, DURABLE PARTICLES OF BANK OR CRUSHED GRAVEL, OR RECLAIMED MISCELLANEOUS AGGREGATE, OR MIXTURES THEREOF WITH THE RESULTANT UNIFORM BLEND CONTAINING NO MORE THAN 2% BY WEIGHT (MASS) OF ASPHALT CEMENT. ALL MATERIALS SHALL

BE FREE FROM THIN OR ELONGATED PIECES, LUMPS

OF CLAY, LOAM, OR VEGETABLE MATTER.

POURED IN PLACE RESILIENT SURFACE - Age 2-5 and 5-12

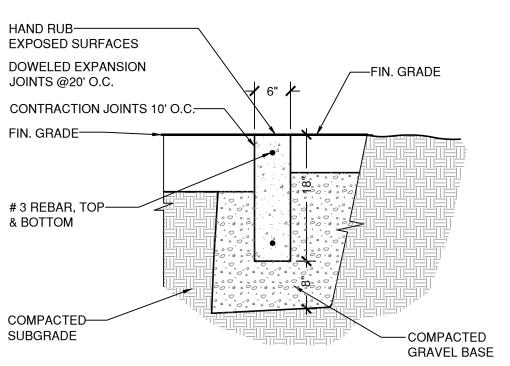

FLUSH CURB

Sophisticated Site Design Landscape Architecture Civil Engineering

114 West Main Street, Suite 201 New Britain, CT 06051 P 860.612.1700 F 860.612.1757

www.todesignllc.com Prepared For:

TOWN OF GLASTONBURY 2155 MAIN STREET

STATE PROJECT NO. 054-0095 MAG/N/PS 054-0096 MAG/N/PS Phase 4 of 4

BID NO. GL-2011-04-BP-120

BURY TFORI <u>U</u>

Sheet Description:


Playground **Details** 


Issue Date: SEPTEMBER 26, 2011


Drawn by: AS NOTED MWF

Project number: 5484-L

Sheet #: L-6.0

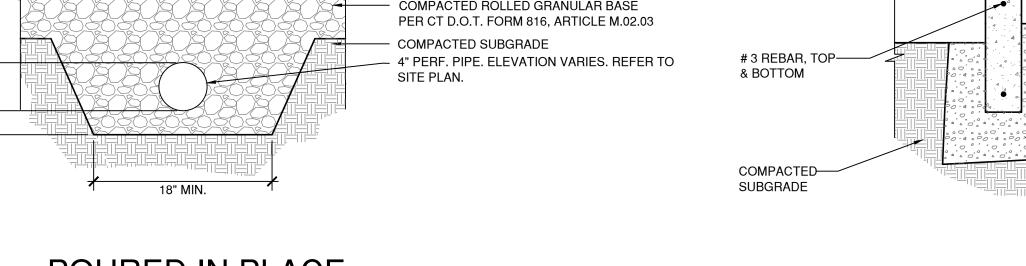

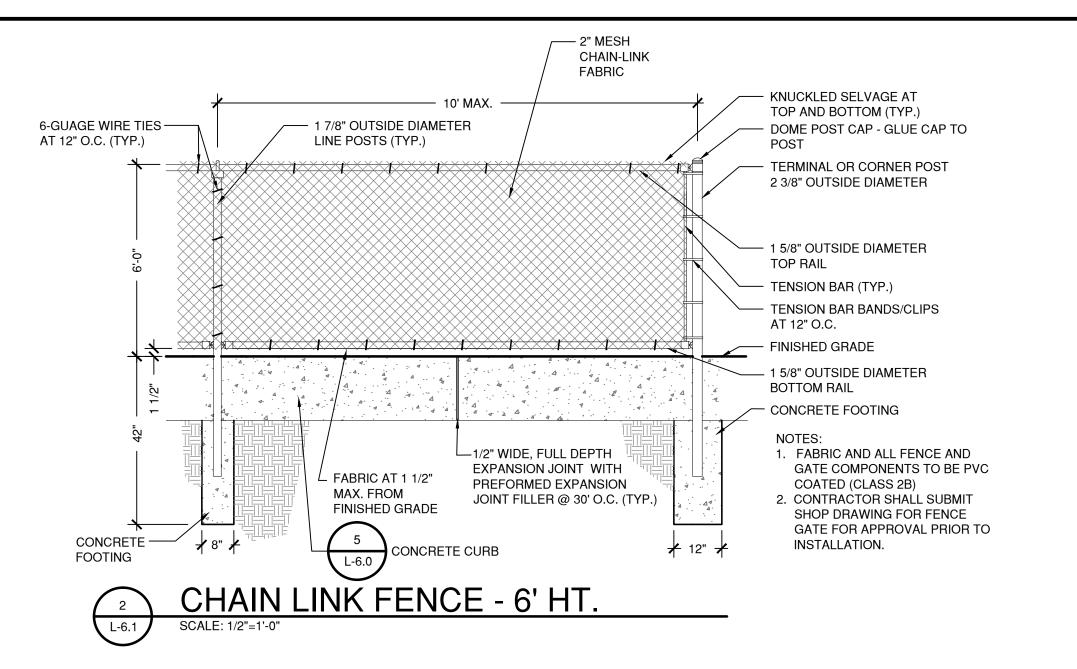

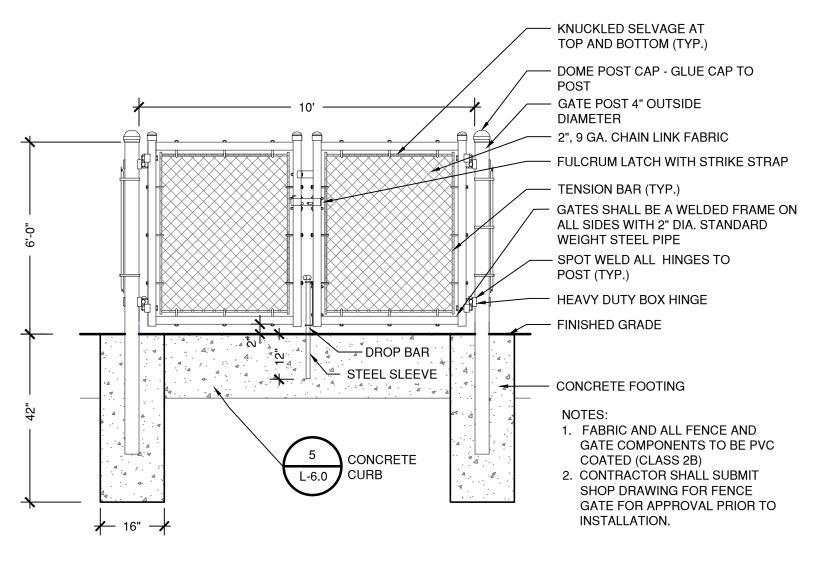





WELCOME

THIS PLAY AREA
HAS BEEN DESIGNED
FOR CHILDREN 5-12
YEARS OF AGE.
ADULT SUPERVISION
IS RECOMMENDED.

PLAY IT SAFE



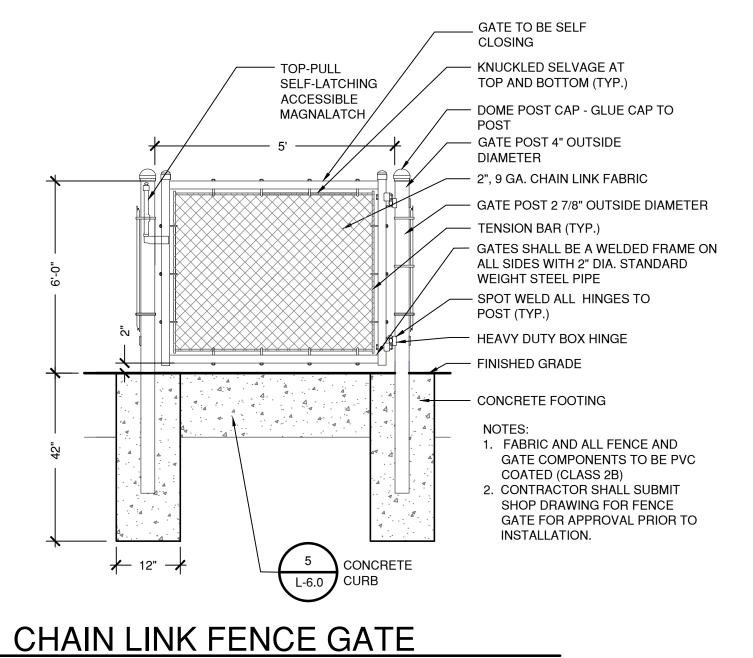


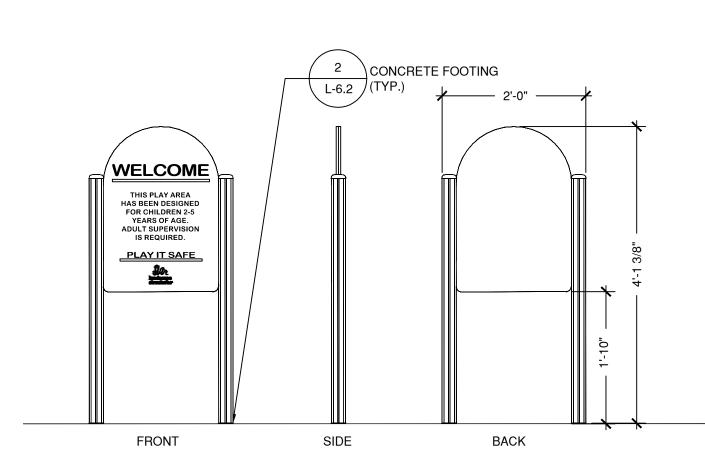

2 CONCRETE FOOTING

BACK

L-6.2 /(TYP.)

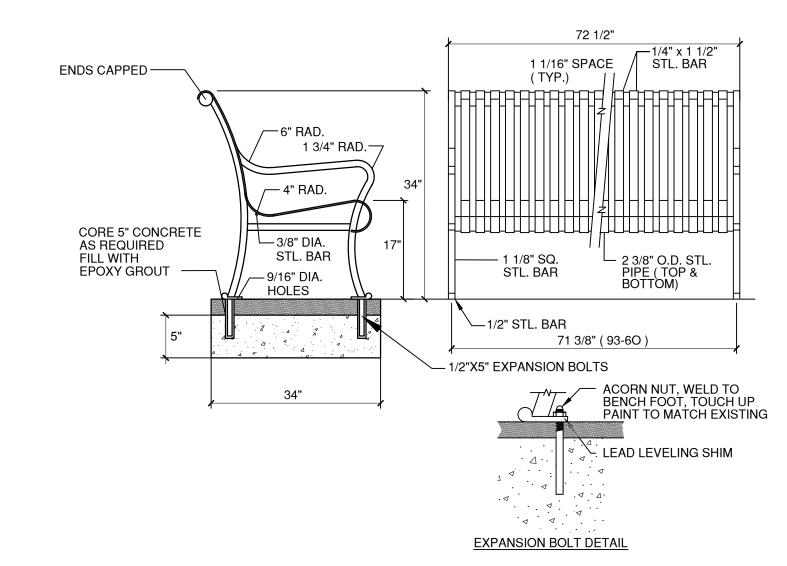

MODEL 93-60 BY DUMOR INC.

BENCH

NOT TO SCALE

SIGN - AGE 2-5
SCALE 3/4"=1'-0"

Sophisticated Site Design Landscape Architecture Civil Engineering

114 West Main Street, Suite 201 New Britain, CT 06051 P 860.612.1700 F 860.612.1757

Prepared For:

www.todesignllc.com

TOWN OF **GLASTONBURY** 2155 MAIN STREET

STATE PROJECT NO. 054-0095 MAG/N/PS 054-0096 MAG/N/PS Phase 4 of 4

BID NO. GL-2011-04-BP-120

BUR TFOF

Sheet Description:

Playground **Details** 

Issue Date: SEPTEMBER 26, 2011


Drawn by: AS NOTED


Project number: 5484-L


Sheet #:


L-6.1


MWF

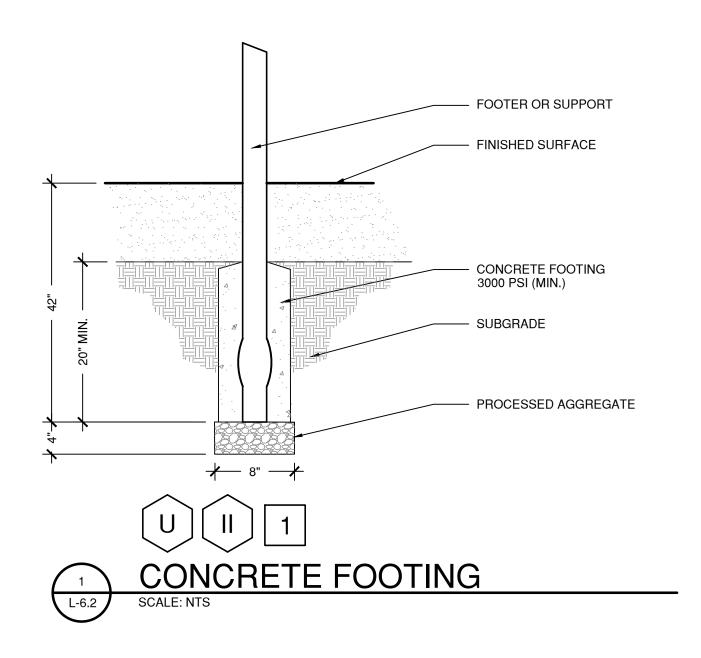

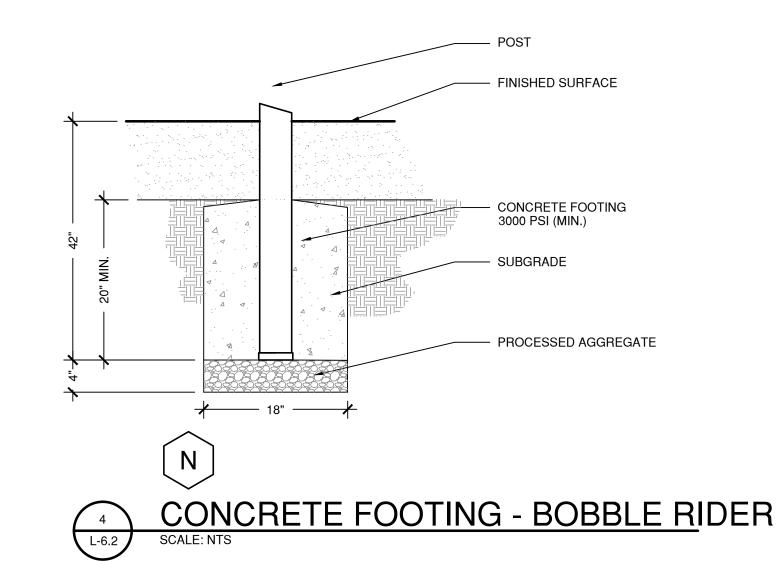

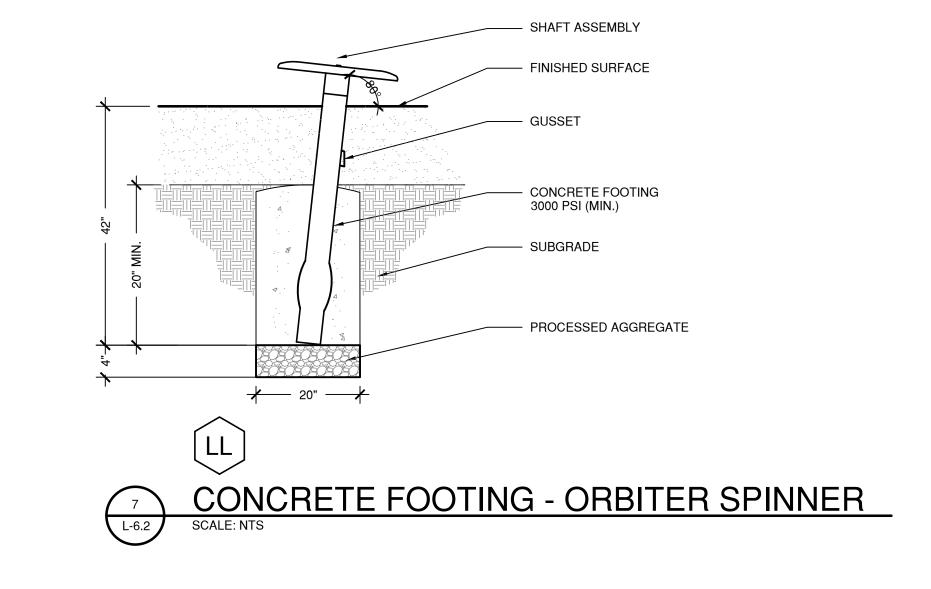


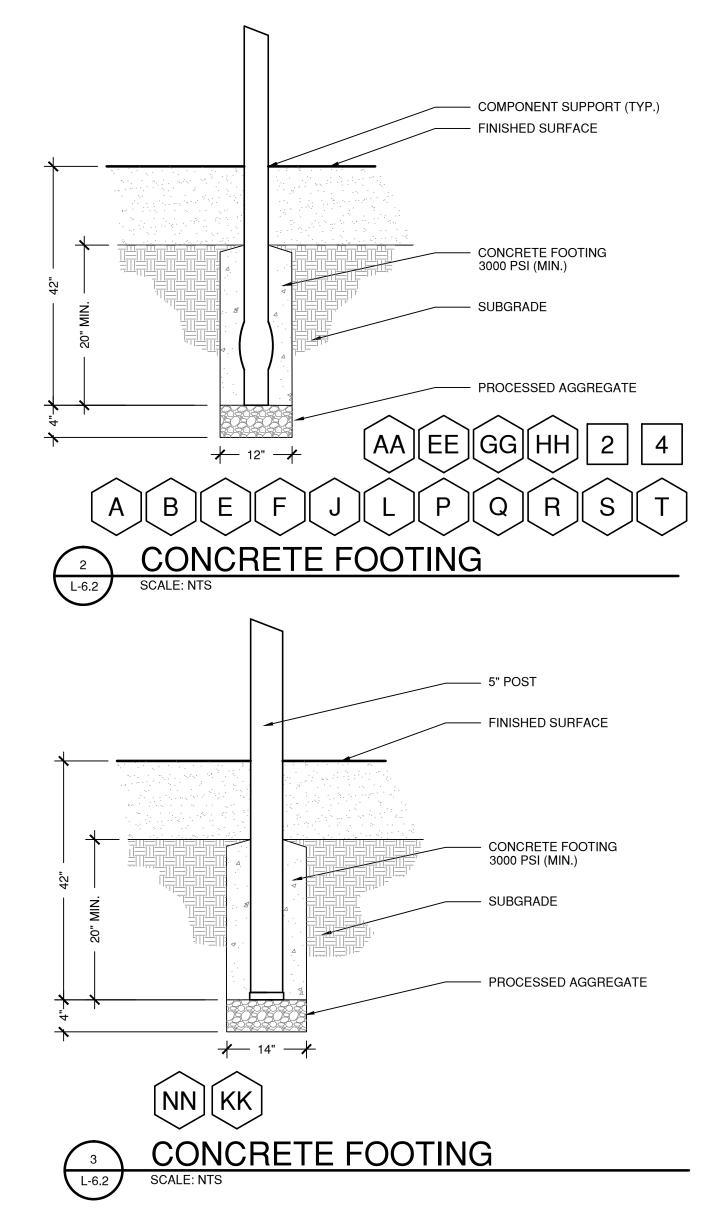

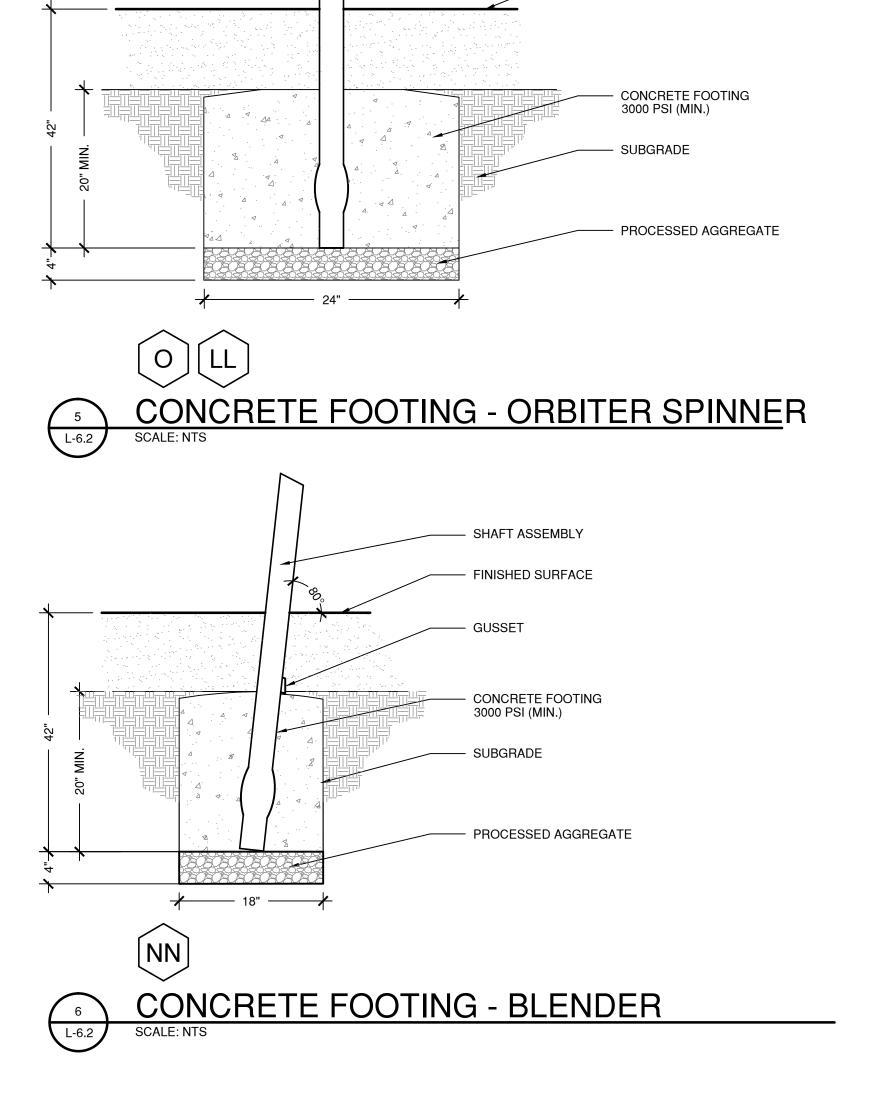

- COMPONENT SUPPORT (TYP.)

- FINISHED SURFACE

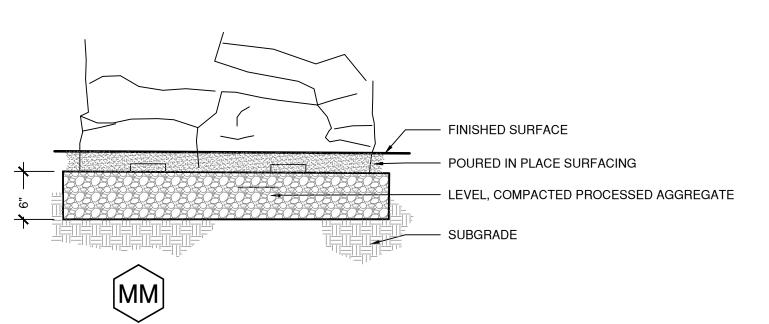

SUBGRADE

MM

FOOTING - THE POINTE

SCALE: NTS

Sheet Description:

Playground Details

Rev:

SEPTEMBER 26, 2011

Scale: SEPTEMBER 26, 2011

Scale: MWF

Project number: 5484-L

Sheet #:

L-6.2

Landscape Architecture
Civil Engineering

114 West Main Street, Suite 201 New Britain, CT 06051 P 860.612.1700 F 860.612.1757

www.todesignllc.com


TOWN OF GLASTONBURY 2155 MAIN STREET

STATE PROJECT NO. 054-0095 MAG/N/PS

054-0096 MAG/N/PS Phase 4 of 4

BID NO. GL-2011-04-BP-120

Duefe esianal Ca

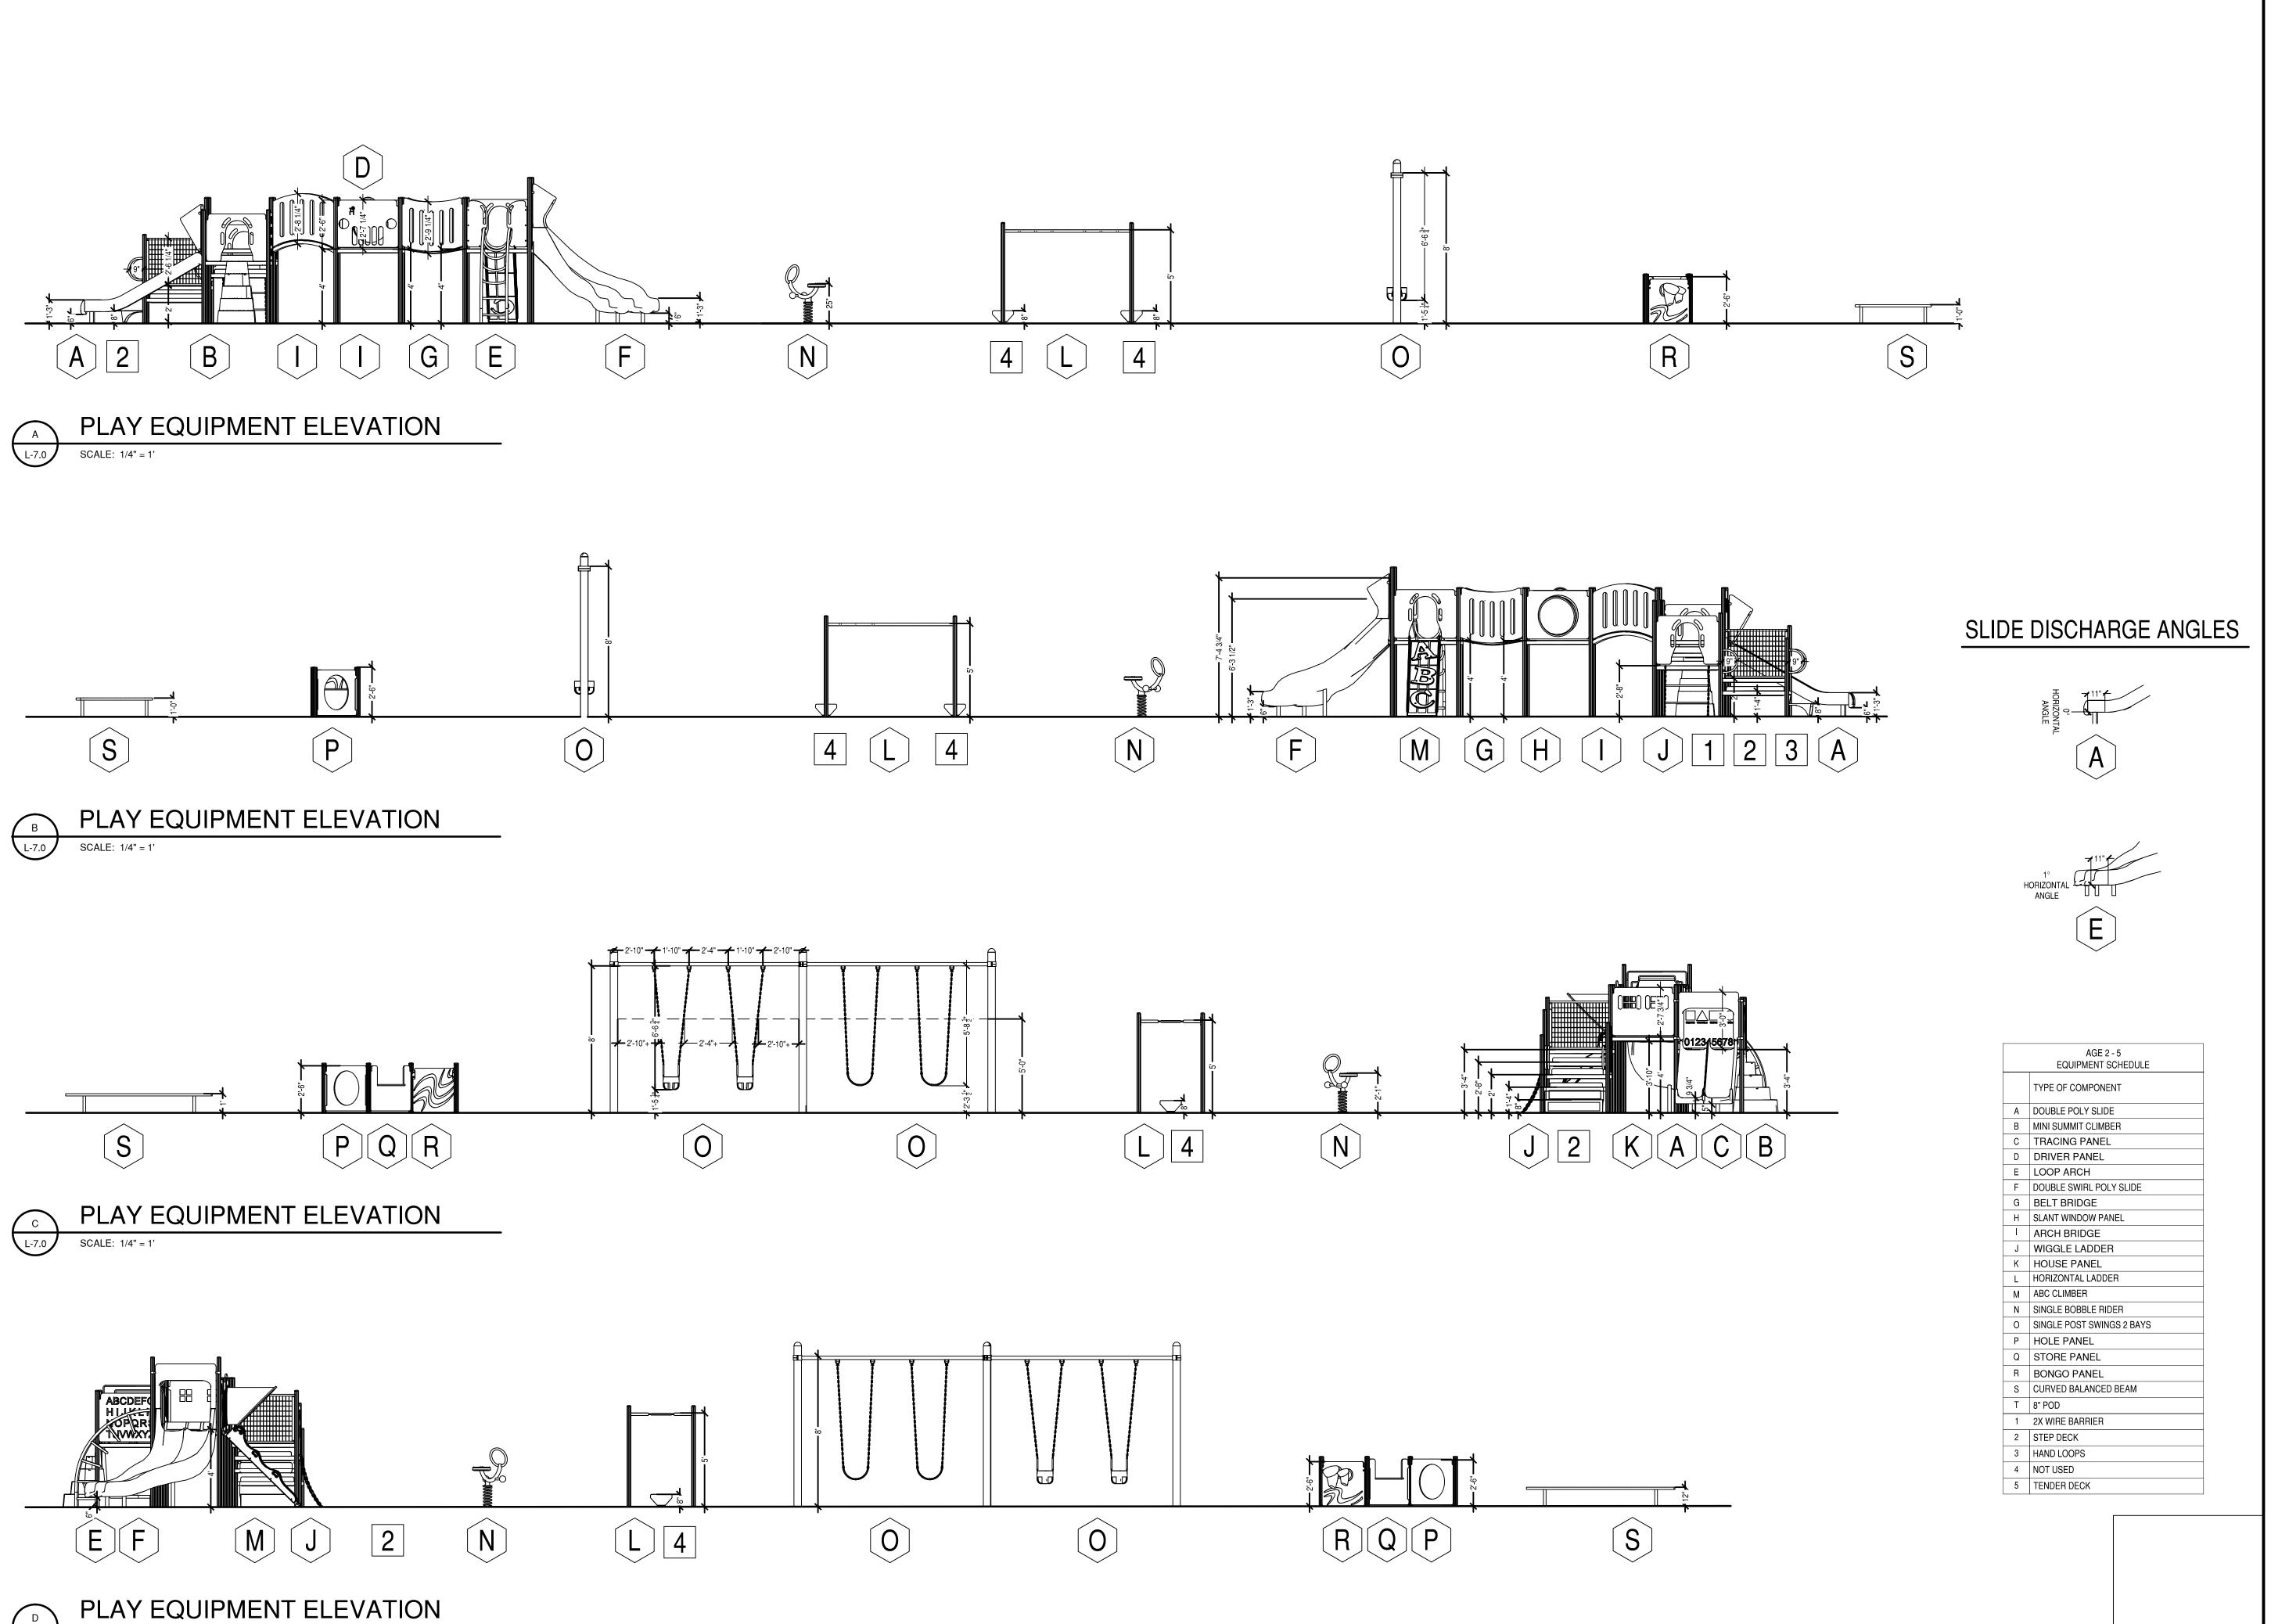

SCALE: 1/4" = 1'

DESIGNLLC

Landscape Architecture
Civil Engineering

4 West Main Street, Suite 2 New Britain, CT 06051 P 860.612.1700 F 860.612.1757

www.todesignIlc.com

TOWN OF GLASTONBURY 2155 MAIN STREET

state PROJECT NO. 054-0095 MAG/N/PS 054-0096 MAG/N/PS Phase 4 of 4

BID NO. GL-2011-04-BP-120

700

TONBURY HARTFORD MAGNET SCHO

> EAST ELEMENTARY

Sheet Description:

Elevations -Age 2 - 5


Dov.

ssue Date: SEPTEMBER 26, 2011

Scale: Drawn by: MWF

Project number: 5484-L

L-7.0

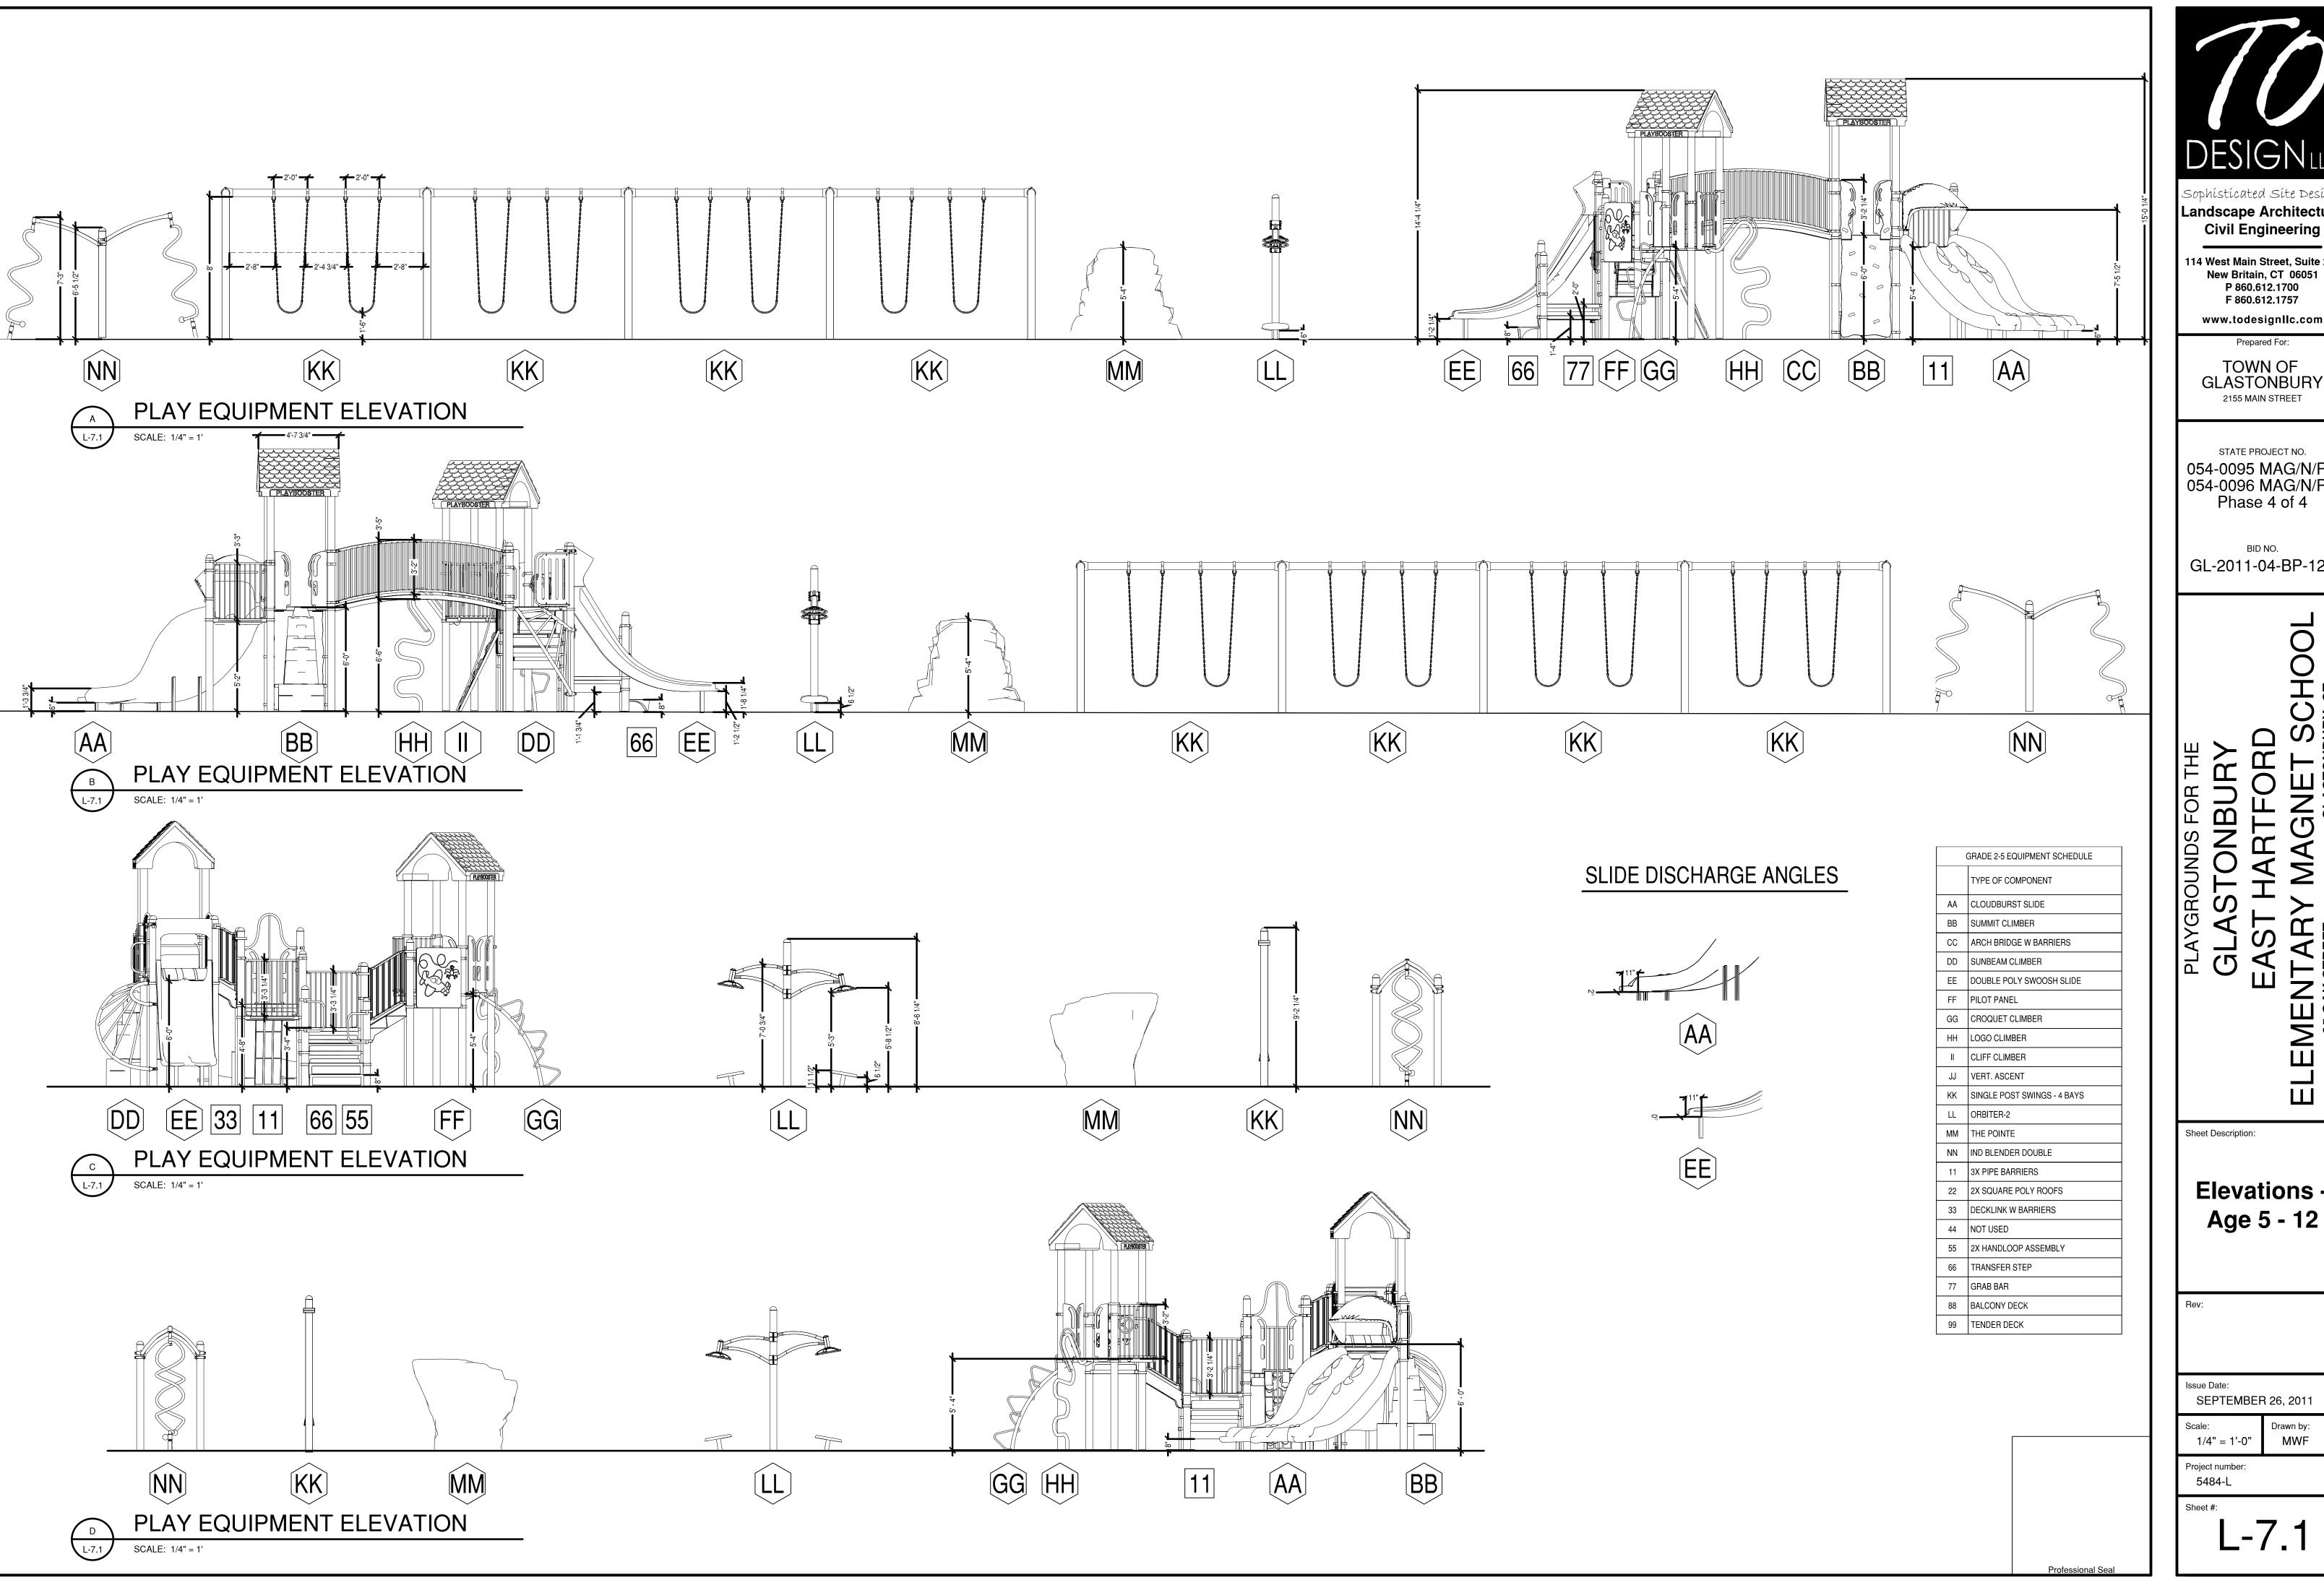

**Landscape Architecture Civil Engineering** 

14 West Main Street, Suite 201 New Britain, CT 06051 P 860.612.1700 F 860.612.1757

TOWN OF GLASTONBURY 2155 MAIN STREET

STATE PROJECT NO. 054-0095 MAG/N/PS 054-0096 MAG/N/PS Phase 4 of 4

BID NO.

GL-2011-04-BP-120


Elevations -Age 5 - 12


SEPTEMBER 26, 2011

Drawn by: 1/4" = 1'-0"

Project number:

L-7.1

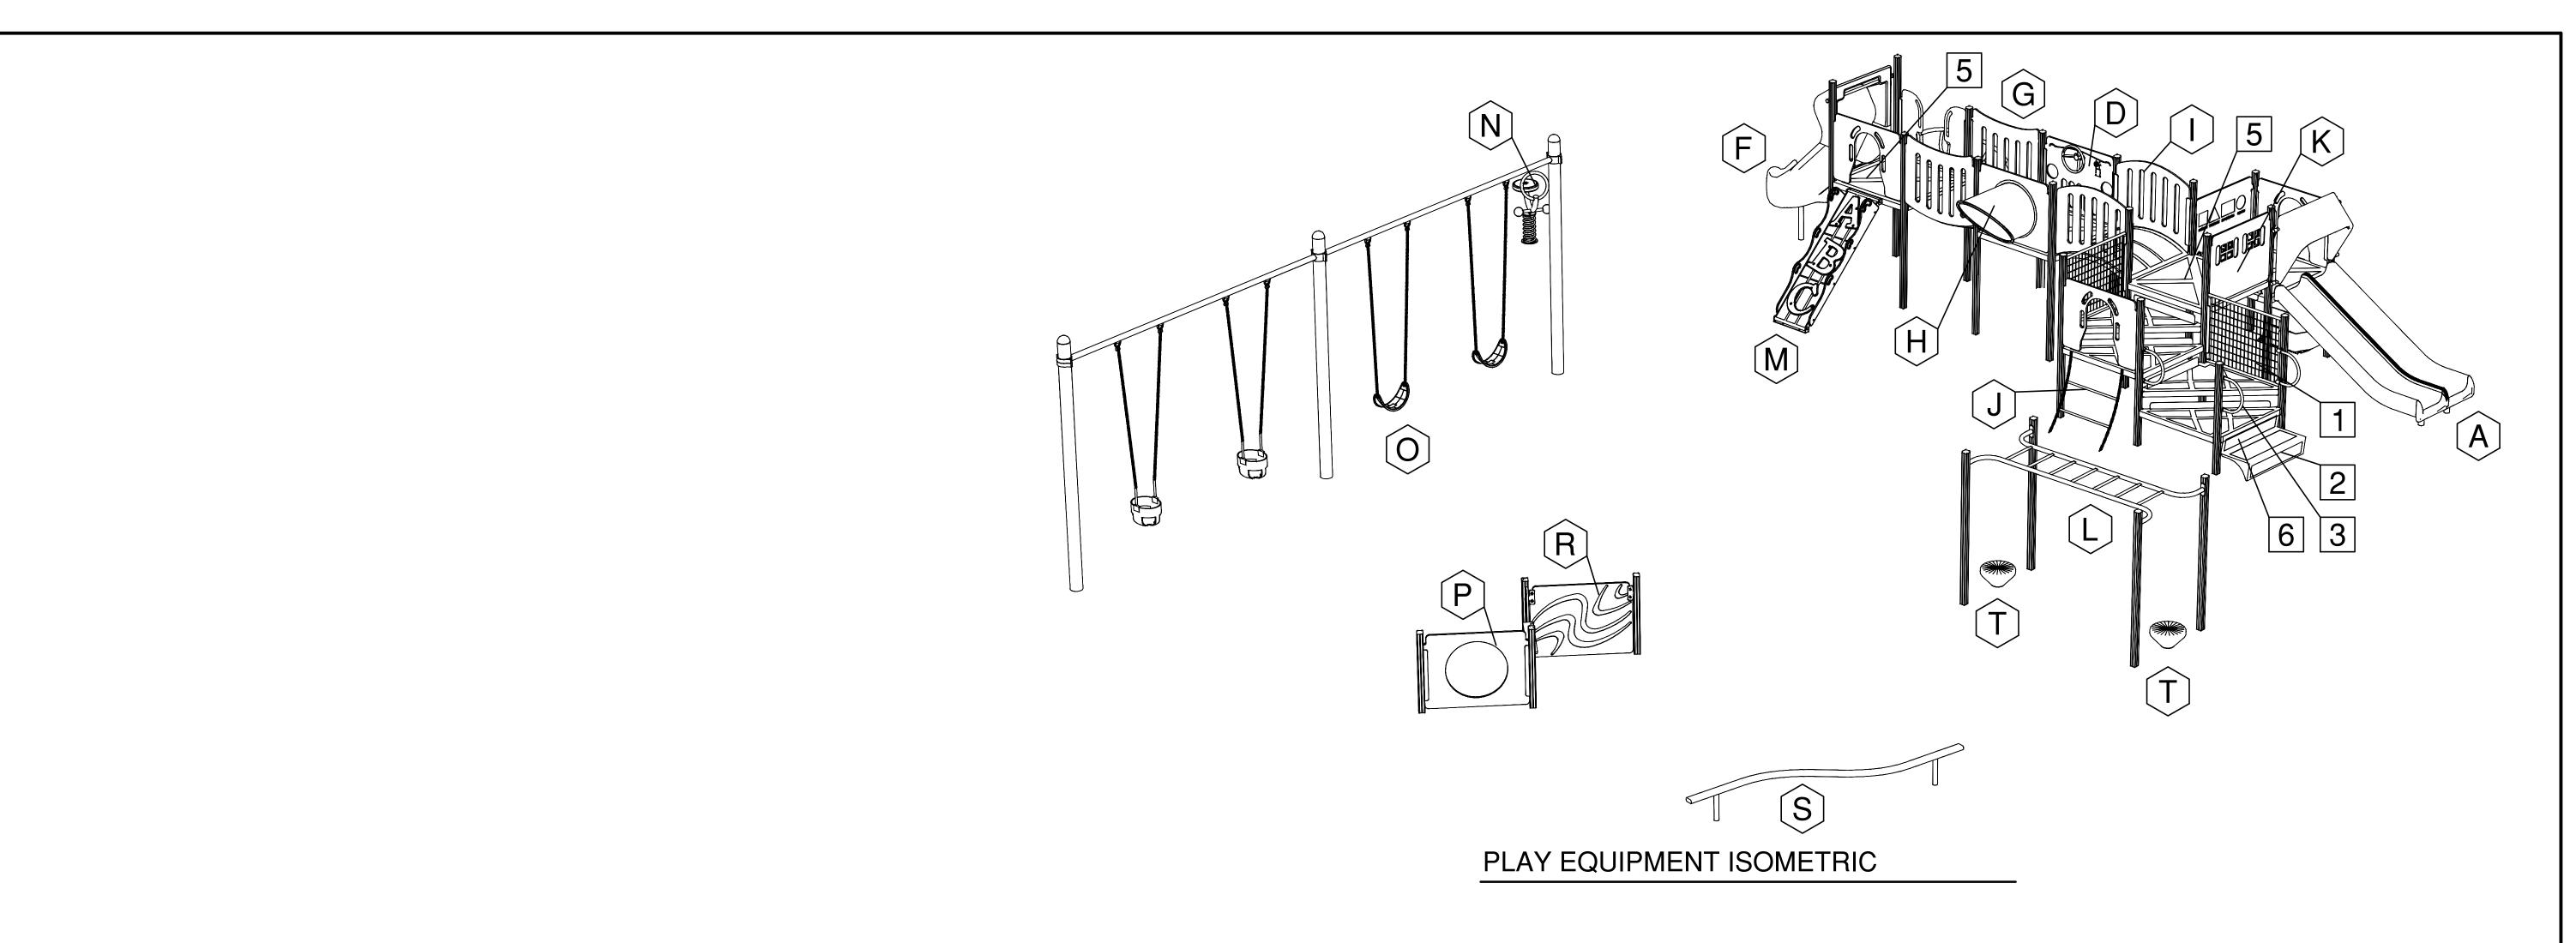

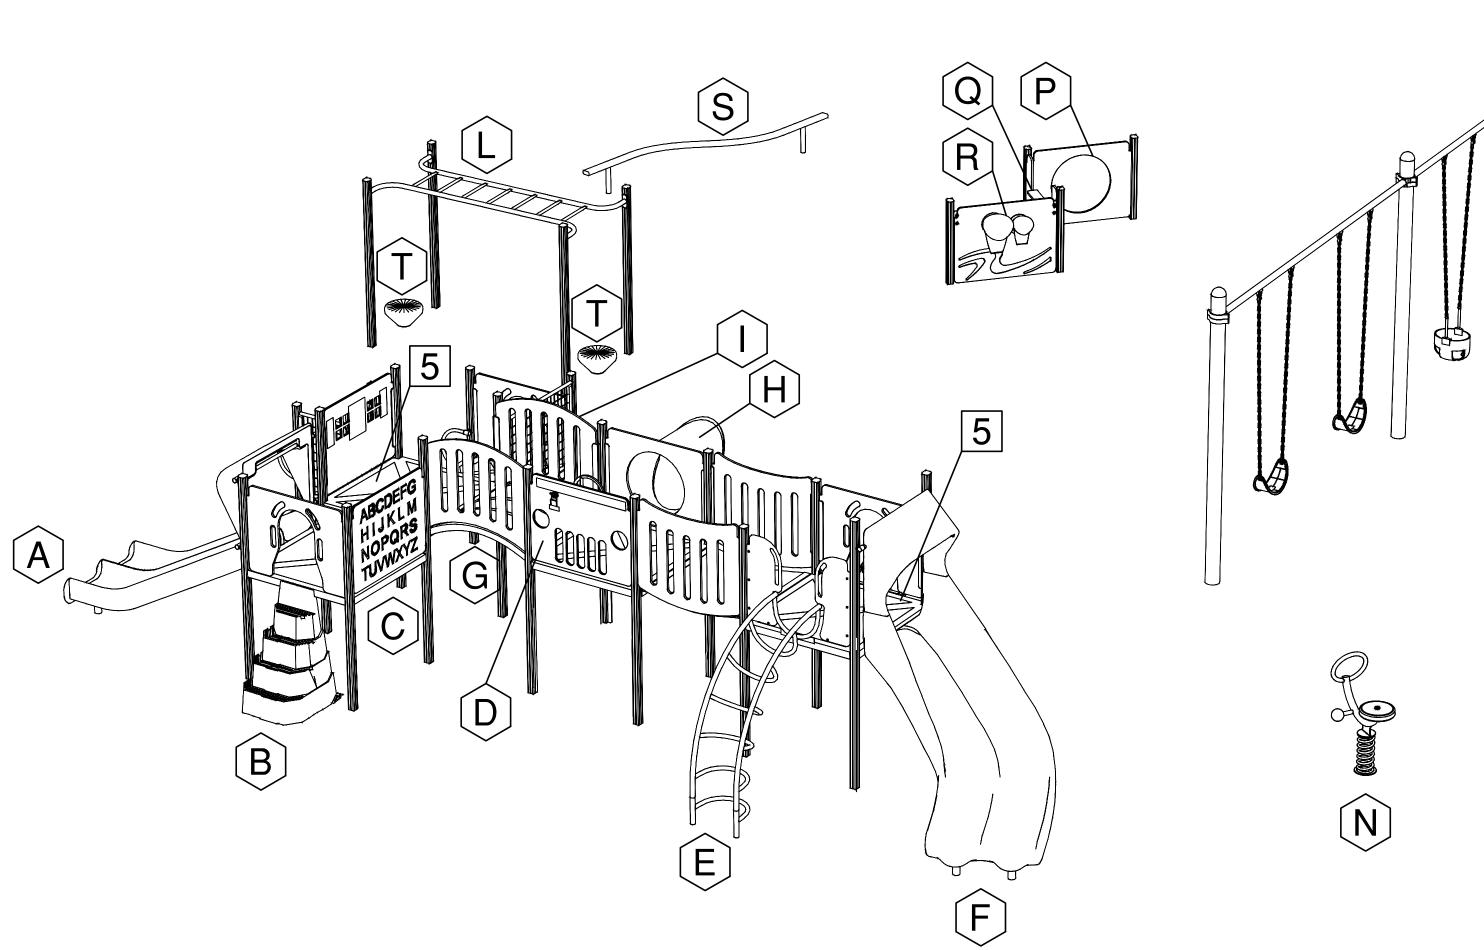

PLAY EQUIPMENT REVERSE ISOMETRIC

|   | AGE 2 - 5<br>EQUIPMENT SCHEDULE |
|---|---------------------------------|
|   | TYPE OF COMPONENT               |
| Α | DOUBLE POLY SLIDE               |
| В | MINI SUMMIT CLIMBER             |
| С | TRACING PANEL                   |
| D | DRIVER PANEL                    |
| E | LOOP ARCH                       |
| F | DOUBLE SWIRL POLY SLIDE         |
| G | BELT BRIDGE                     |
| Н | SLANT WINDOW PANEL              |
| 1 | ARCH BRIDGE                     |
| J | WIGGLE LADDER                   |
| K | HOUSE PANEL                     |
| L | HORIZONTAL LADDER               |
| М | ABC CLIMBER                     |
| N | SINGLE BOBBLE RIDER             |
| 0 | SINGLE POST SWINGS 2 BAYS       |
| Р | HOLE PANEL                      |
| Q | STORE PANEL                     |
| R | BONGO PANEL                     |
| S | CURVED BALANCED BEAM            |
| Т | 8" POD                          |
| 1 | 2X WIRE BARRIER                 |
| 2 | STEP DECK                       |
| 3 | HAND LOOPS                      |
| 4 | NOT USED                        |
| 5 | TENDER DECK                     |

Landscape Architecture **Civil Engineering** 

114 West Main Street, Suite 201 New Britain, CT 06051 P 860.612.1700 F 860.612.1757 www.todesignIlc.com

TOWN OF GLASTONBURY 2155 MAIN STREET

STATE PROJECT NO. 054-0095 MAG/N/PS 054-0096 MAG/N/PS Phase 4 of 4


GL-2011-04-BP-120


Sheet Description:

Isometric -Age 2 - 5

SEPTEMBER 26, 2011

L-8.0

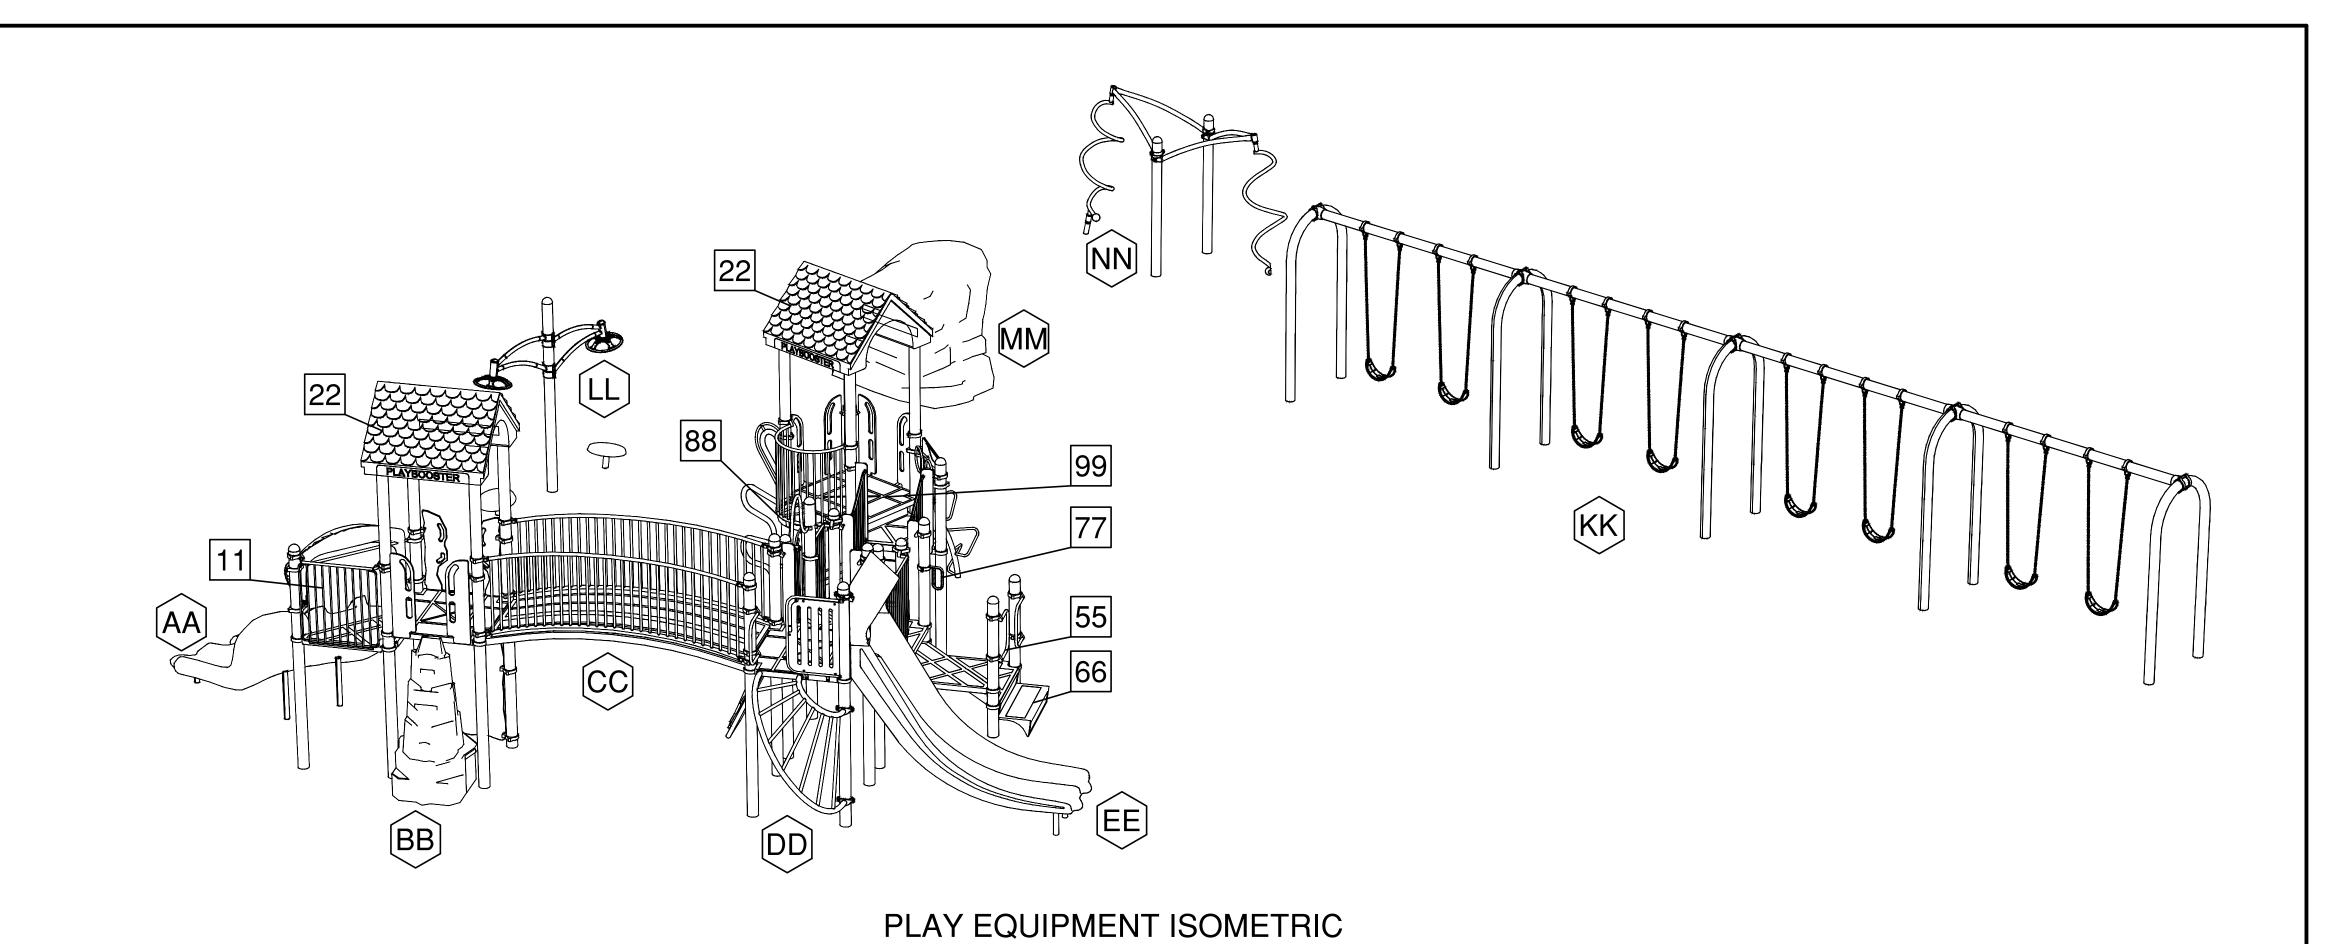

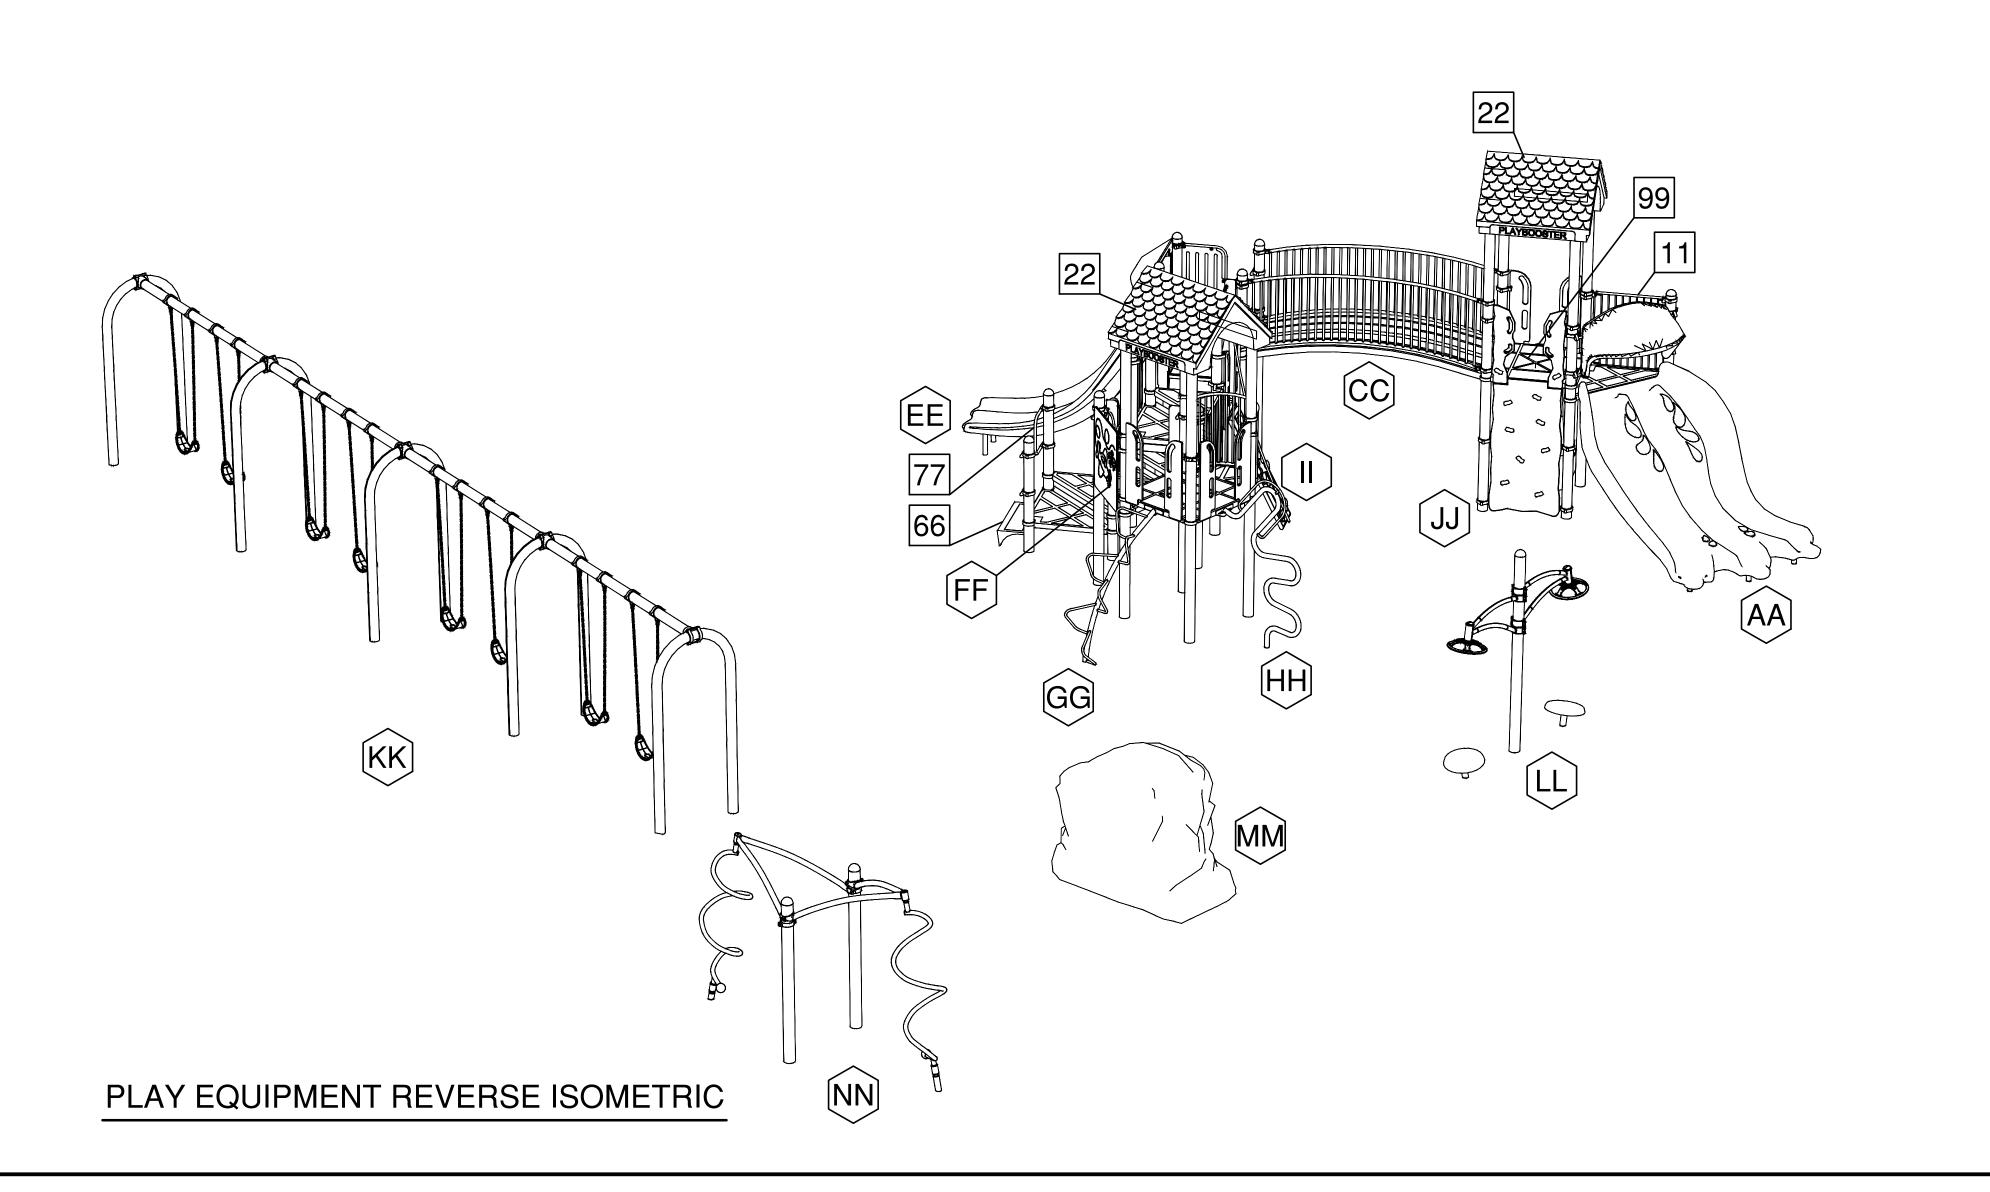

|    | TYPE OF COMPONENT           |
|----|-----------------------------|
| AA | CLOUDBURST SLIDE            |
| BB | SUMMIT CLIMBER              |
| СС | ARCH BRIDGE W BARRIERS      |
| DD | SUNBEAM CLIMBER             |
| EE | DOUBLE POLY SWOOSH SLIDE    |
| FF | PILOT PANEL                 |
| GG | CROQUET CLIMBER             |
| НН | LOGO CLIMBER                |
| II | CLIFF CLIMBER               |
| JJ | VERT. ASCENT                |
| KK | SINGLE POST SWINGS - 4 BAYS |
| LL | ORBITER-2                   |
| MM | THE POINTE                  |
| NN | IND BLENDER DOUBLE          |
| 11 | 3X PIPE BARRIERS            |
| 22 | 2X SQUARE POLY ROOFS        |
| 33 | DECKLINK W BARRIERS         |
| 44 | NOT USED                    |
| 55 | 2X HANDLOOP ASSEMBLY        |
| 66 | TRANSFER STEP               |
| 77 | GRAB BAR                    |
| 88 | BALCONY DECK                |
| 99 | TENDER DECK                 |

Landscape Architecture

114 West Main Street, Suite 201 New Britain, CT 06051 P 860.612.1700 F 860.612.1757 www.todesignIlc.com


TOWN OF GLASTONBURY 2155 MAIN STREET

STATE PROJECT NO. 054-0095 MAG/N/PS 054-0096 MAG/N/PS Phase 4 of 4

GL-2011-04-BP-120

Isometric -Age 5 - 12

L-8.1

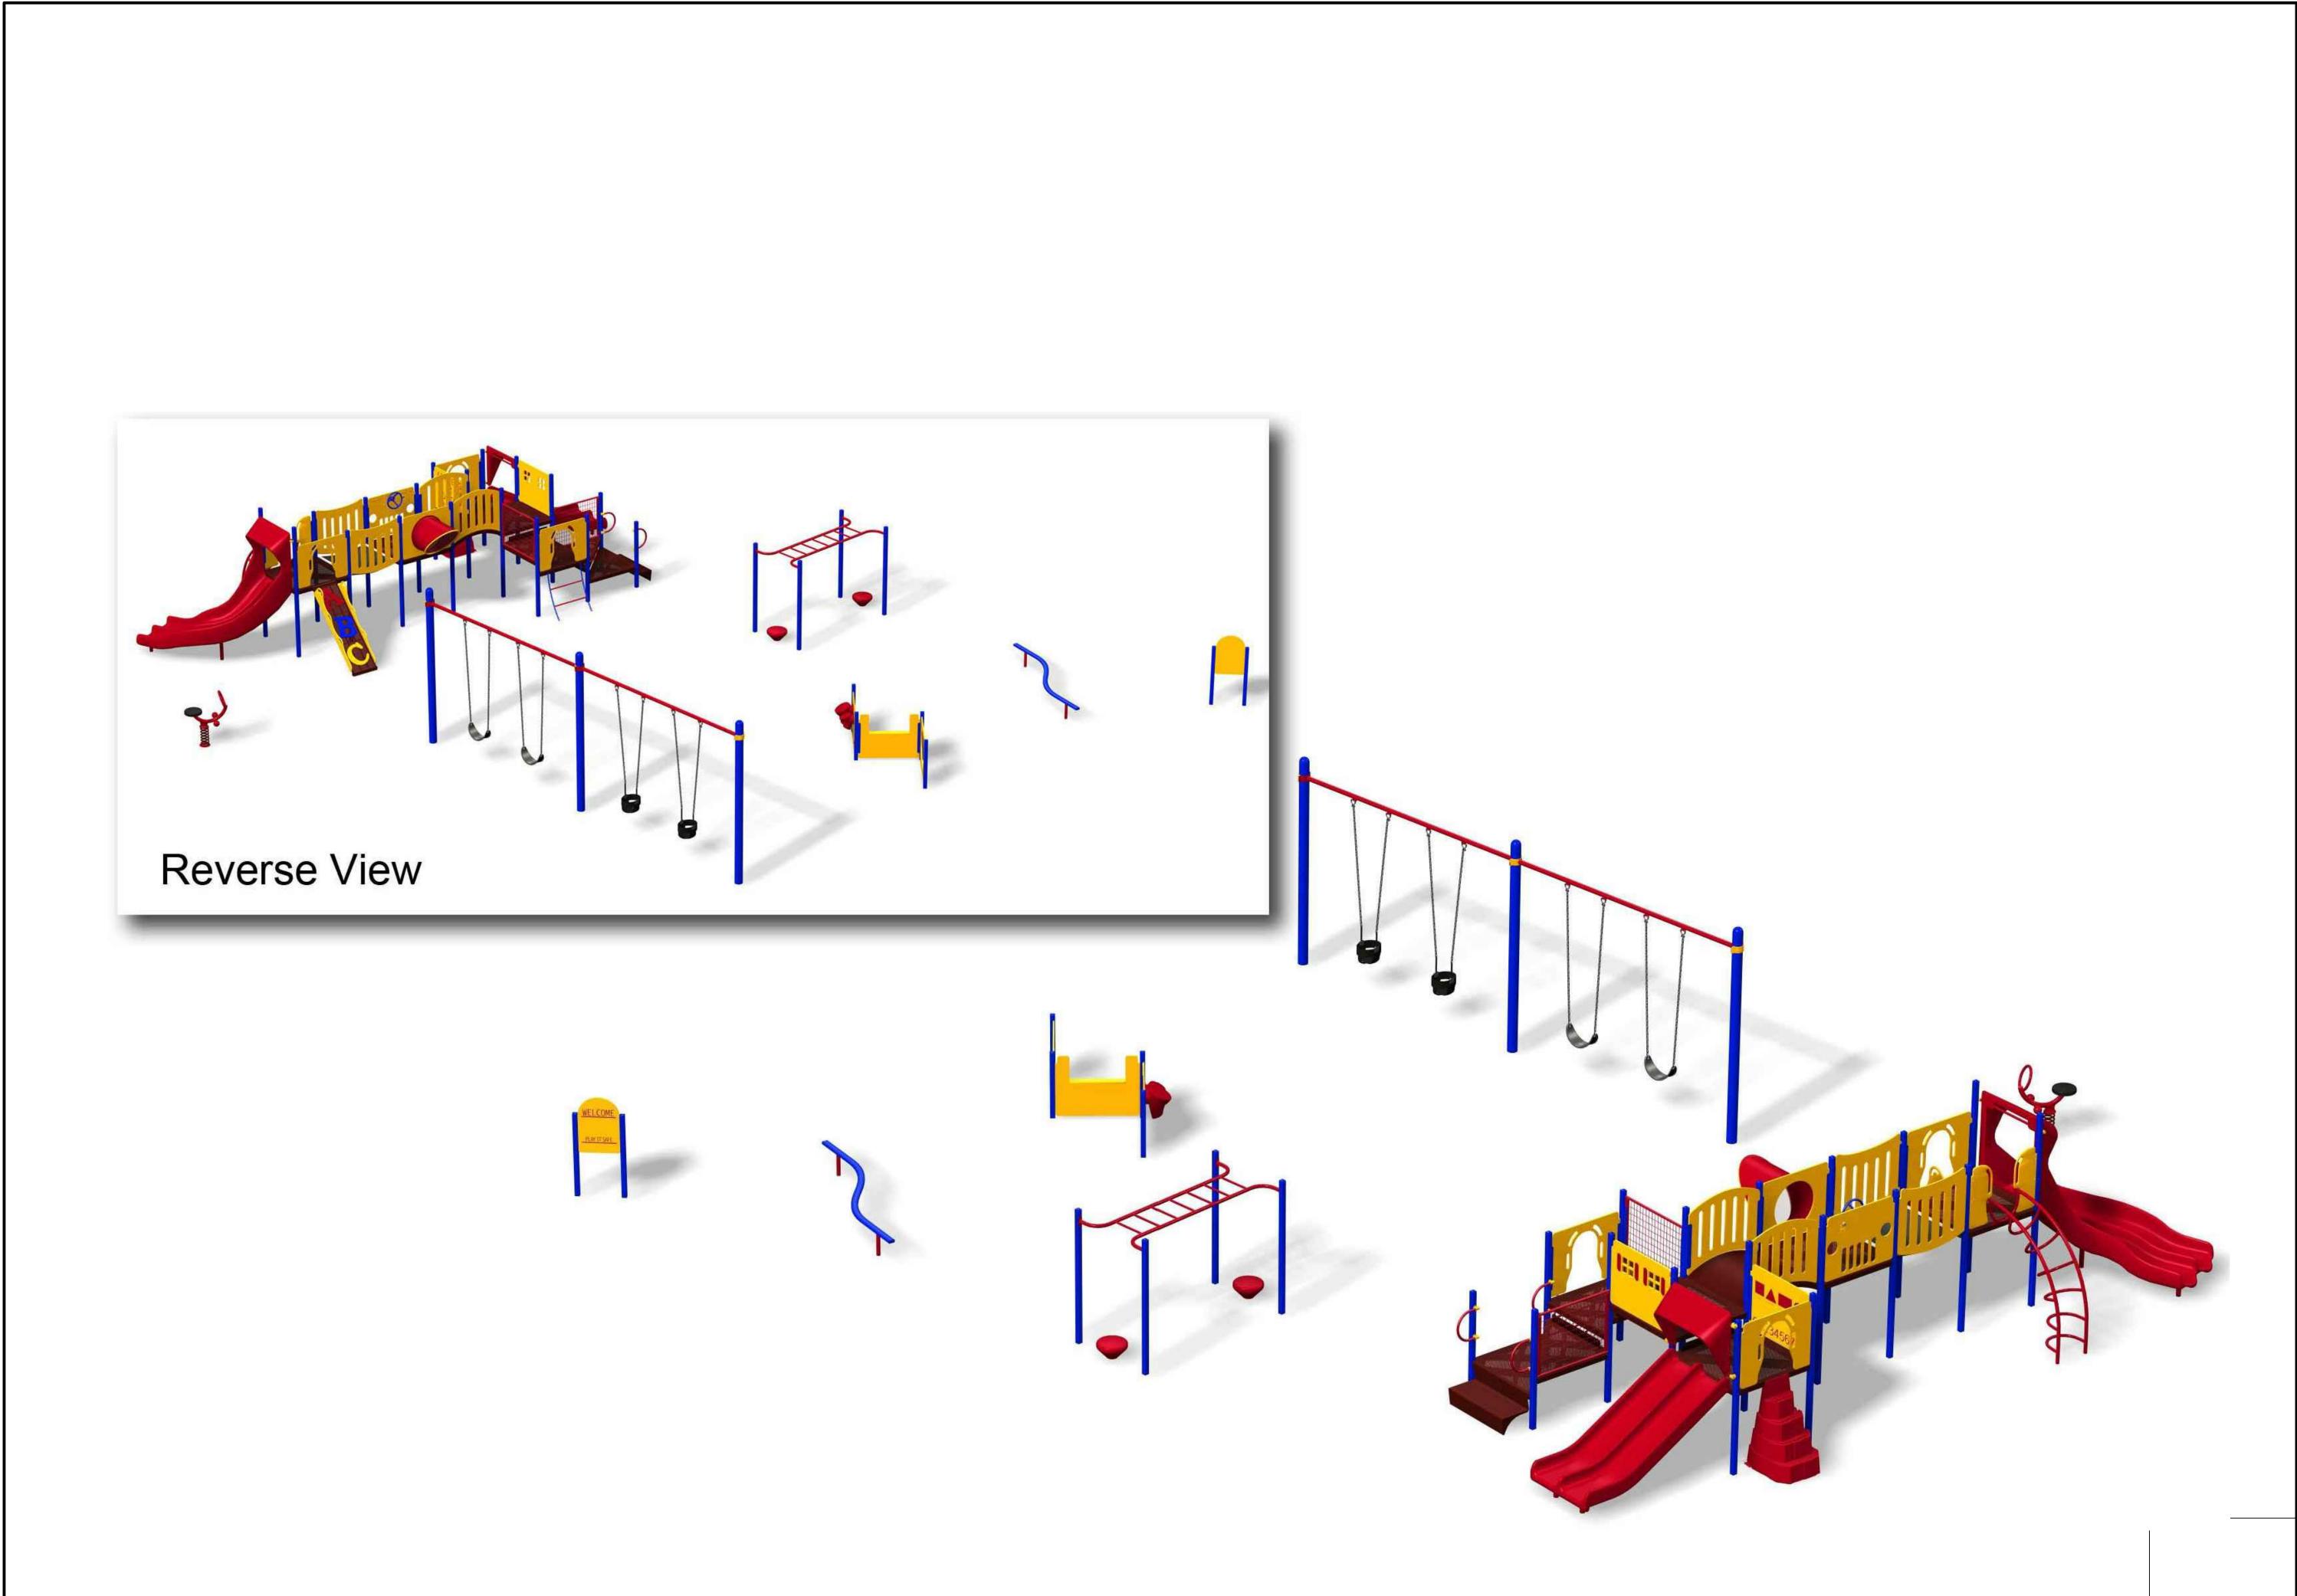



Landscape Architecture Civil Engineering

114 West Main Street, Suite 201 New Britain, CT 06051 P 860.612.1700 F 860.612.1757

www.todesignIIc.com

TOWN OF GLASTONBURY 2155 MAIN STREET

STATE PROJECT NO. 054-0095 MAG/N/PS 054-0096 MAG/N/PS Phase 4 of 4

BID NO. GL-2011-04-BP-120

Sheet Description:


Rendering -Age 2 - 5

Issue Date: SEPTEMBER 26, 2011

Project number: 5484-L

L-9.0

Drawn by: **MWF** 

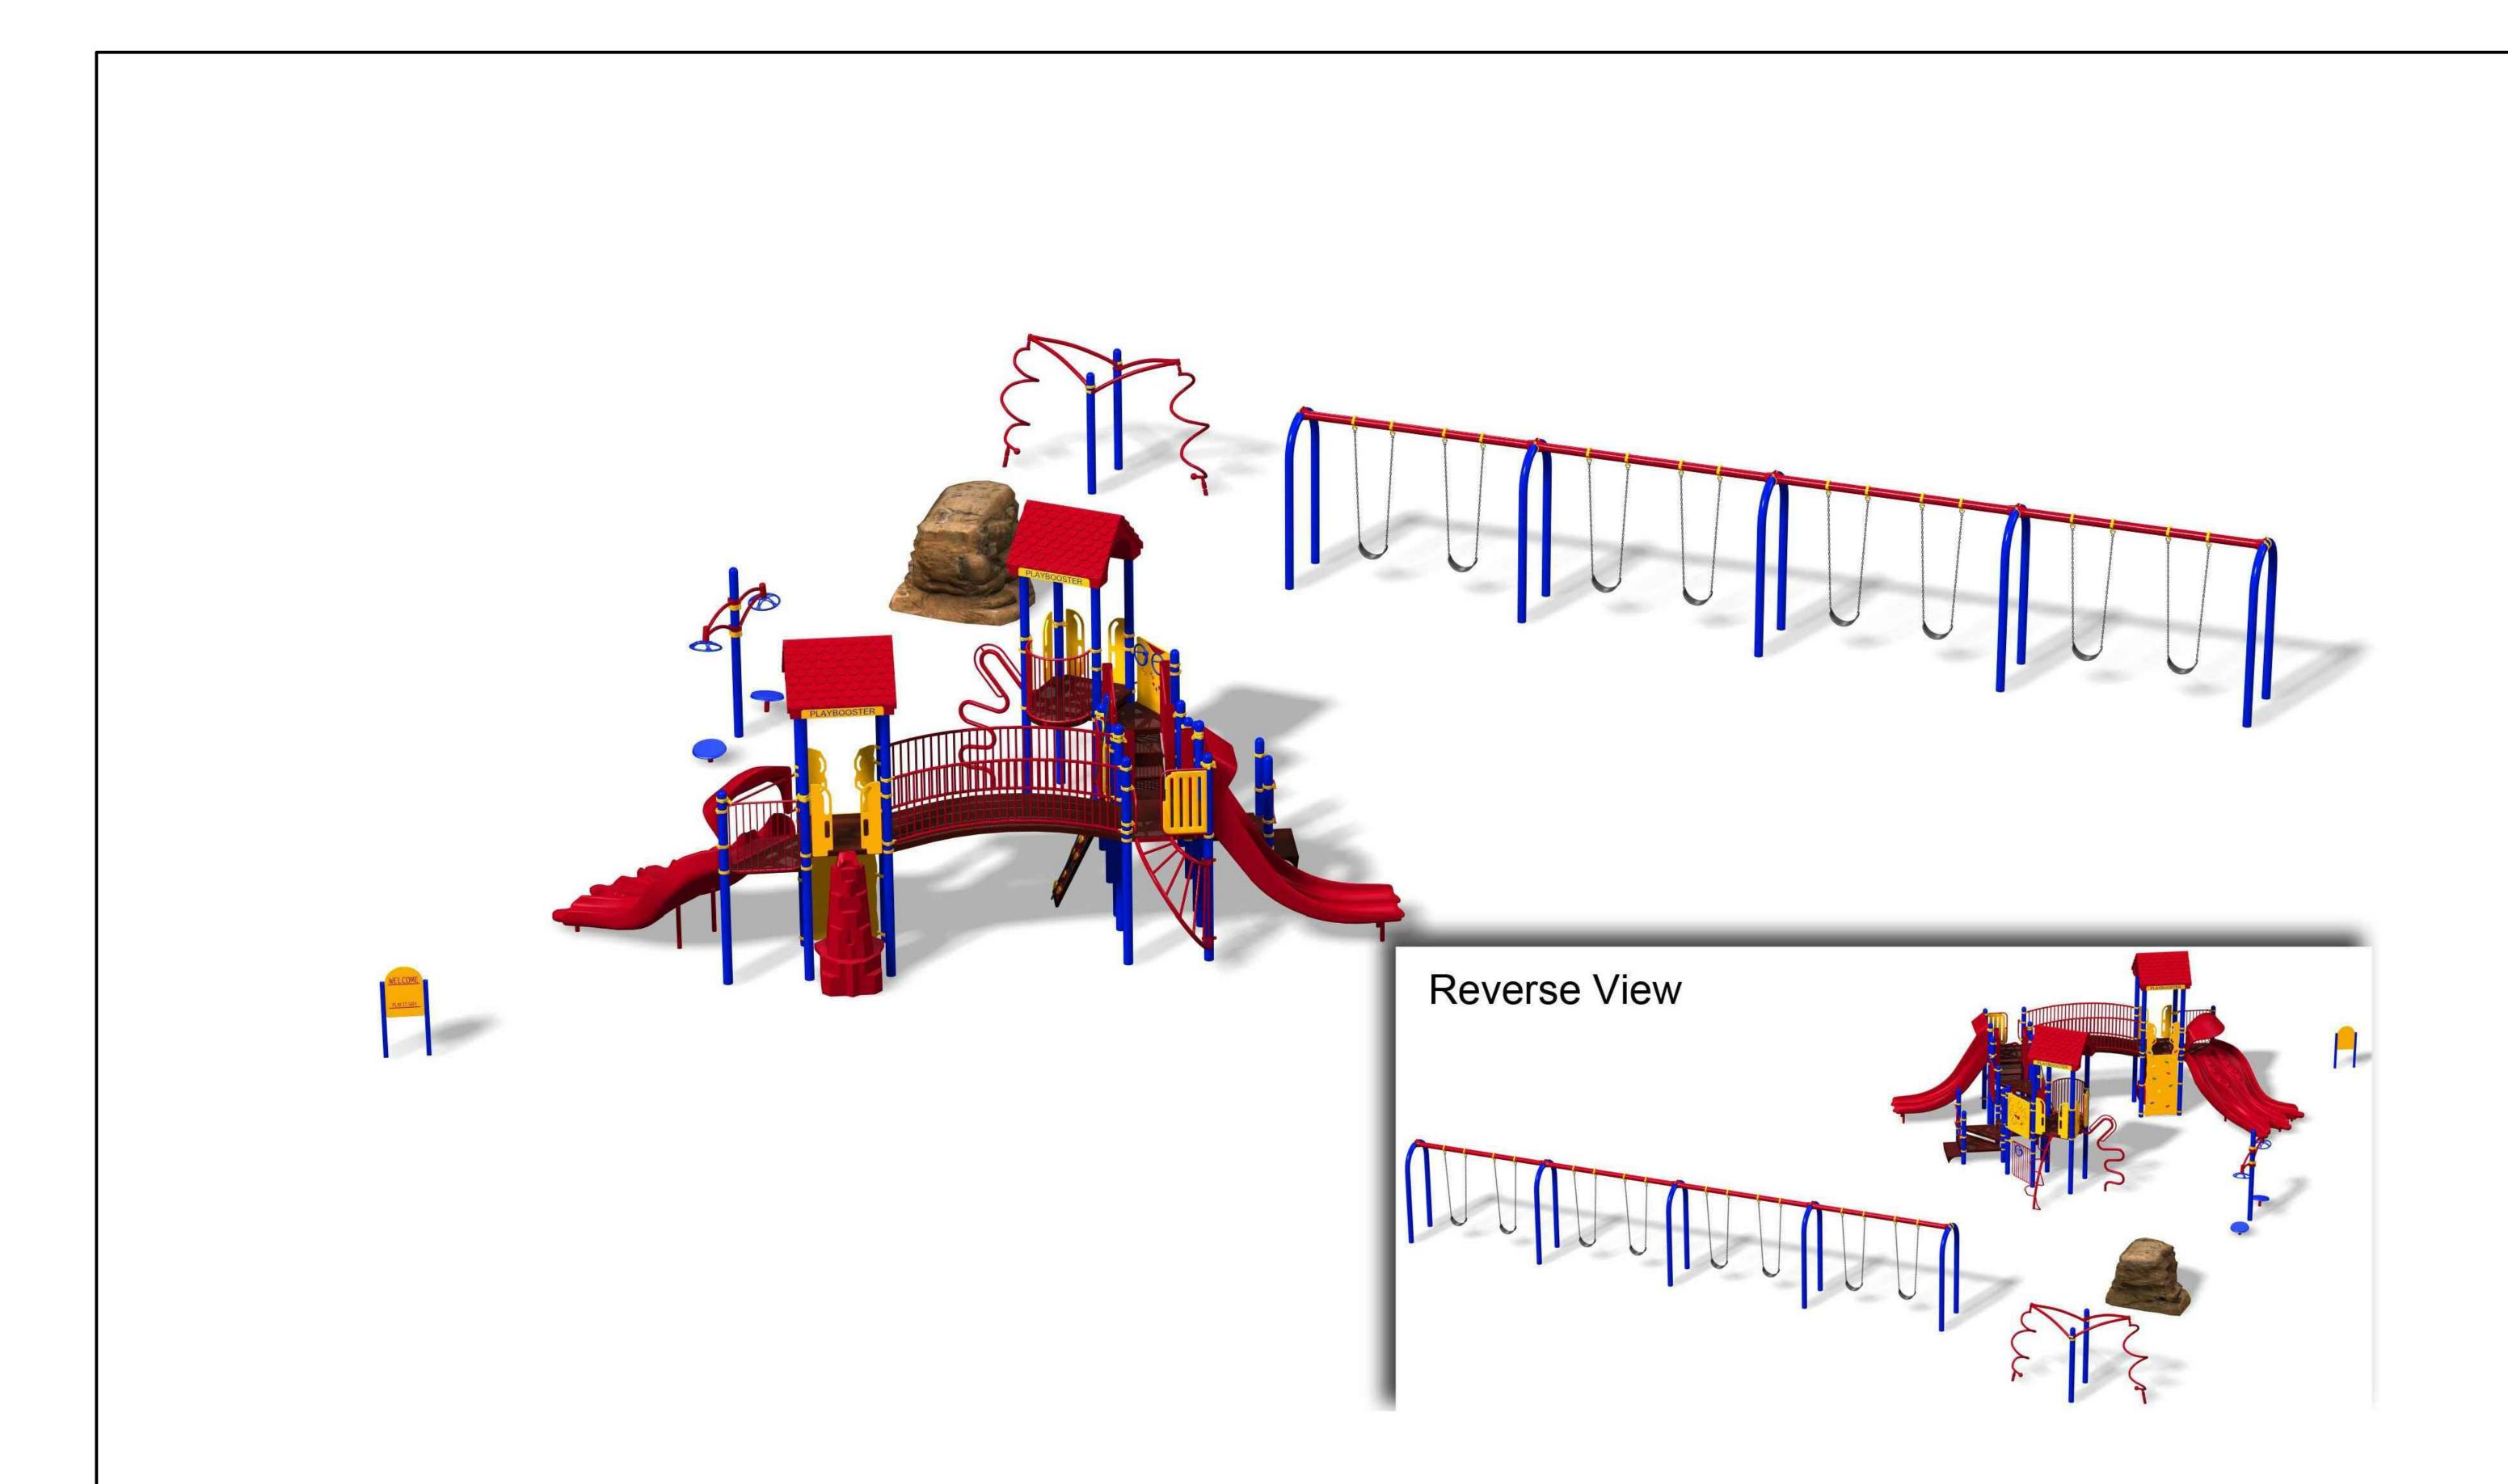



Landscape Architecture Civil Engineering

114 West Main Street, Suite 201 New Britain, CT 06051 P 860.612.1700 F 860.612.1757

www.todesignIlc.com

TOWN OF GLASTONBURY 2155 MAIN STREET

STATE PROJECT NO. 054-0095 MAG/N/PS 054-0096 MAG/N/PS Phase 4 of 4

BID NO.

GL-2011-04-BP-120

Rendering -Age 5 - 12

L-9.1