## TOWN OF GLASTONBURY DRAINAGE IMPROVEMENTS PW - 2402 LOCATED AT 483-532 MATSON HILL ROAD

CTDOT STANDARD SHEETS

CATCH BASIN TOPS TYPE "C" AND "C-L" DOUBLE GRATE TYPE 11 STRUCTURES

PRECAST CATCH BASIN AND ROUND STRUCTURES

HW-586-07a CATCH BASIN TOPS TYPE "C" AND "C-L"

HW-586-07c CATCH BASIN TOPS TYPE "C" AND "C-L" DOUBLE GRATE TYPE II TOPS




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DANIEL A. PENNINGTON
MANAGER OF PHYSICAL SERVICES/TOWN ENGINEER

ISSUED FOR PERMITTING 7-5-2024

P.W. 2402 NO.

DRAWING ISSUE STATUS

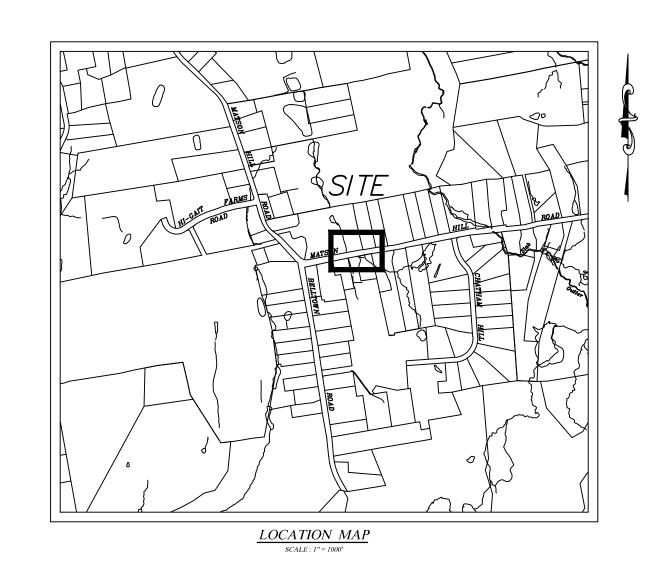SCALE: AS SHOWN DATE:

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DESCRIPTION





DRAINAGE IMPROVEMENTS
LOCATED ON
MATSON HILL ROAD
GLASTONBURY, CONNECTICUT

SHEET NO.


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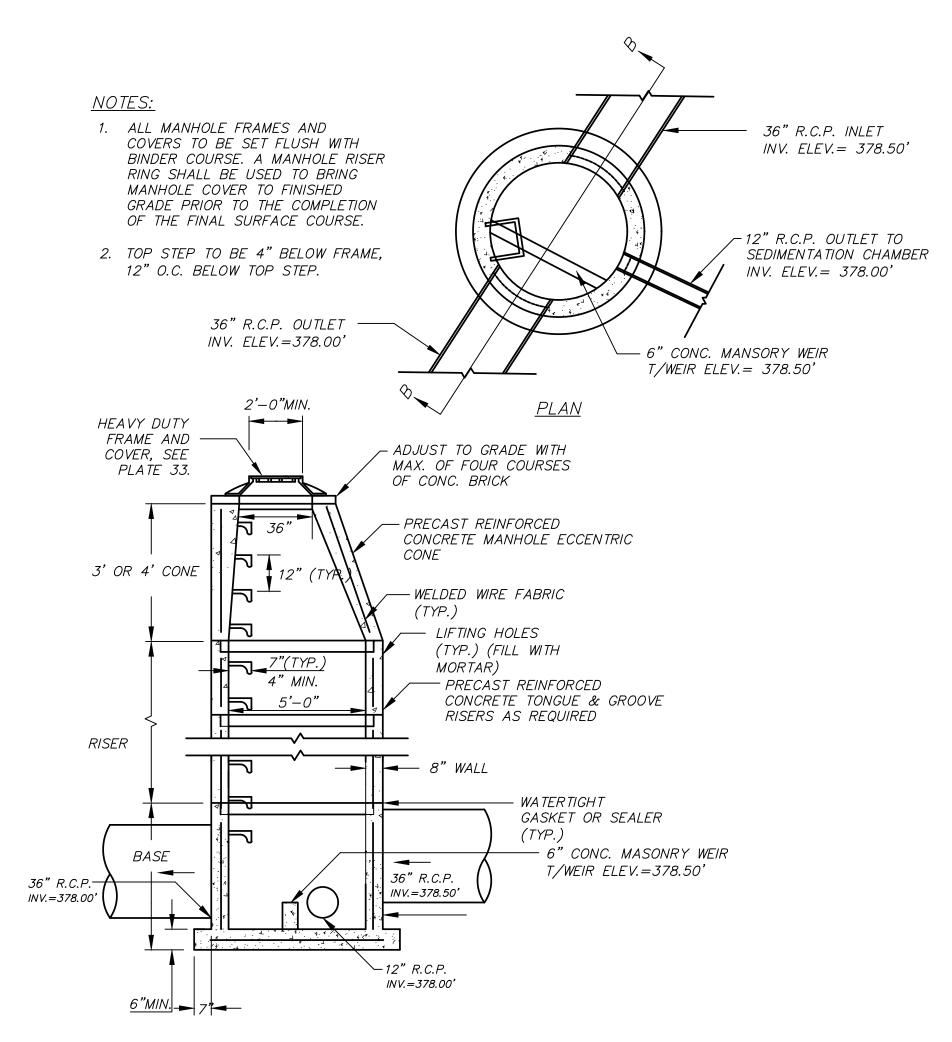
OF 4



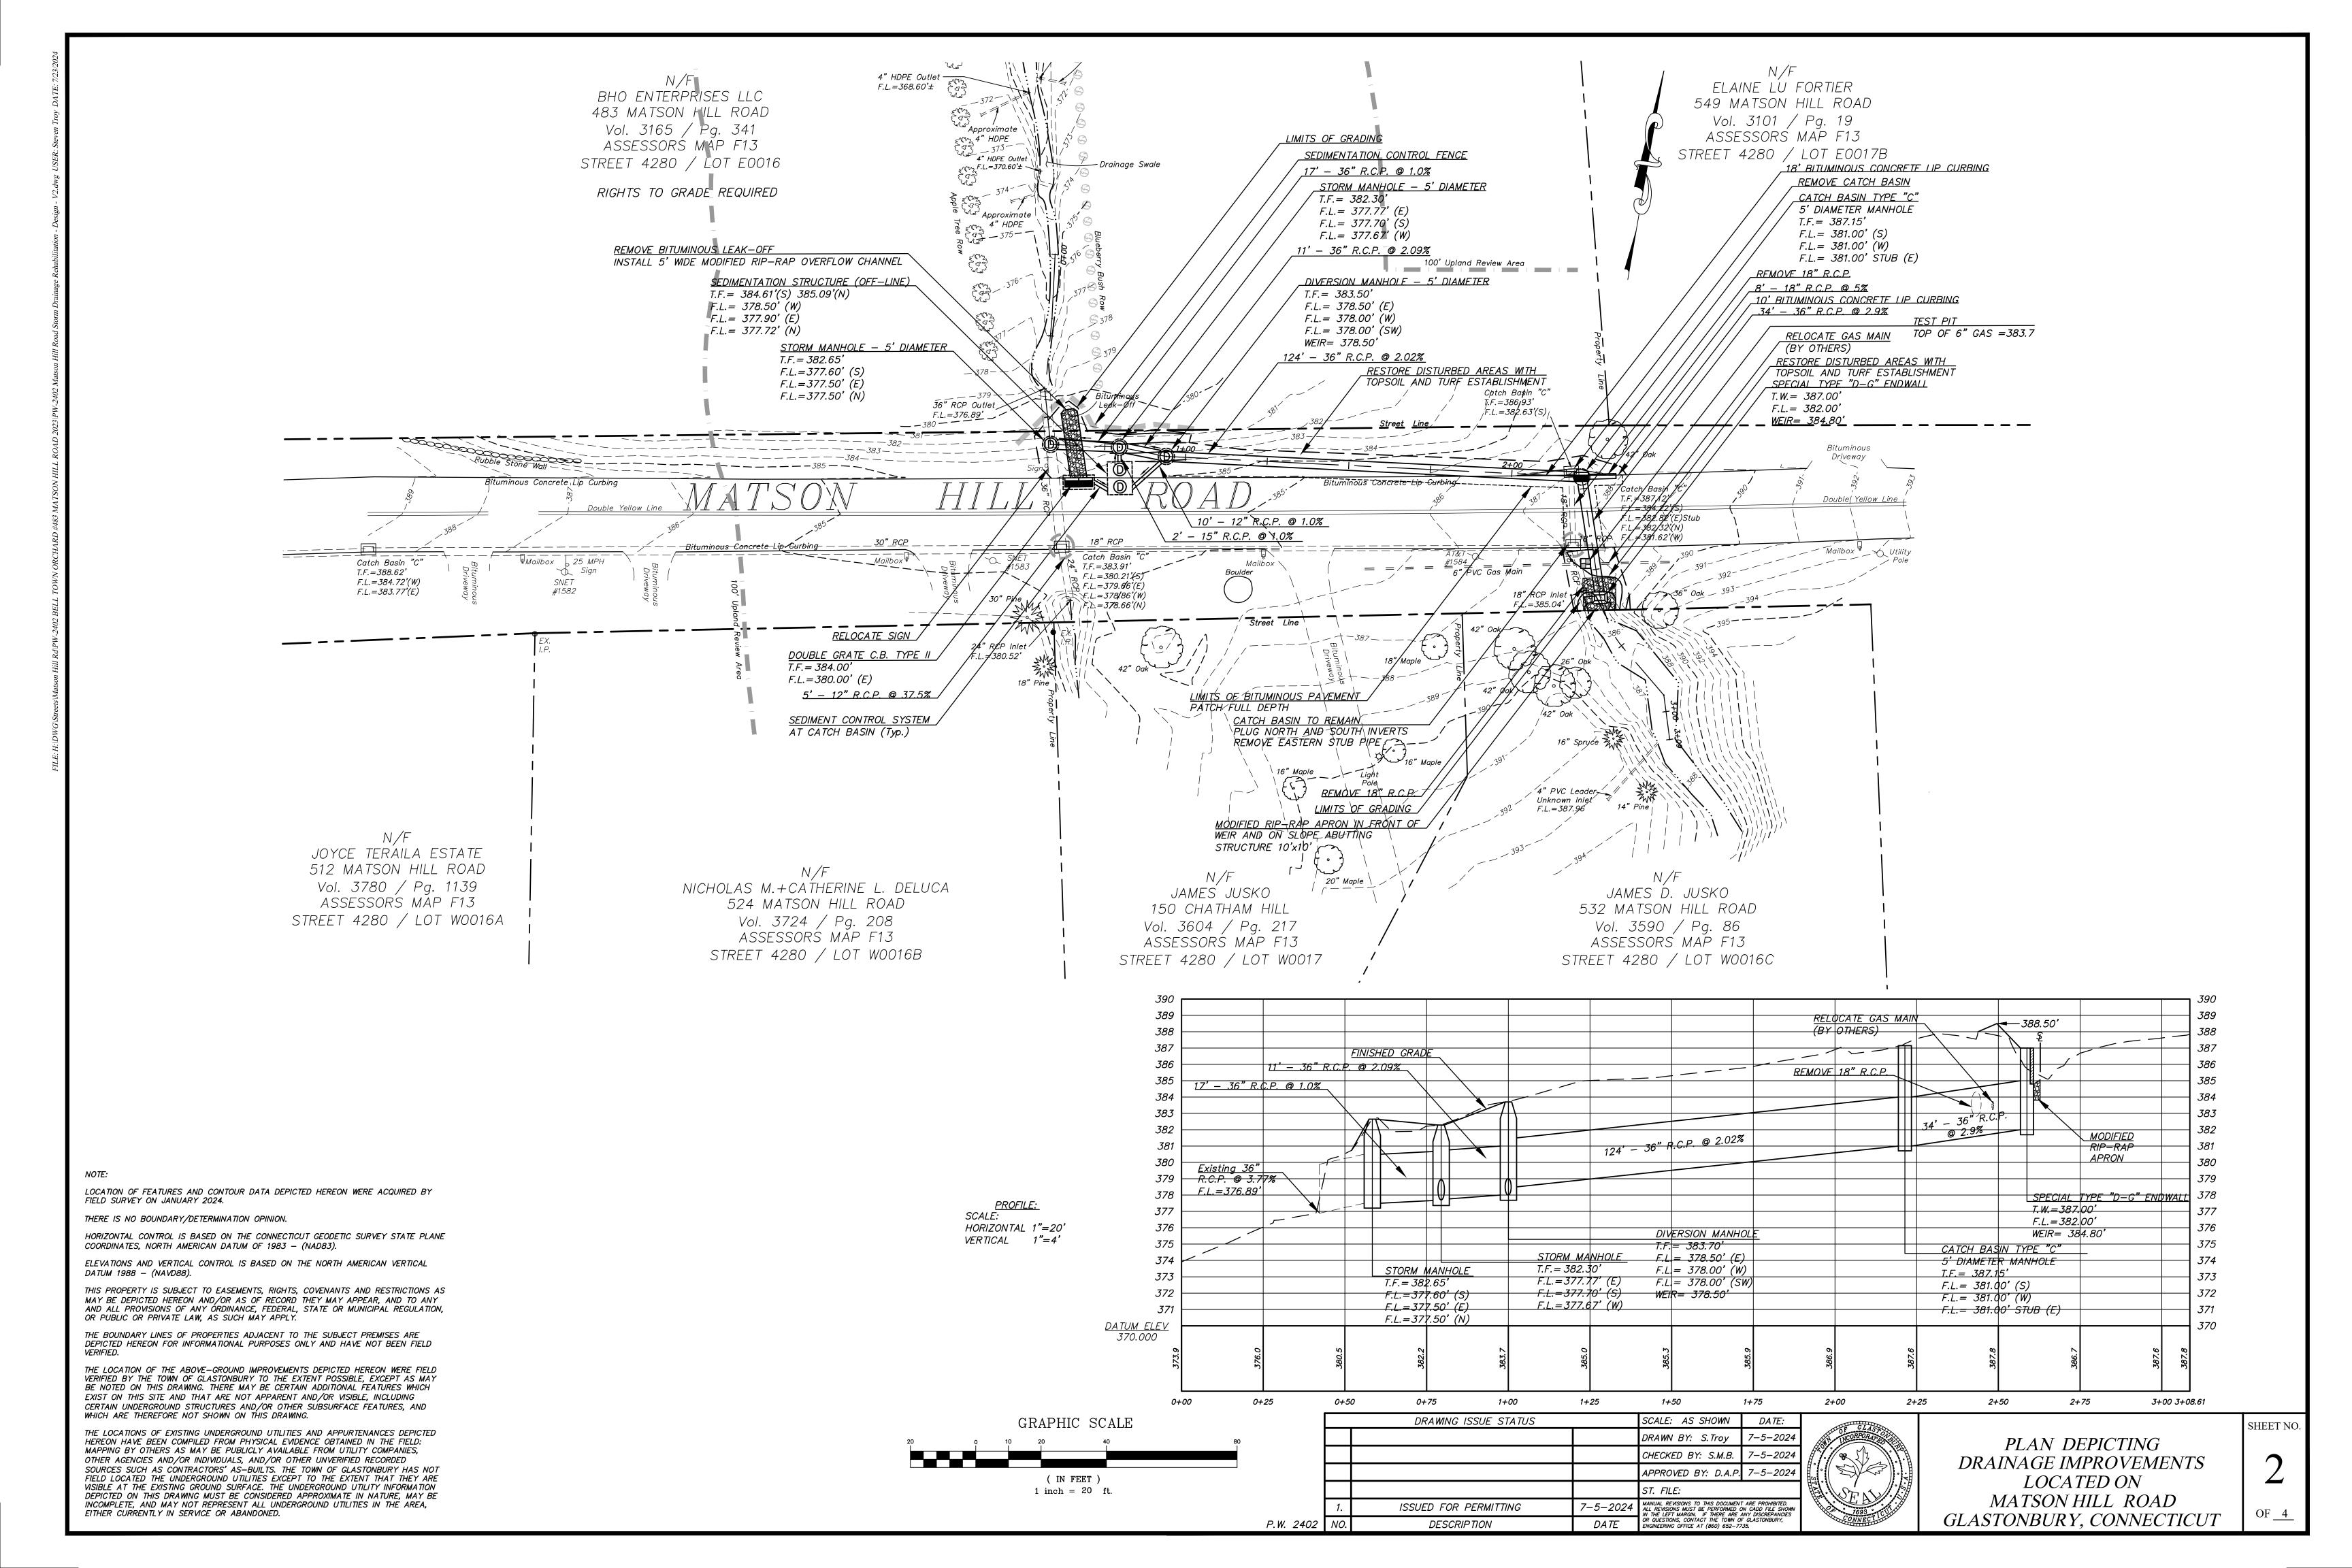

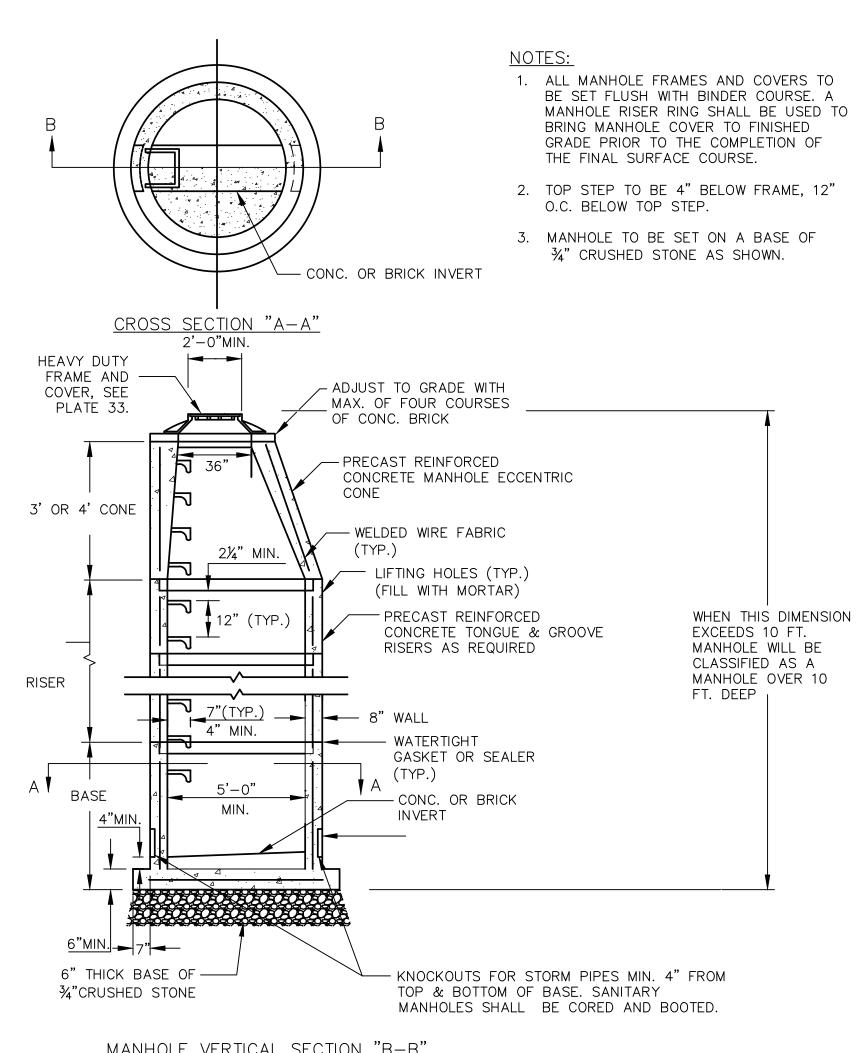MANHOLE VERTICAL SECTION "B-B" 5' PRECAST **CONCRETE MANHOLE** (STORM & SANITARY)



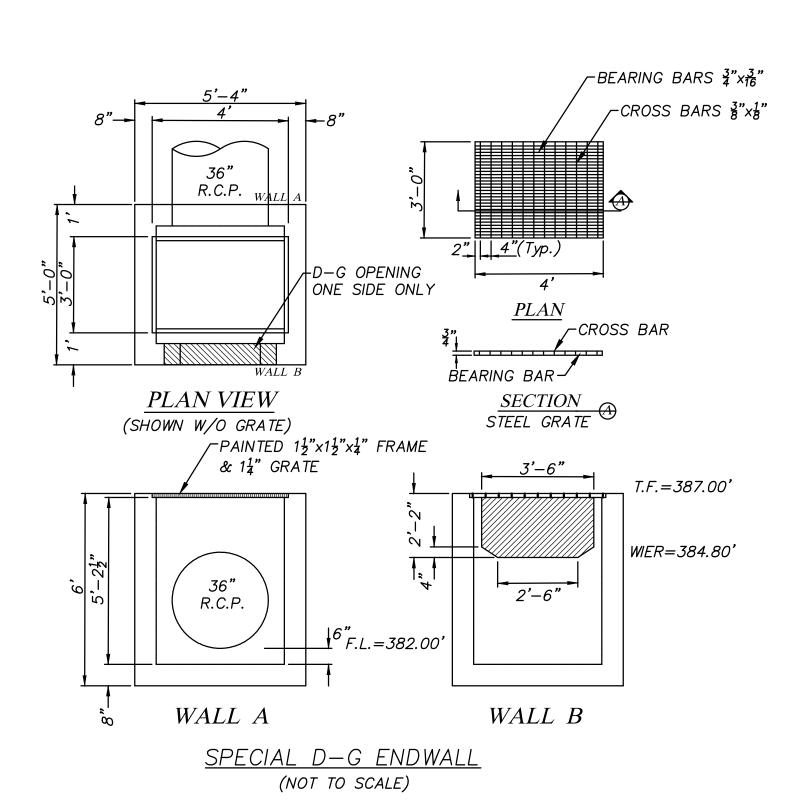

MANHOLE VERTICAL SECTION "B-B"

5' PRECAST CONCRETE DIVERSION MANHOLE (WITH WEIR) (NOT TO SCALE)

ELEV. 374.40'

GENERAL SEDIMENTATION AND EROSION CONTROL REQUIREMENTS:

WATER CONSERVATION.

THOROUGHLY STABILIZED.

THESE GUIDELINES SHALL APPLY TO ALL WORK CONSISTING OF ANY AND ALL TEMPORARY AND/OR PERMANENT MEASURES TO CONTROL WATER POLLUTION AND SOIL EROSION AS MAY BE REQUIRED, DURING THE CONSTRUCTION OF THE

IN GENERAL, ALL ACTIVITIES SHALL PROCEED IN SUCH A MANNER SO AS NOT TO POLLUTE ANY WETLANDS. WATERCOURSE, WATERBODY, AND CONDUIT CARRYING WATER, ETC. THE DEPARTMENT OF PHYSICAL SERVICES SHALL LIMIT, INSOFAR AS POSSIBLE, THE SURFACE AREA OF EARTH MATERIALS EXPOSED BY CONSTRUCTION METHODS, AND IMMEDIATELY PROVIDE PERMANENT AND TEMPORARY POLLUTION CONTROL MEASURES TO PREVENT CONTAMINATION OF ADJACENT WETLANDS, WATERCOURSES AND WATERBODIES, AND TO

PREVENT, INSOFAR AS POSSIBLE, EROSION ON THE SITE. CONSTRUCTION METHODS, IN GENERAL, SHALL BE IN ACCORDANCE WITH THE PROVISIONS SET FORTH IN THE "GUIDELINES FOR SOIL EROSION AND SEDIMENT

- 1. ALL CONTROL MEASURES SHALL BE INSTALLED AS NOTED ABOVE AND AS SHOWN ON THE PLANS.
- 2. ALL CONTROL MEASURES SHALL BE INSPECTED AND APPROVED BY THE ENGINEER PRIOR TO COMMENCEMENT OF ANY WORK, INCLUDING

CONTROL" (2002) BY THE STATE OF CONNECTICUT COUNCIL ON SOIL AND

- PRE-CONSTRUCTION CLEARING AND GRUBBING. 3. ALL CONTROL MEASURES SHALL BE MAINTAINED AND UPGRADED AS REQUIRED TO ACHIEVE PROPER SEDIMENT CONTROL THROUGHOUT THE
- 4. NO CONTROL MEASURES SHALL BE REMOVED WITHOUT APPROVAL FROM

CONSTRUCTION PERIOD AND UNTIL DISTURBED AREAS HAVE BEEN

- 5. ADDITIONAL CONTROL MEASURES SHALL BE INSTALLED DURING THE CONSTRUCTION PERIOD IF DEEMED NECESSARY BY THE ENGINEER.
- 6. THE LIMITS OF CLEARING, GRADING AND DISTURBANCE, AS SHOWN ON THE PLAN(S), SHALL BE KEPT TO A MINIMUM WITHIN THE APPROVED AREA OF CONSTRUCTION. ALL AREAS OUTSIDE THE LIMITS OF CLEARING SHALL REMAIN TOTALLY INDISTURBED.
- 7. ANY CONTROL MEASURES RETAINING SEDIMENT OVER 1/2 THEIR HEIGHT SHALL HAVE THE SEDIMENT IMMEDIATELY REMOVED, AND ALL DAMAGED CONTROL MEASURES SHALL BE REMOVED AND REPLACED.
- 8. ALL NEW AND EXISTING CATCH BASINS LOCATED WITHIN THE PROJECT LIMITS SHALL BE PROTECTED WITH A SEDIMENTATION CONTROL SYSTEM IN GRASSED AREAS OR WITH A SEDIMENTATION CONTROL SACK IN PAVED AREAS UNTIL ALL DISTURBED AREAS HAVE BEEN THOROUGHLY
- 9. SEDIMENT REMOVED FROM CONTROL MEASURES AND DRAINAGE FACILITIES SHALL BE DISPOSED OF IN A MANNER THAT IS CONSISTENT WITH STATE AND LOCAL REGULATIONS.
- 10. THE PLANTING SEASONS FOR THE SPECIFIED SEED MIXTURE SHALL BE AS DEFINED IN THE 2002 CONNECTICUT GUIDELINES FOR SOIL EROSION AND SEDIMENT CONTROL, UNLESS DIRECTED OTHERWISE BY THE TOWN ENVIROMENTAL PLANNER. OUTSIDE OF THESE SPECIFIED DATES, AREAS WILL BE STABILIZED WITH HAYBALE CHECK DAMS, FILTER FABRIC, OR WOODCHIP MULCH AS REQUIRED TO CONTROL EROSION.

PROJECT NARRATIVE:
THIS PROJECT INVOLVES THE INSTALLATION OF APPROXIMATELY 190 LINEAR FEET OF 36-INCH DIAMETER REINFORCED CONCRETE PIPE ALONG A PORTION OF MATSON HILL ROAD ABUTTING #483 AND #532 IN ORDER TO INCREASE DRAINAGE SYSTEM CAPACITY AND ADDRESS RECENT FLOODING EXPERIENCE ON PROPERTY OF #483. THE DRAINAGE IMPROVEMENTS INCLUDE A NEW DOUBLE CATCH BASIN WITH SUMP AT THE LOW POINT OF THE ROAD THAT WILL REPLACE THE EXISTING PAVED LEAK—OFF IN THIS AREA. ALSO INCLUDED IN THE PROJECT IS AN OFF-LINE SEDIMENTATION CHAMBER THAT WILL TREAT STORMWATER FROM THE DOUBLE CATCH BASIN AND LOW-FLOWS FROM THE NEW 36-INCH CULVERT IN ORDER TO REDUCE THE AMOUNT OF SEDIMENT BEING DISCHARGED DOWNSTREAM. THE TOTAL AREA OF DISTURBANCE FOR THE PROJECT IS APPROXIMATELY 0.06 ACRES OF UPLAND REVIEW AREA INCLUDING APPROXIMATELY 10 LINEAR FEET OF IMPACT TO THE EXISTING WATERCOURSE DUE TO INSTALLATION OF THE NEW INLET STRUCTURE.

THE FOLLOWING CONSTRUCTION SEQUENCE SHALL BE FOLLOWED FOR CONSTRUCTION ACTIVITIES IN THESE AREAS IN ORDER TO MINIMIZE THE POTENTIAL FOR IMPACT TO WETLANDS AND WATERCOURSES.

## CONSTRUCTION SEQUENCE


- 1. STAKE LIMITS OF GRADING AND DISTURBANCE IN THE FIELD PRIOR TO START OF CONSTRUCTION.
- 2. INSTALL SILT FENCE AT THE LIMITS OF DISTURBANCE SHOWN ON THE PLANS. INSTALL SILT SACKS IN ALL ABUTTING CATCH BASINS.
- 3. REMOVE TREES AND STUMPS AS REQUIRED FOR GRADING AND INSTALLATION OF PROPOSED IMPROVEMENTS.
- 4. DRAINAGE IMPROVEMENTS SHALL BE CONSTRUCTED FROM THE DOWNSTREAM END TO THE UPSTREAM END WHICH WILL ALLOW STORMWATER TO BE CONVEYED VIA THE EXISTING DRAINAGE SYSTEM UNTIL SUCH TIME AS THE SPECIAL D-G ENDWALL INLET STRUCTURE IS TO BE INSTALLED.
- PRIOR TO INSTALLATION OF THE D-G ENDWALL INLET STRUCTURE, SUBMIT WATER HANDLING PLAN TO THE ENGINEER FOR REVIEW AND APPROVAL AS REQUIRED TO CONVEY ANY ACTIVE FLOW WITHIN THE INTERMITTENT WATERCOURSE AND PERFORM THIS WORK IN DRY CONDITIONS. IMPLEMENT WATER HANDLING PLAN PRIOR TO INSTALLATION OF THE D-G ENDWALL INLET STRUCTURE.

PROJECT SPECIFIC SEDIMENTATION AND EROSION CONTROL PLAN CONSTRUCTION ACTIVITIES OF CONCERN RELATIVE TO THE PROTECTION OF ADJACENT WETLANDS AND WATERCOURSES FROM SEDIMENTATION ARE AS FOLLOWS:

- DEWATERING: OPEN TRENCH EXCAVATIONS WILL NEED TO BE DEWATERED AS NECESSARY FOR PROPER INSTALLATION OF THE PROPOSED PIPES. IN THESE AREAS, ALL WATER REMOVED FROM THE TRENCH SHALL BE ADEQUATELY TREATED PRIOR TO DISCHARGE USING MEASURES DESCRIBED IN SECTION 5-13 OF THE 2002 CT GUIDELINES FOR EROSION AND SEDIMENT CONTROL. THIS MAY INCLUDE A STONE SUMP AND STANDPIPE FOR PUMP INTAKE PROTECTION, AND A DIRT BAG OR PUMPING SETTLING BASIN FOR TREATMENT OF THE PUMPED WATER PRIOR TO DISCHARGE.
- 2. STOCKPILING: EXCAVATED MATERIAL SHALL NOT BE STOCKPILED ADJACENT TO STORM DRAIN INLETS, WETLANDS, OR WATERCOURSES. WHEN IT IS NECESSARY BASED ON THE PROPOSED METHODS OF CONSTRUCTION TO STAGE EXCAVATED MATERIAL FOR SHORT DURATIONS IN THE VICINITY OF STORM DRAIN INLETS, THESE INLETS SHALL BE PROPERLY PROTECTED AS DESCRIBED ON THE PLANS. LONGER DURATION STOCKPILING OF MATERIAL, WHEN NECESSARY, SHALL BE ONLY IN LOCATIONS APPROVED IN ADVANCE BY THE ENGINEER, AND SUCH STOCKPILES SHALL BE RINGED WITH A SEDIMENTATION CONTROL SYSTEM.
- DISTURBED AREAS: LIMITS OF DISTURBANCE SHALL BE IN STRICT ACCORDANCE WITH THE APPROVED PLAN. ALL AREAS DISTURBED BY CONSTRUCTION SHALL BE STABILIZED WITH THE FINAL SURFACE TREATMENT AS SOON AS POSSIBLE AFTER CONSTRUCTION ACTIVITIES ARE COMPLETED. DISTURBED AREAS WITH STEEP OR LONG SLOPES AND OTHER AREAS WITH SIGNIFICANT POTENTIAL FOR CAUSING SEDIMENTATION SHALL BE PROTECTED WITH TEMPORARY STRAW MULCH, WOOD CHIPS, EROSION CONTROL MATTING, OR OTHER SUITABLE MATERIALS PRIOR TO SIGNIFICANT FORECASTED RAIN STORM EVENTS TO REDUCE EROSION
- 4. CULVERTS CONVEYING WATERCOURSES: CULVERTS CONVEYING WATERCOURSES SHALL BE CONSTRUCTED IN SUCH A MANNER AS TO PROVIDE A TEMPORARY BYPASS OF THE WORK AREA THROUGH A TEMPORARY PIPE OR OTHER MEANS APPROVED BY THE ENGINEER AS REQUIRED TO CONVEY STORMWATER THROUGH THE WORK AREA AND ENSURE THAT DOWNSTREAM WETLAND AREAS ARE PROTECTED FROM SEDIMENTATION
- SEVERE WEATHER CONTINGENCY PLAN: IN ADVANCE OF A SEVERE WEATHER EVENT, ALL EROSION CONTROLS DESCRIBED ABOVE AND ELSEWHERE ON THE PLANS SHALL BE INSPECTED AND ADJUSTED AS

NOTES:

THE CONTRACTOR SHALL PROVIDE A REPRESENTATIVE WHO IS RESPONSIBLE FOR IMPLEMENTING THE EROSION AND SEDIMENTATION CONTROL PLAN. THIS INCLUDES THE INSTALLATION AND MAINTENANCE OF ALL CONTROL MEASURES, INFORMING ALL PARTIES ENGAGED ON THE CONSTRUCTION SITE OF THE REQUIREMENTS AND OBJECTIVES OF THE PLAN.

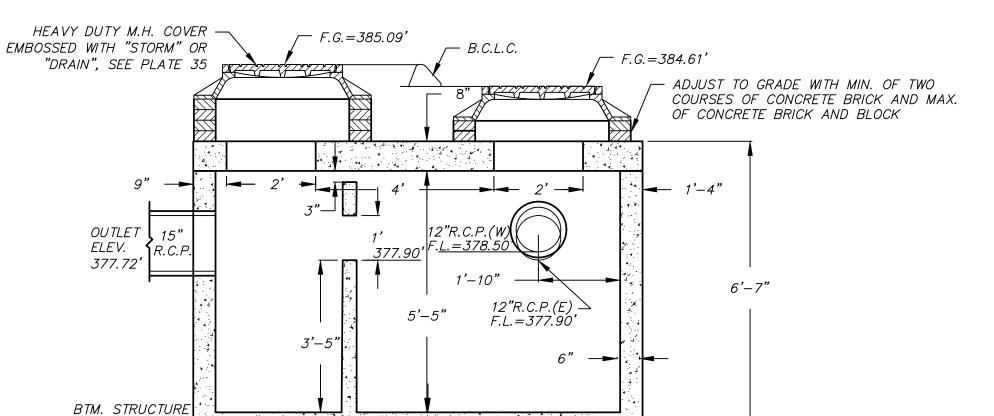

PRECAST SEDIMENTATION STRUCTURE (NOT TO SCALE)

SEDIMENTATION STRUCTURE

7. ROOF AND SIDEWALL OPENINGS AS SPECIFIED. F.L.=377.90' R.C.P. (3)-12**"**ø =377.72' HOLES 3'-9<del>1</del>" **EVENLY** SPACED 12" R.C.P DESIGN BASED ON "UNITED CONCRETE F.L.=328.50 PRODUCTS INC. 2000 GALLON HS-20

1. BAFFLE CONSTRUCTION TO BE CAST MATERIAL WITH

2. ADJUST M.H. FRAME TO SUIT REQUIRED FIELD HEIGHT. 3. CONSTRUCTION JOINT - SEALED WITH 1" DIA. BUTYL

5. STEEL REINFORCEMENT - ASTM A-615-75, GRADE 60, MIN

6. CONCRETE MINIMUM STRENGTH - 5,000 P.S.I. @ 28 DAYS.

THROUGH HOLES ABOVE FLOW LINE.

RUBBER OR ACCEPTABLE EQUIVALENT

4. DESIGN LOADING - ASHTO HS20.

2" MIN. COVER.

DRAWING ISSUE STATUS SCALE: AS SHOWN DRAWN BY: S.Troy 7-5-202 CHECKED BY: S.M.B. 7-5-202 APPROVED BY: D.A.P. 7-5-2024 ST. FILE: MANUAL REVISIONS TO THIS DOCUMENT ARE PROHIBITED.
ALL REVISIONS MUST BE PERFORMED ON CADD FILE SHOW
IN THE LEFT MARGIN. IF THERE ARE ANY DISCREPANCIES
OR QUESTIONS, CONTACT THE TOWN OF GLASTONBURY,
ENGINEERING OFFICE AT (860) 652-7735. ISSUED FOR PERMITTING 7-5-2024

PRE-CAST CONCRETE UNIT

DESCRIPTION

DETAILS DEPICTING DRAINAGE IMPROVEMENTS LOCATED ON MATSON HILL ROAD GLASTONBURY, CONNECTICUT

SEPTIC TANK".


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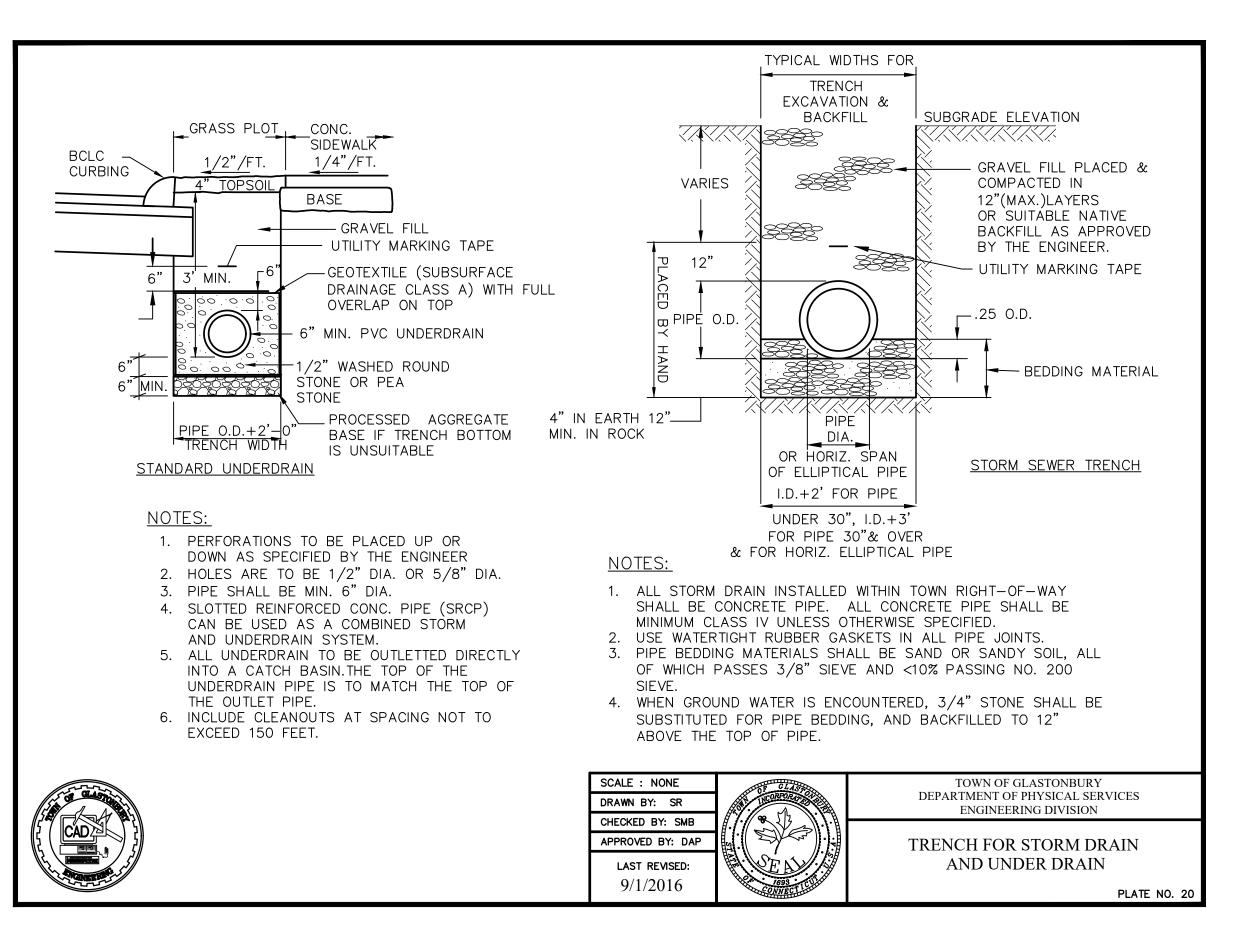
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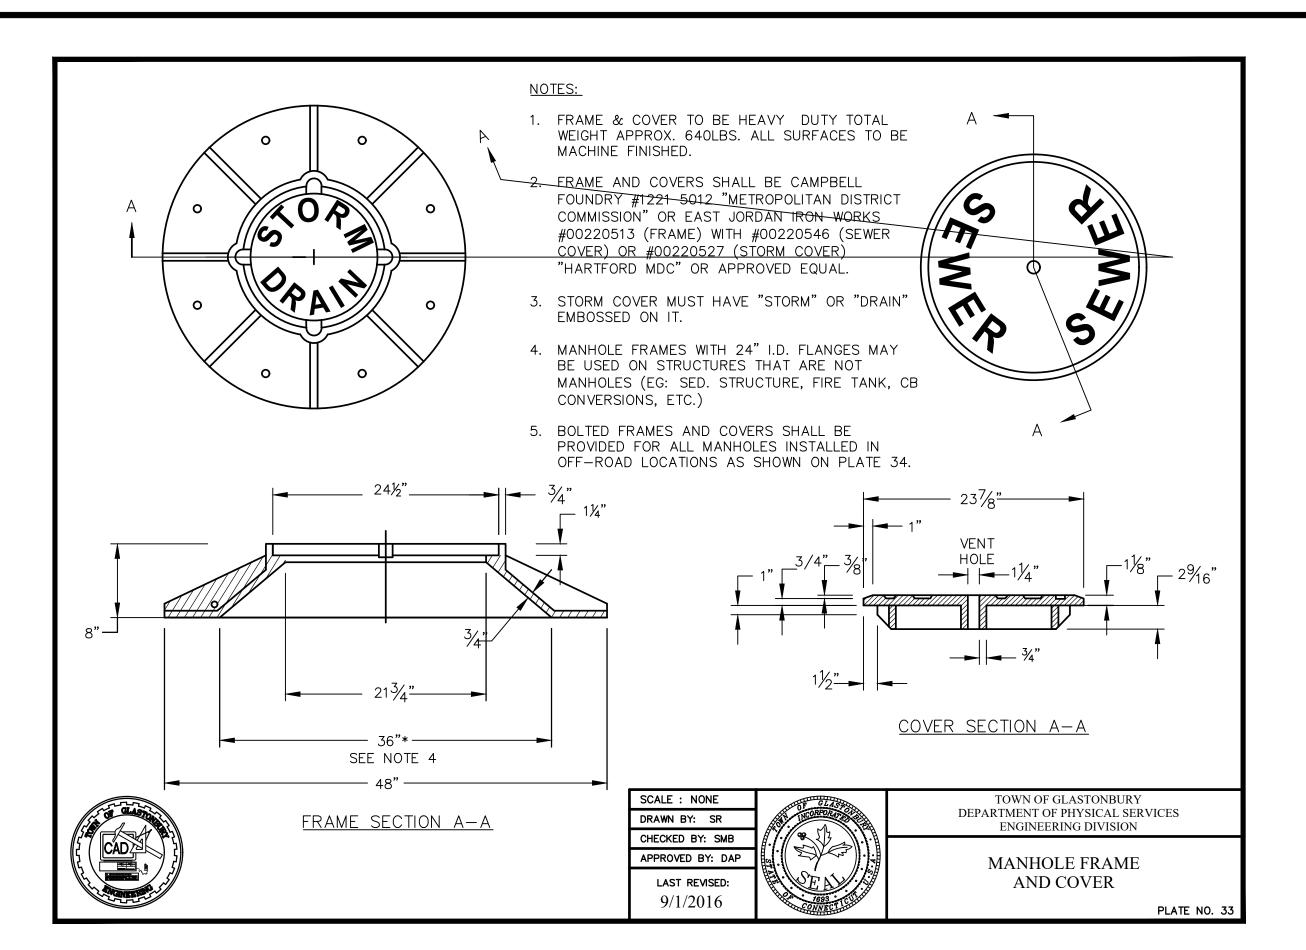
PLAN VIEW (TOP)


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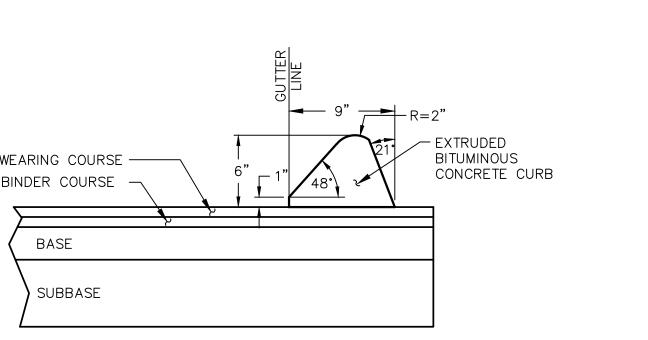
P.W. 2402 NO.









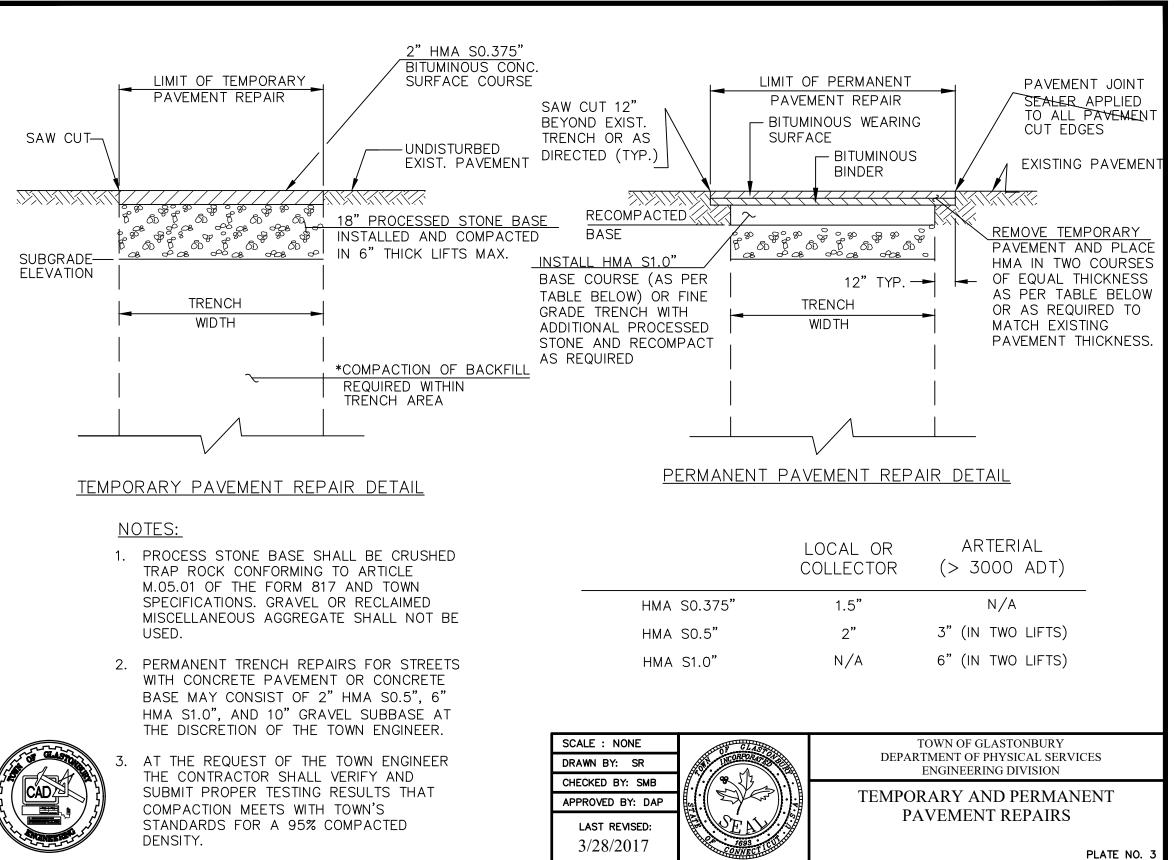

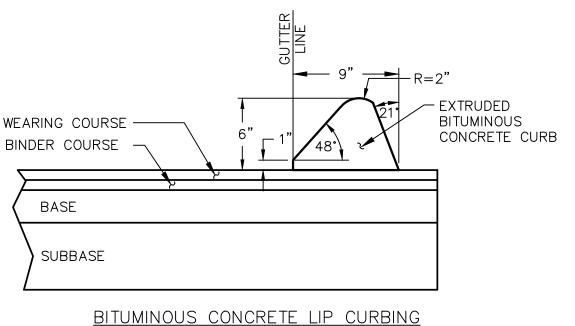


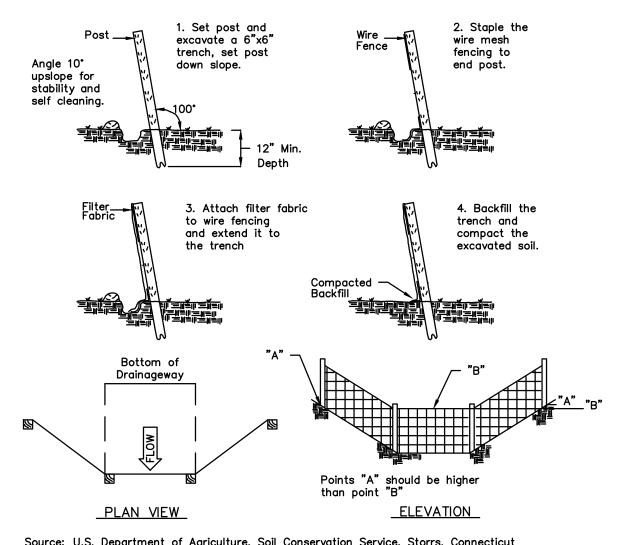


Source: U.S. Department of Agriculture, Soil Conservation Service, Storrs, Connecticut SEDIMENTATION CONTROL FILTER FABRIC FENCE SYSTEM

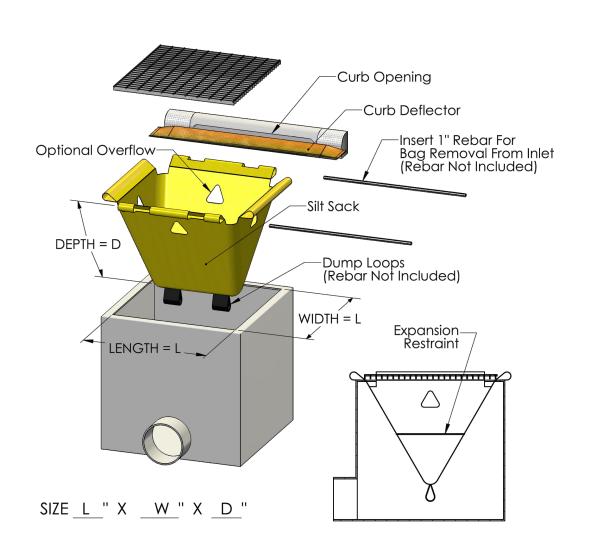

SEDIMENT CONTROL SYSTEM AT CATCH BASIN (NOT TO SCALE)

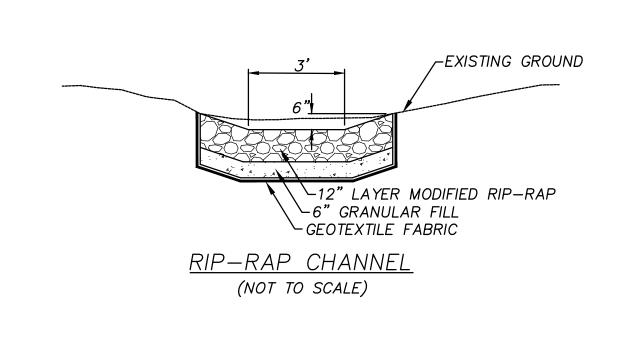

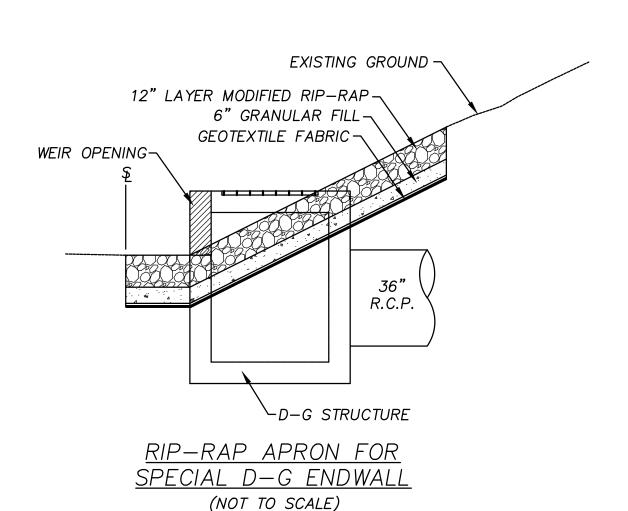

	1.	ISSUED FOR PERMITTING	7-5-2024			
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				APPROVED BY: D.A.P.	7-5-2024	S
				CHECKED BY: S.M.B.	7-5-2024	
				DRAWN BY: S.Troy	7-5-2024	
		DRAWING ISSUE STATUS	SCALE: AS SHOWN	DATE:		



DETAILS DEPICTING DRAINAGE IMPROVEMENTS LOCATED ON MATSON HILL ROAD GLASTONBURY, CONNECTICUT SHEET NO

OF <u>4</u>

DATE OR QUESTIONS, CONTACT THE TOWN OF GLASTONBURY, ENGINEERING OFFICE AT (860) 652-7735. DESCRIPTION

P.W. 2402 NO.