
TOWN OF GLASTONBURY ENGINEERING DEPARTMENT PROPOSED WESTERN BOULEVARD CONNECTOR PW-0920

located between

NATIONAL DRIVE & EASTERN BOULEVARD GLASTONBURY, CONNECTICUT

SHEET INDEX

SHEET NO.	DESCRIPTION		
1	TITLE SHEET		
2,3	PROPOSED WESTERN BOULEVARD CONNECTOR PLAN AND PROFILE		
4,5,6,7	PROPOSED WESTERN BOULEVARD CONNECTOR CROSS SECTIONS		
8,9,10	PROPOSED WESTERN BOULEVARD CONNECTOR MDC — WATER MAIN PLAN & PROFILE, DETAILS		
11,12	PROPOSED WESTERN BOULEVARD CONNECTOR STORM WATER POLLUTION CONTROL PLAN/DETAILS		
13,14	PROPOSED WESTERN BOULEVARD CONNECTOR MISC. DETAILS/NOTES		
15	PROPOSED WESTERN BOULEVARD CONNECTOR MISC. UTILITY DETAILS/NOTES		

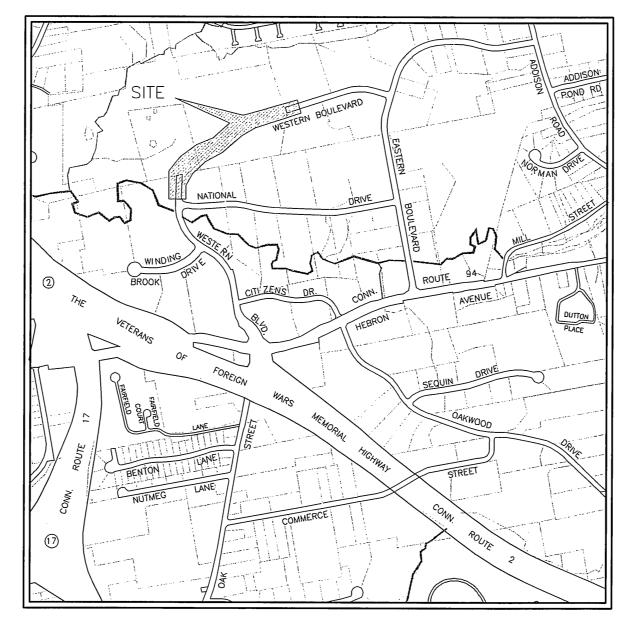

LOCATION MAP SCALE: 1"=1000'

JUNE 2010

ISSUED FOR CONSTRUCTION

RICHARD J. JOHNSON **TOWN MANAGER**

DANIEL A. PENNINGTON MANAGER OF PHYSICAL SERVICES/TOWN ENGINEER


PROJECT ADDRESS SPECIAL PERMIT SECTION TPZ CHAIRPERSON DATE SPECIAL PERMIT APP'D DIRECTOR OF COMMUNITY DEVELOPMENT FILE NO.




ALL UTILITY INFORMATION AND DATA SHOWN OF INDICATED IN THE CONTRACT DOCUMENTS ARE

COMPLIED FROM MAPS AND DATA FURNISHED BY THERS, ANY SUCH INFORMATION SHOULD NOT E CONSTRUED AS ACCURATE OR COMPLETE

MANUAL REVISIONS TO THIS DOCUMENT ARE PROHIBITED. ALL REVISIONS MUST BE PERFORMED ON CADD FILE: H: \DWG\Streets\Western Blvd\Civil 3D 2009\Western Boulevard Connector.dwg

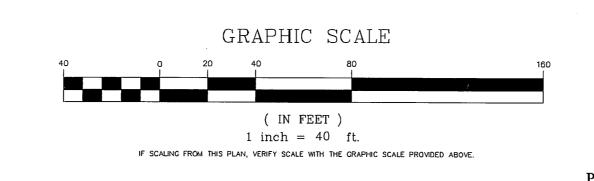


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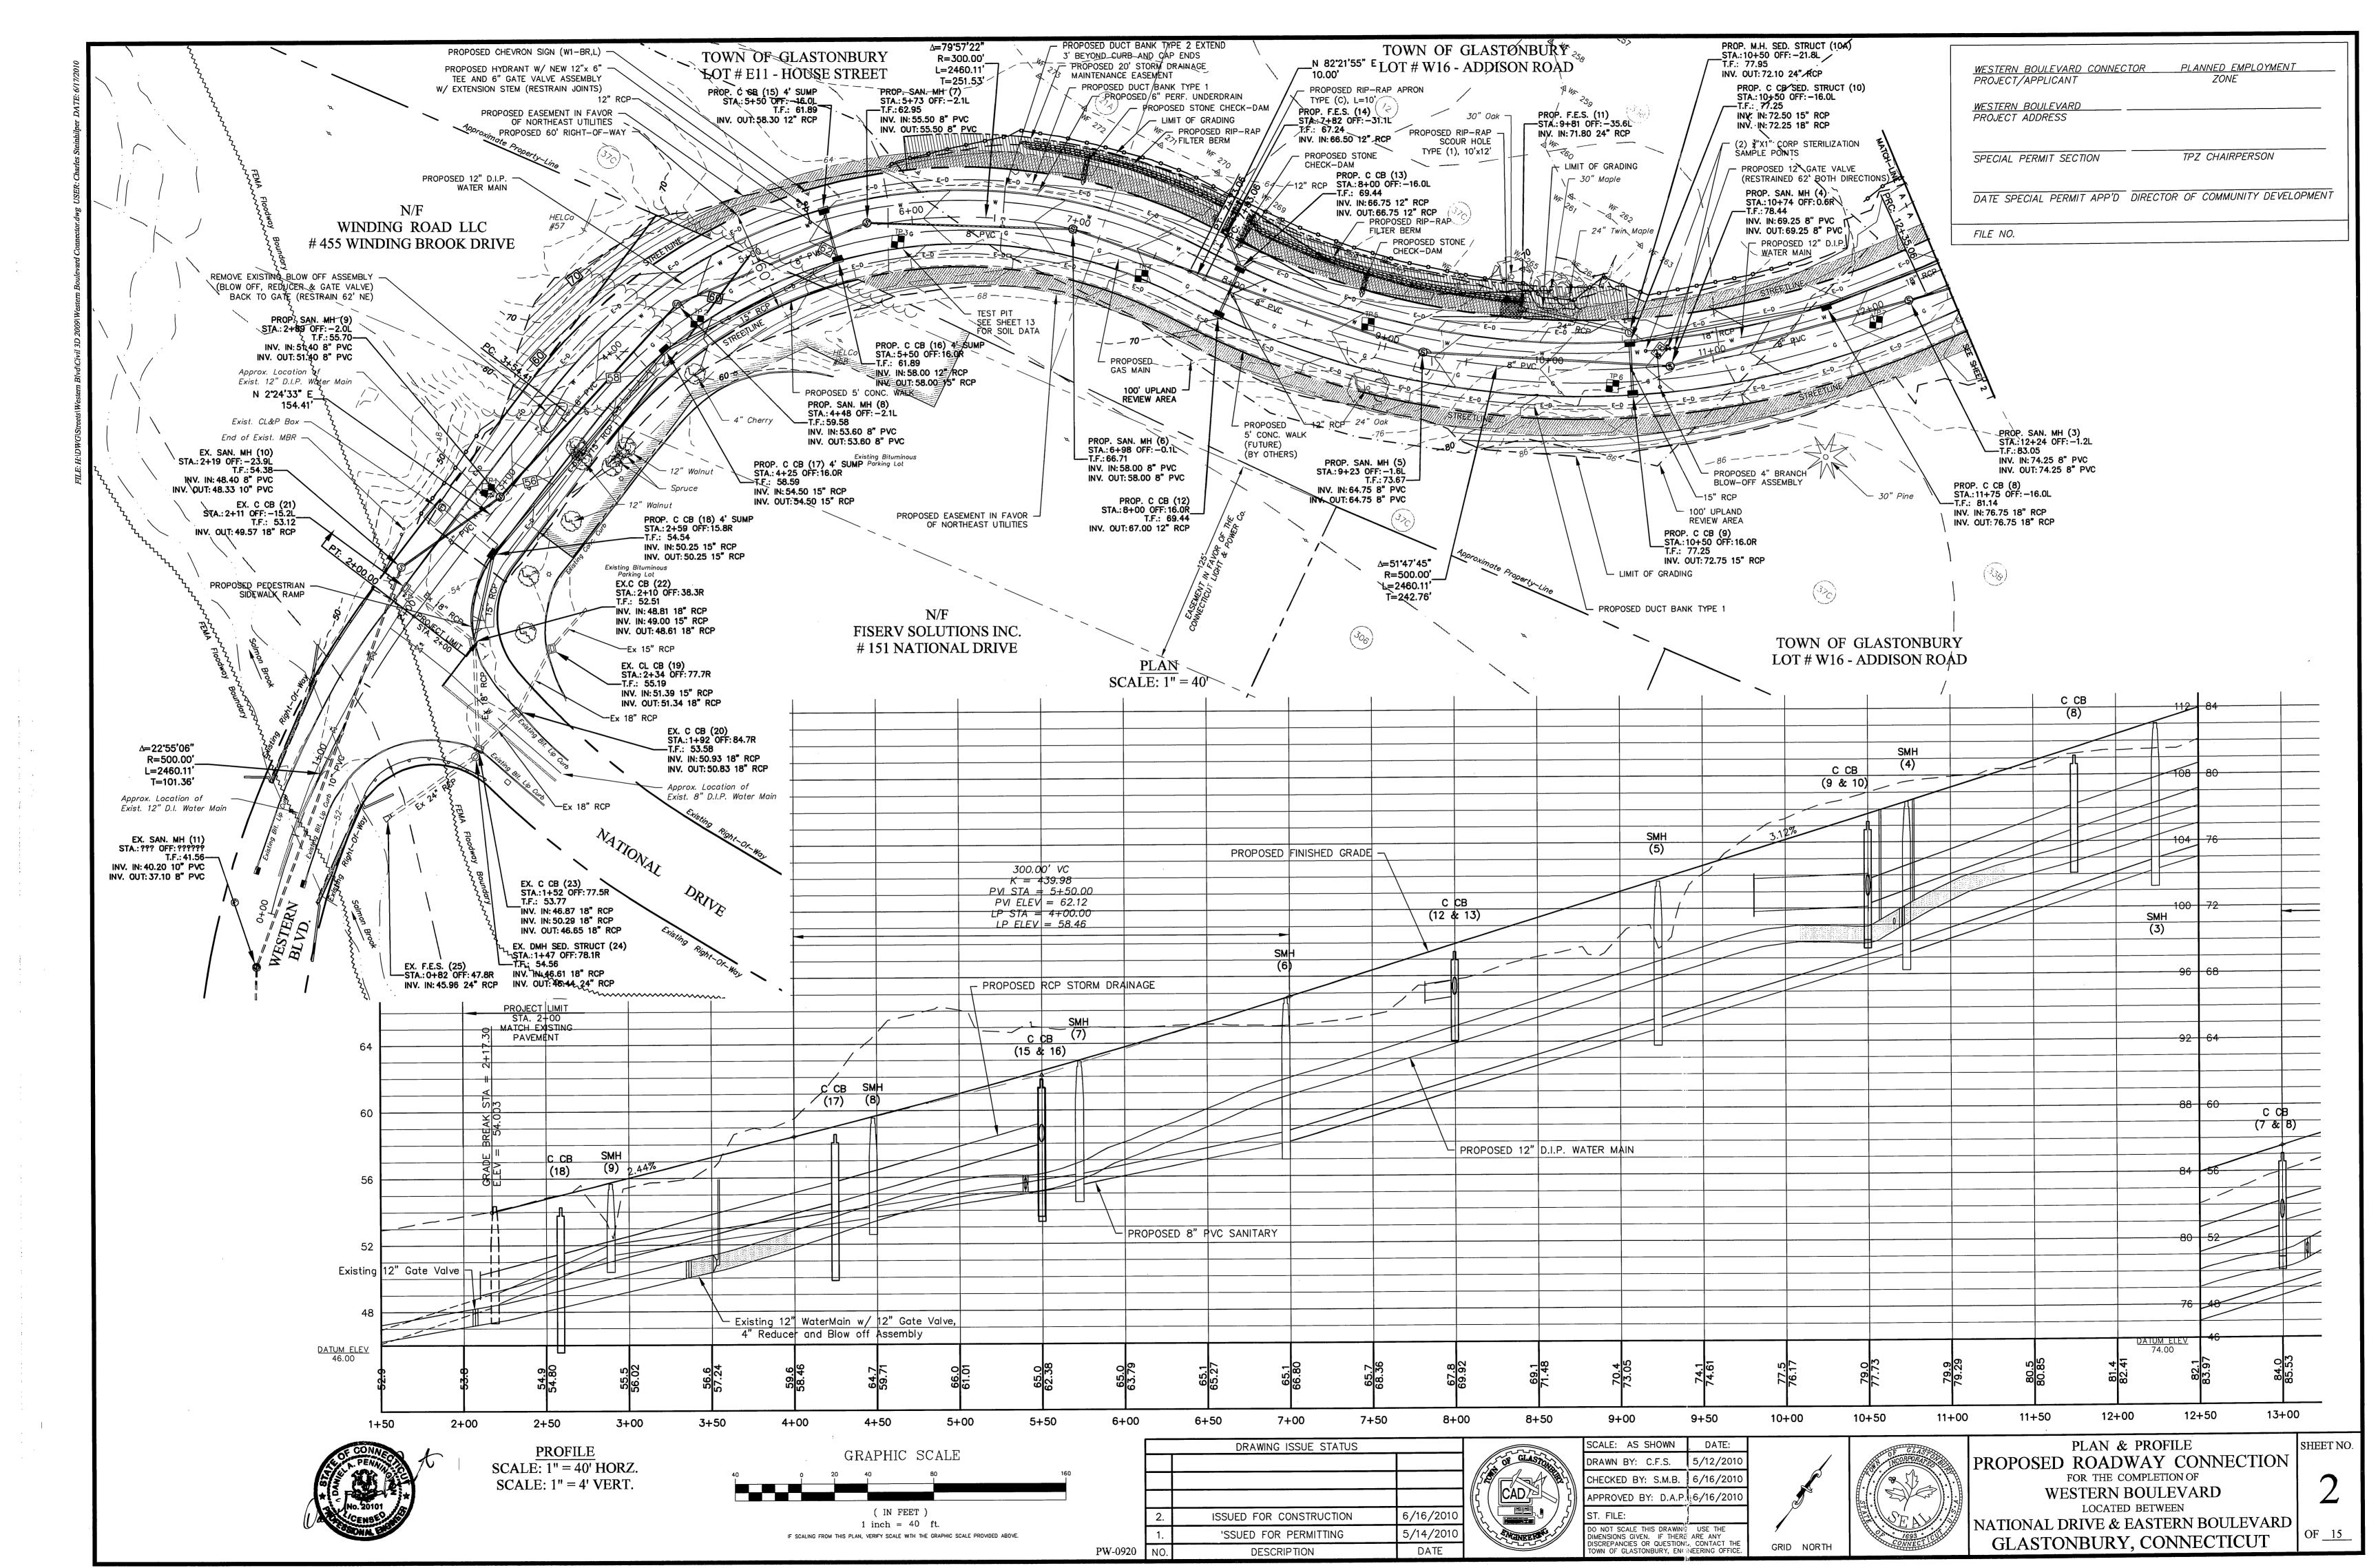


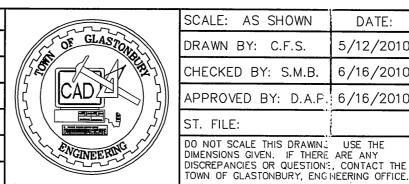





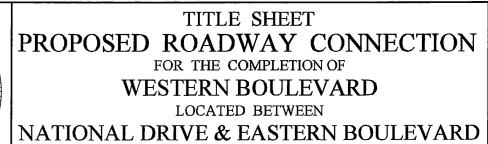


GLASTONBURY, CONNECTICUT



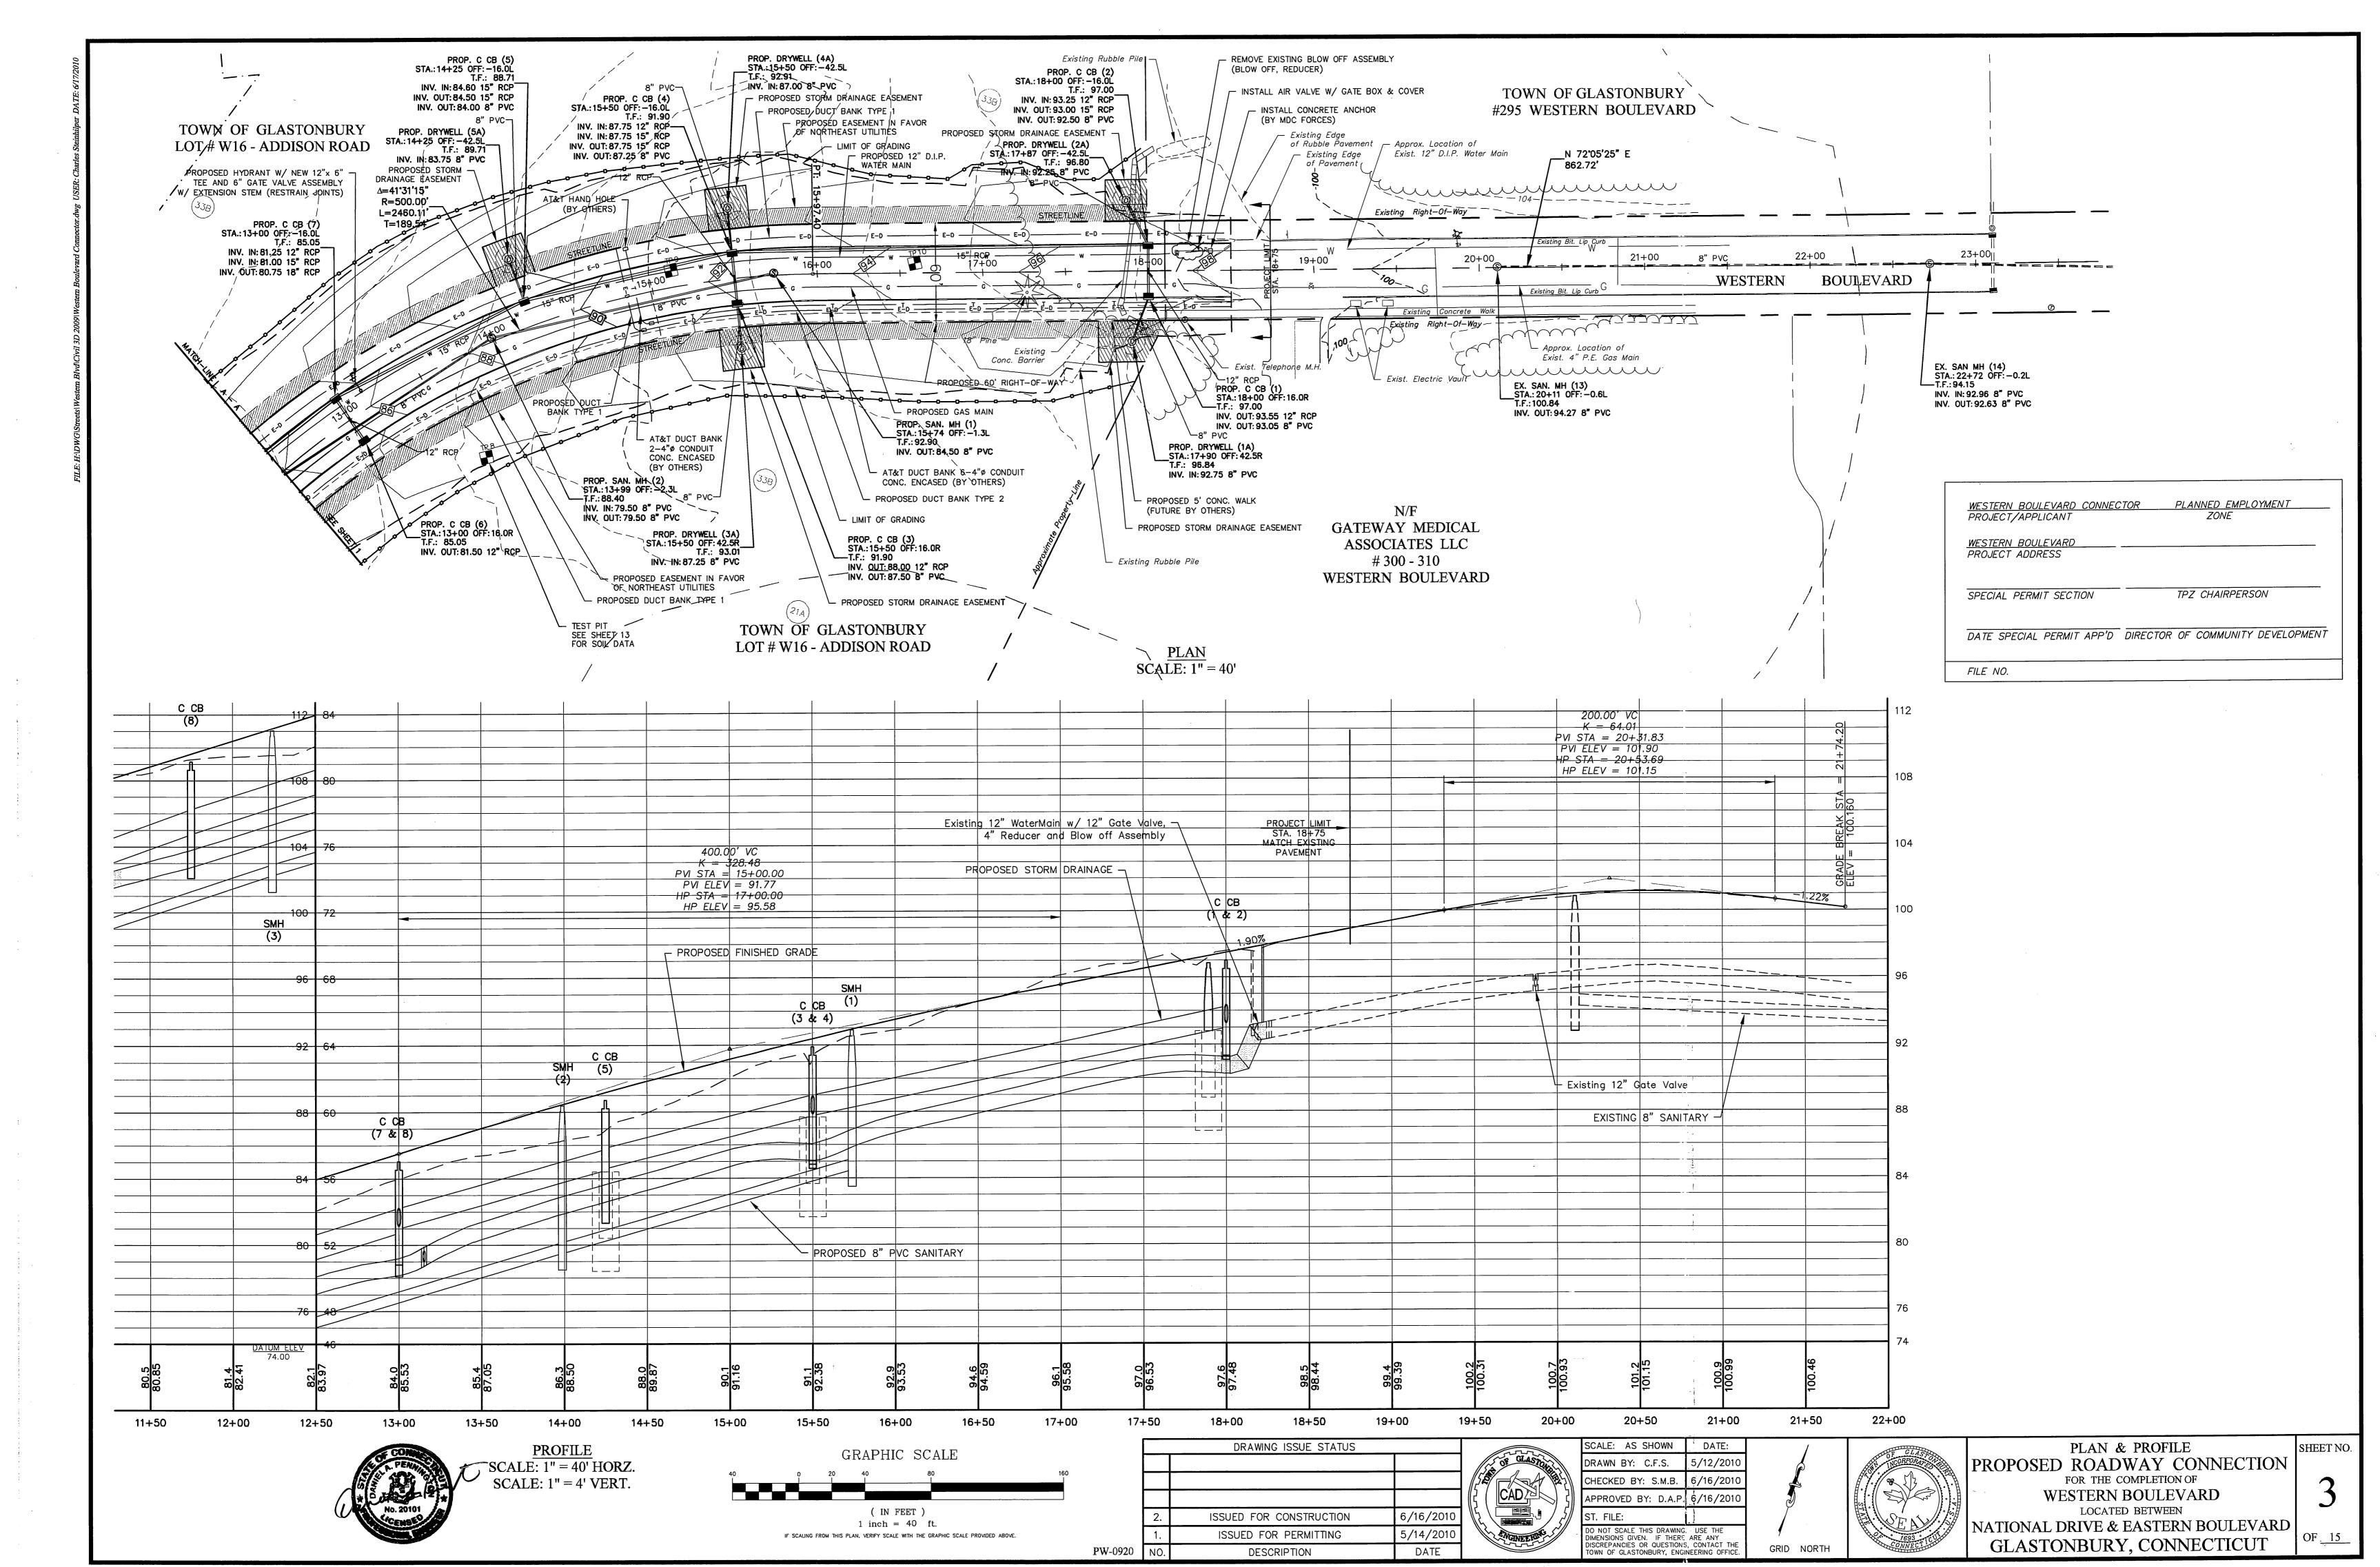

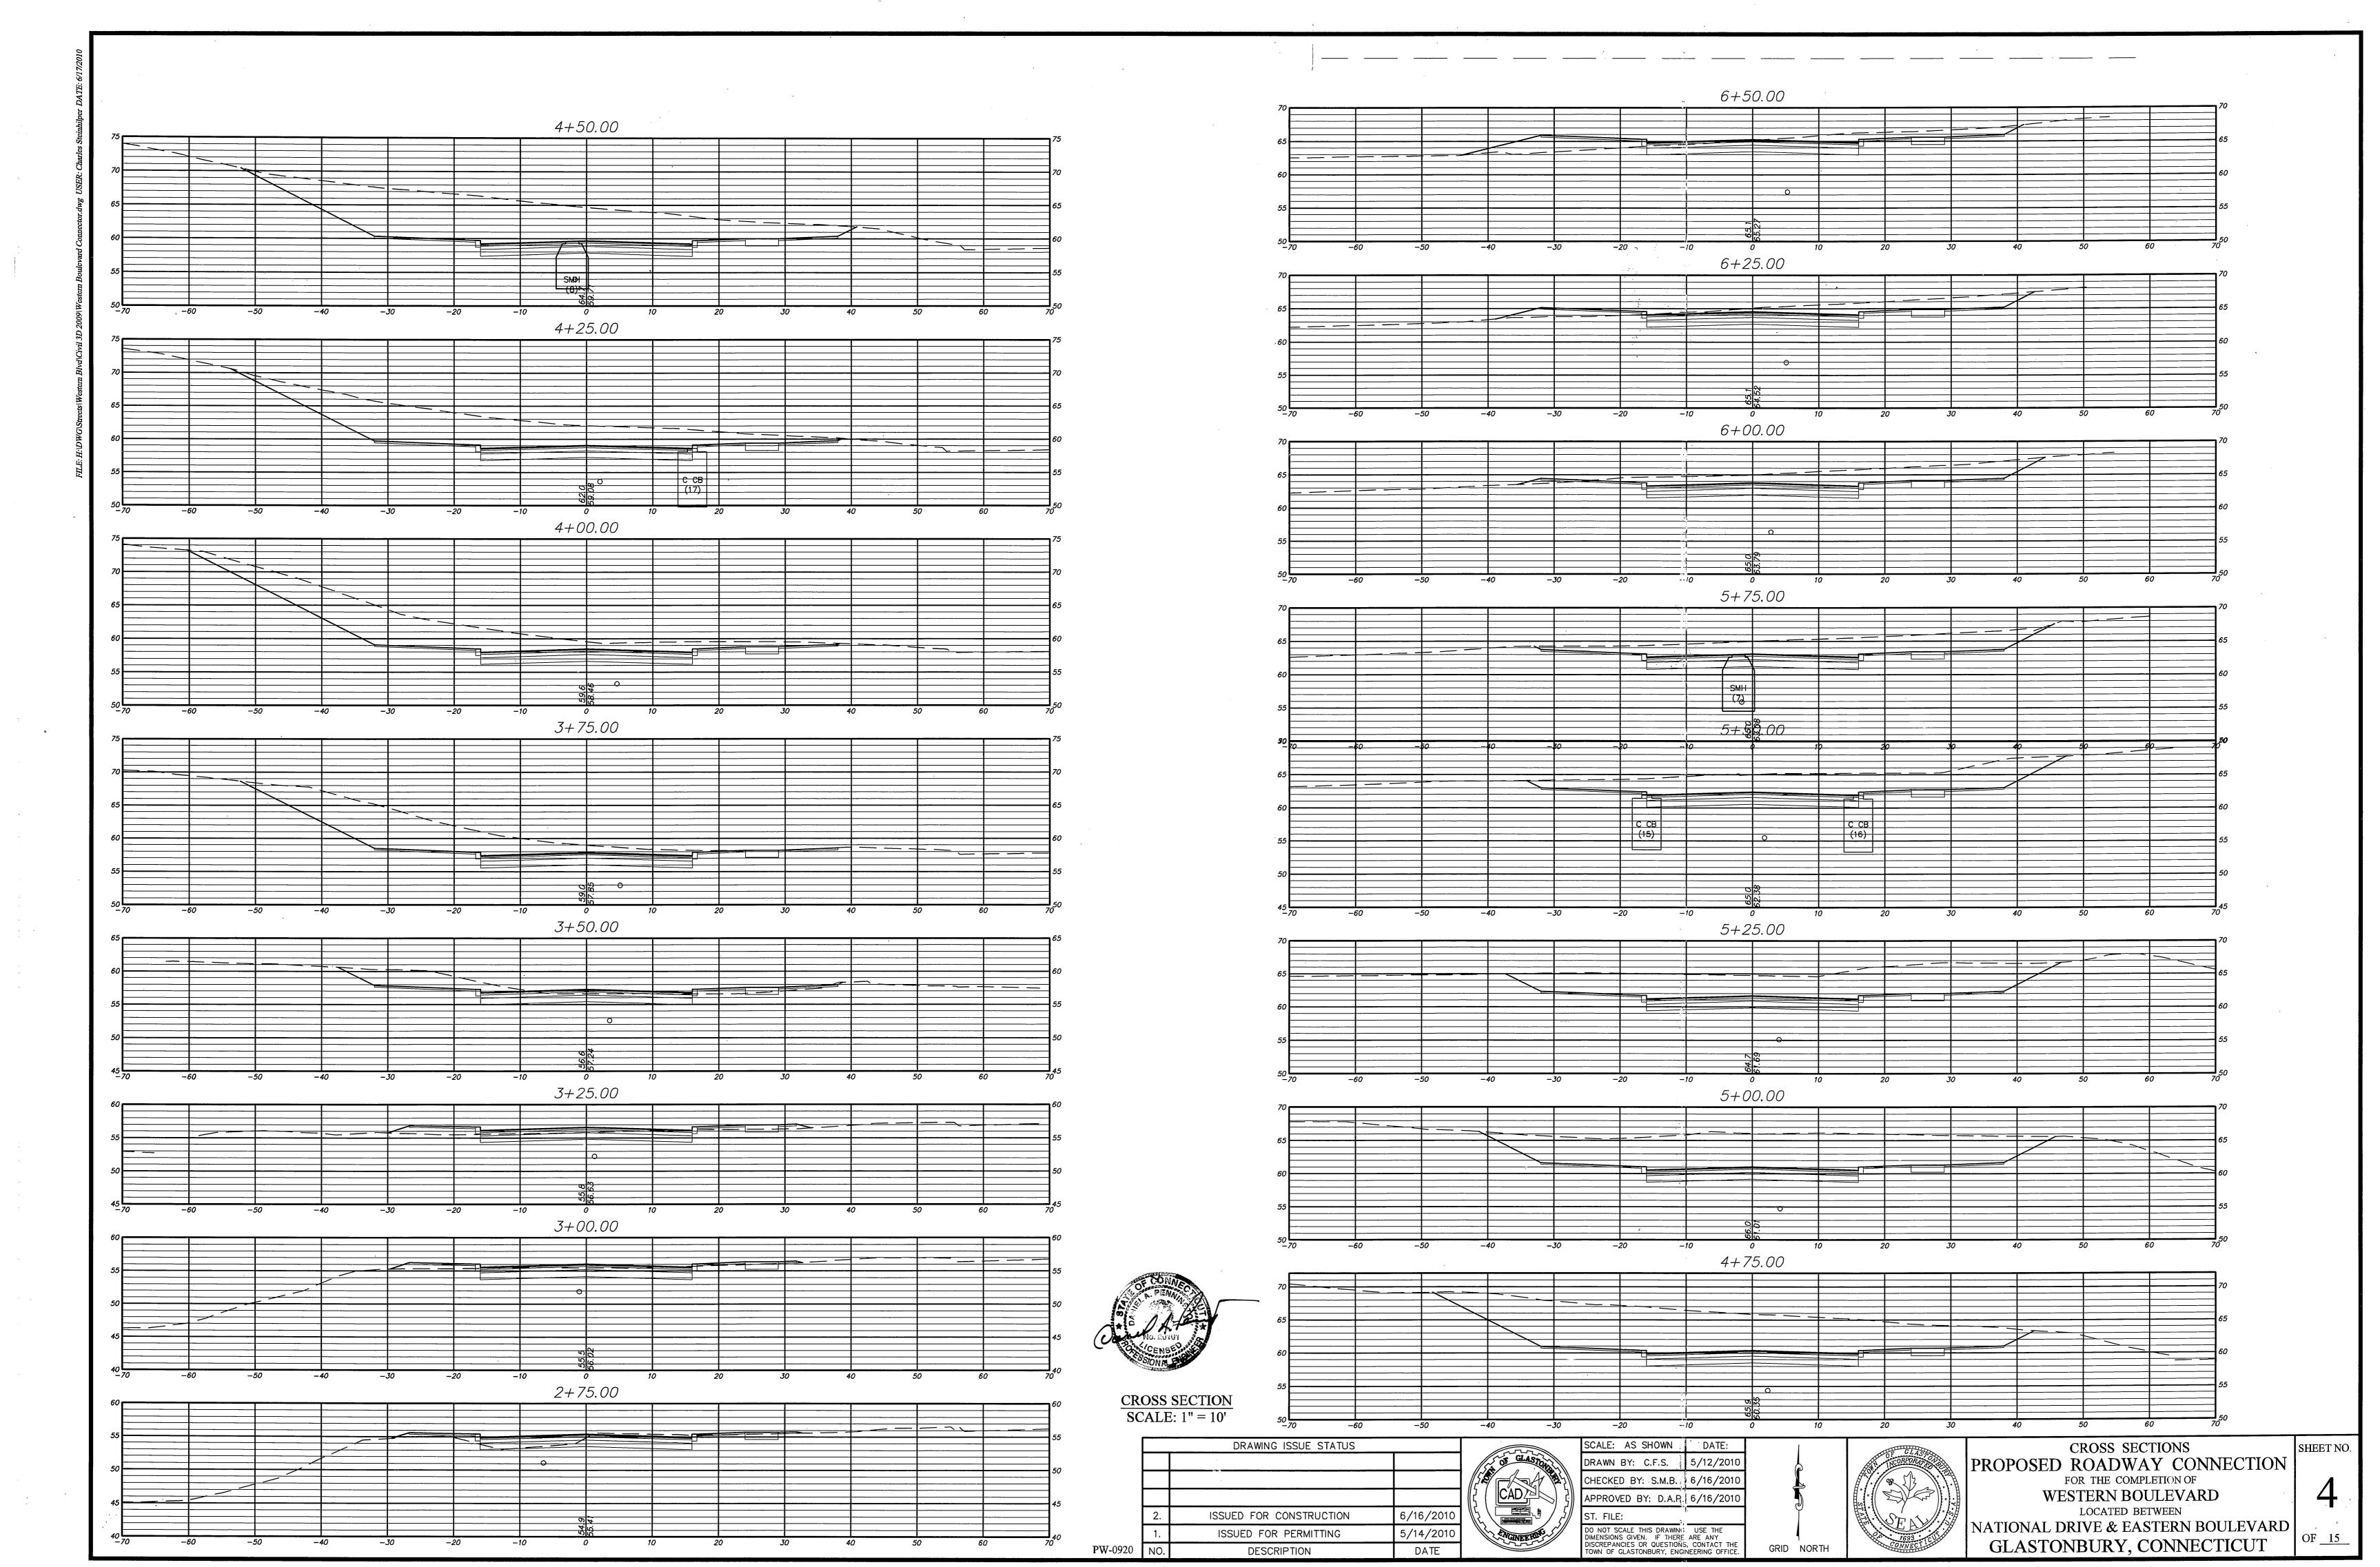

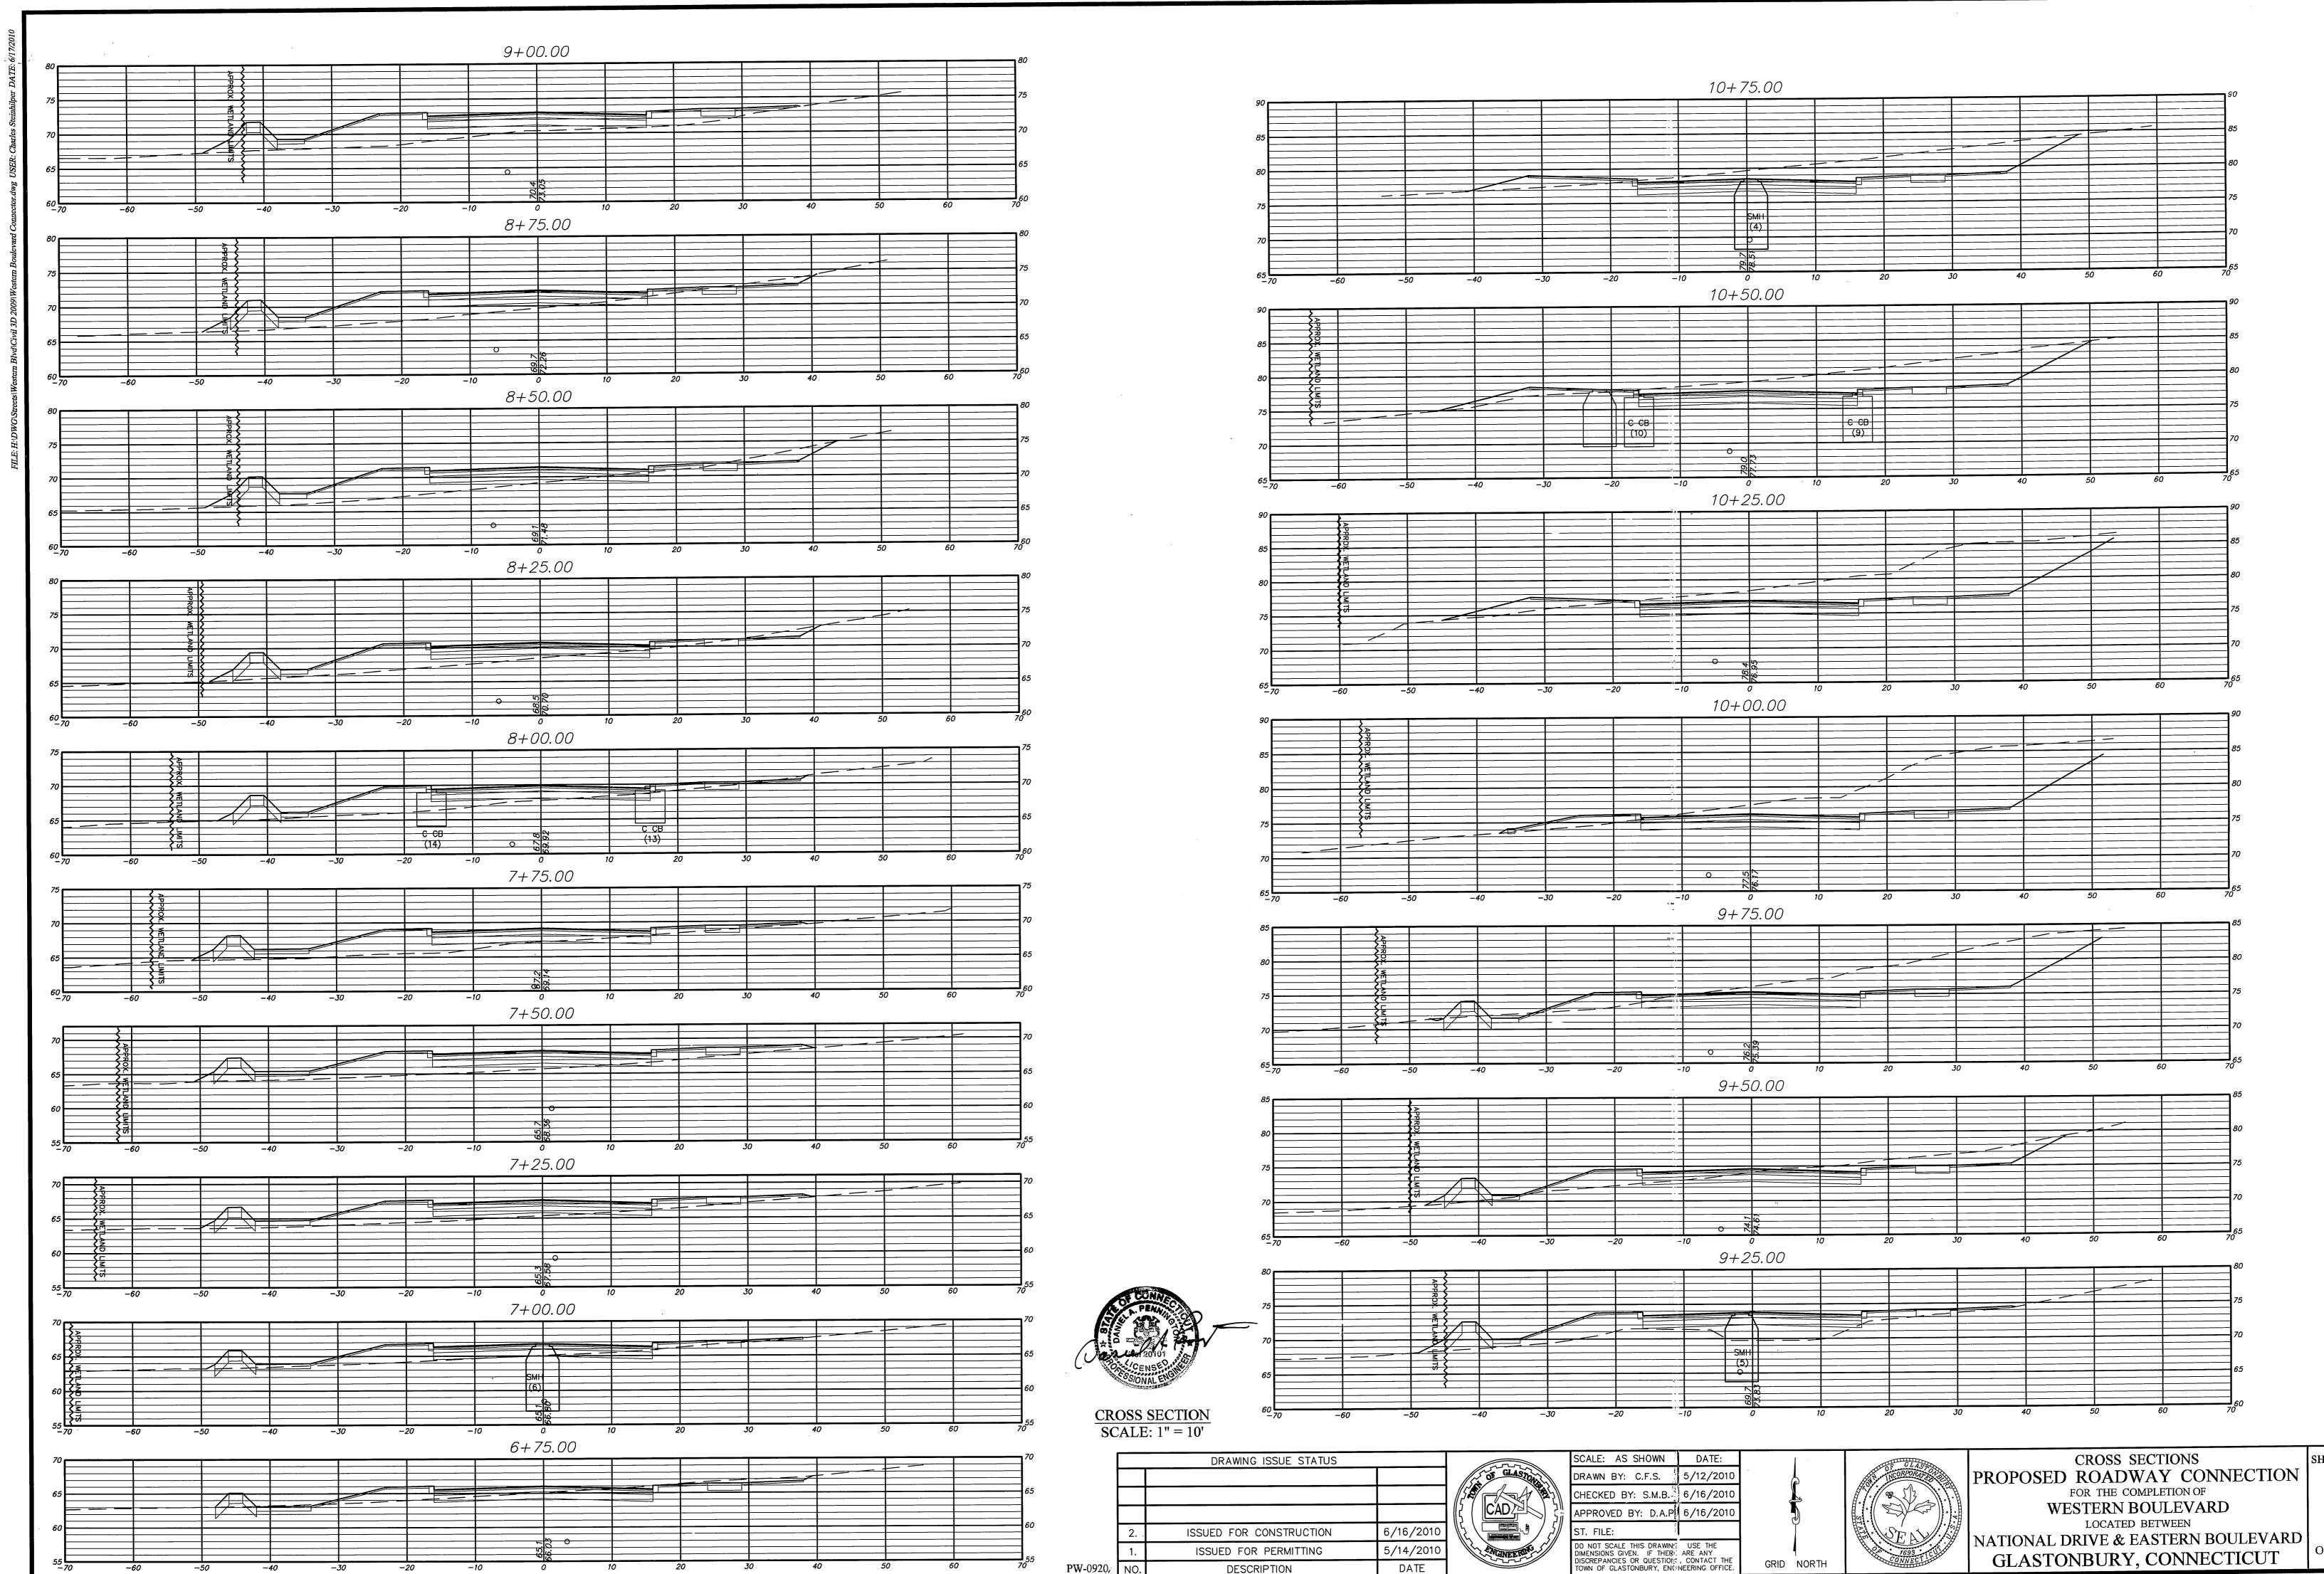

PW-0920, NO.


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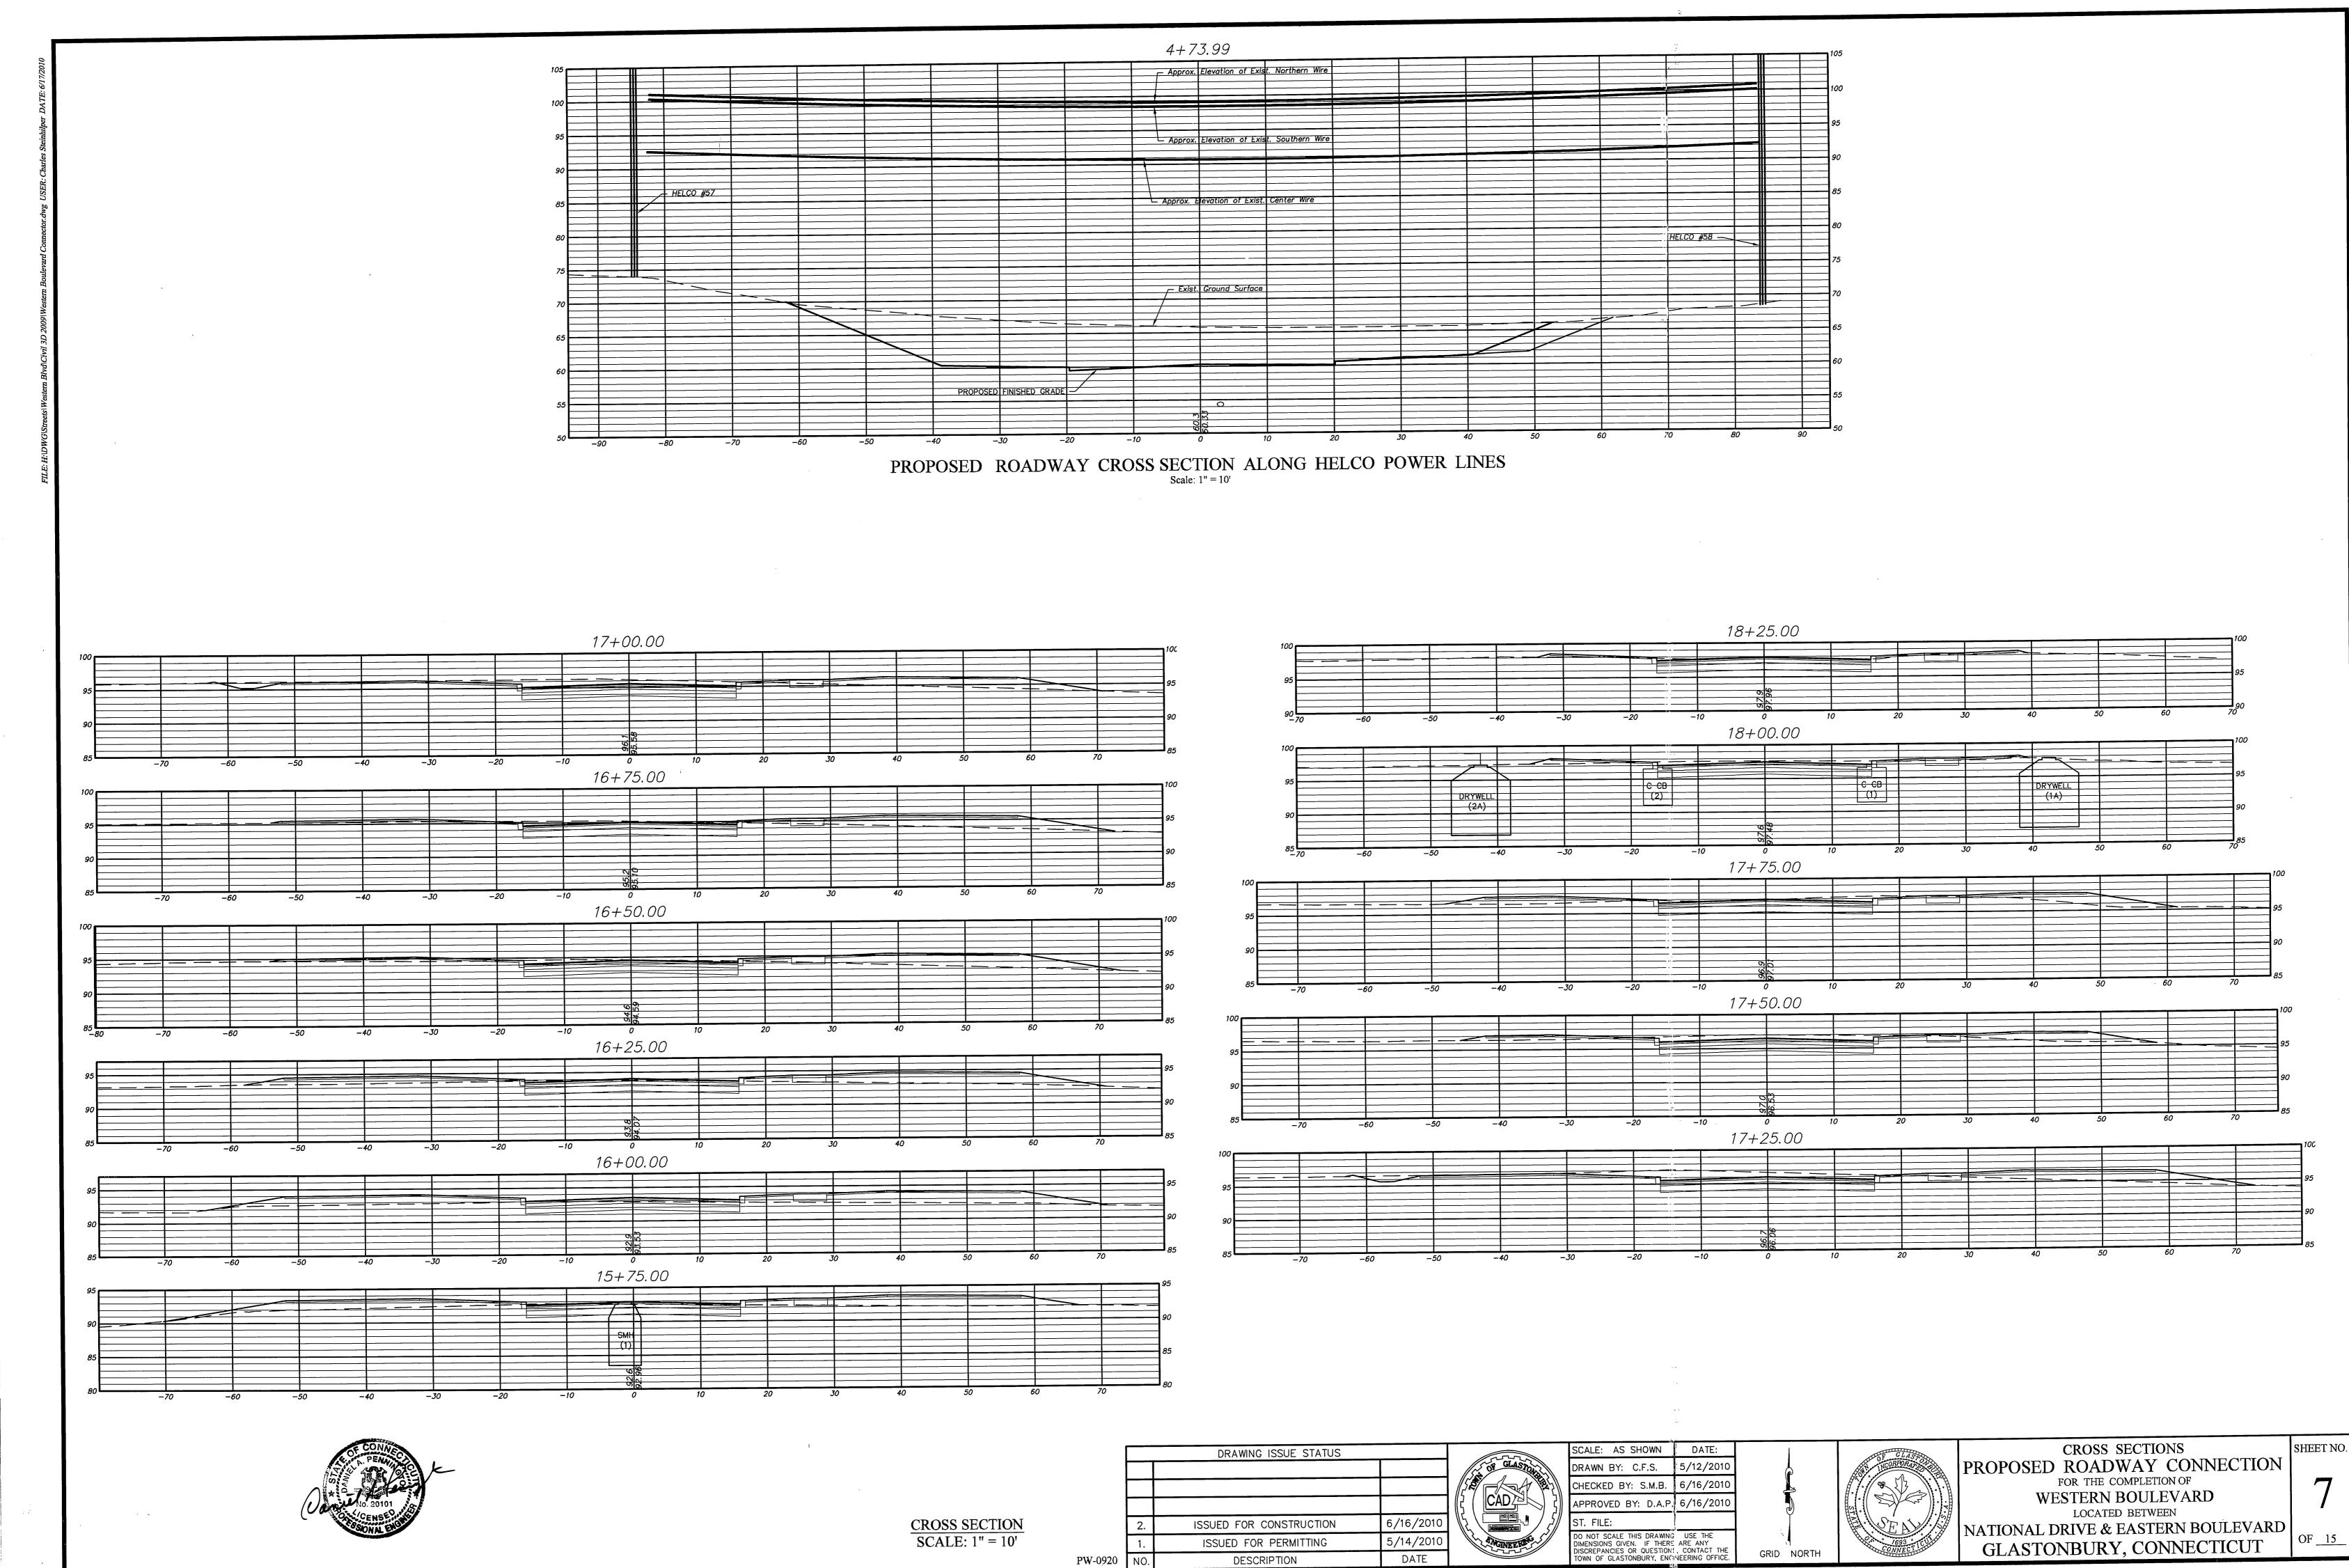
GLASTONBURY, CONNECTICUT


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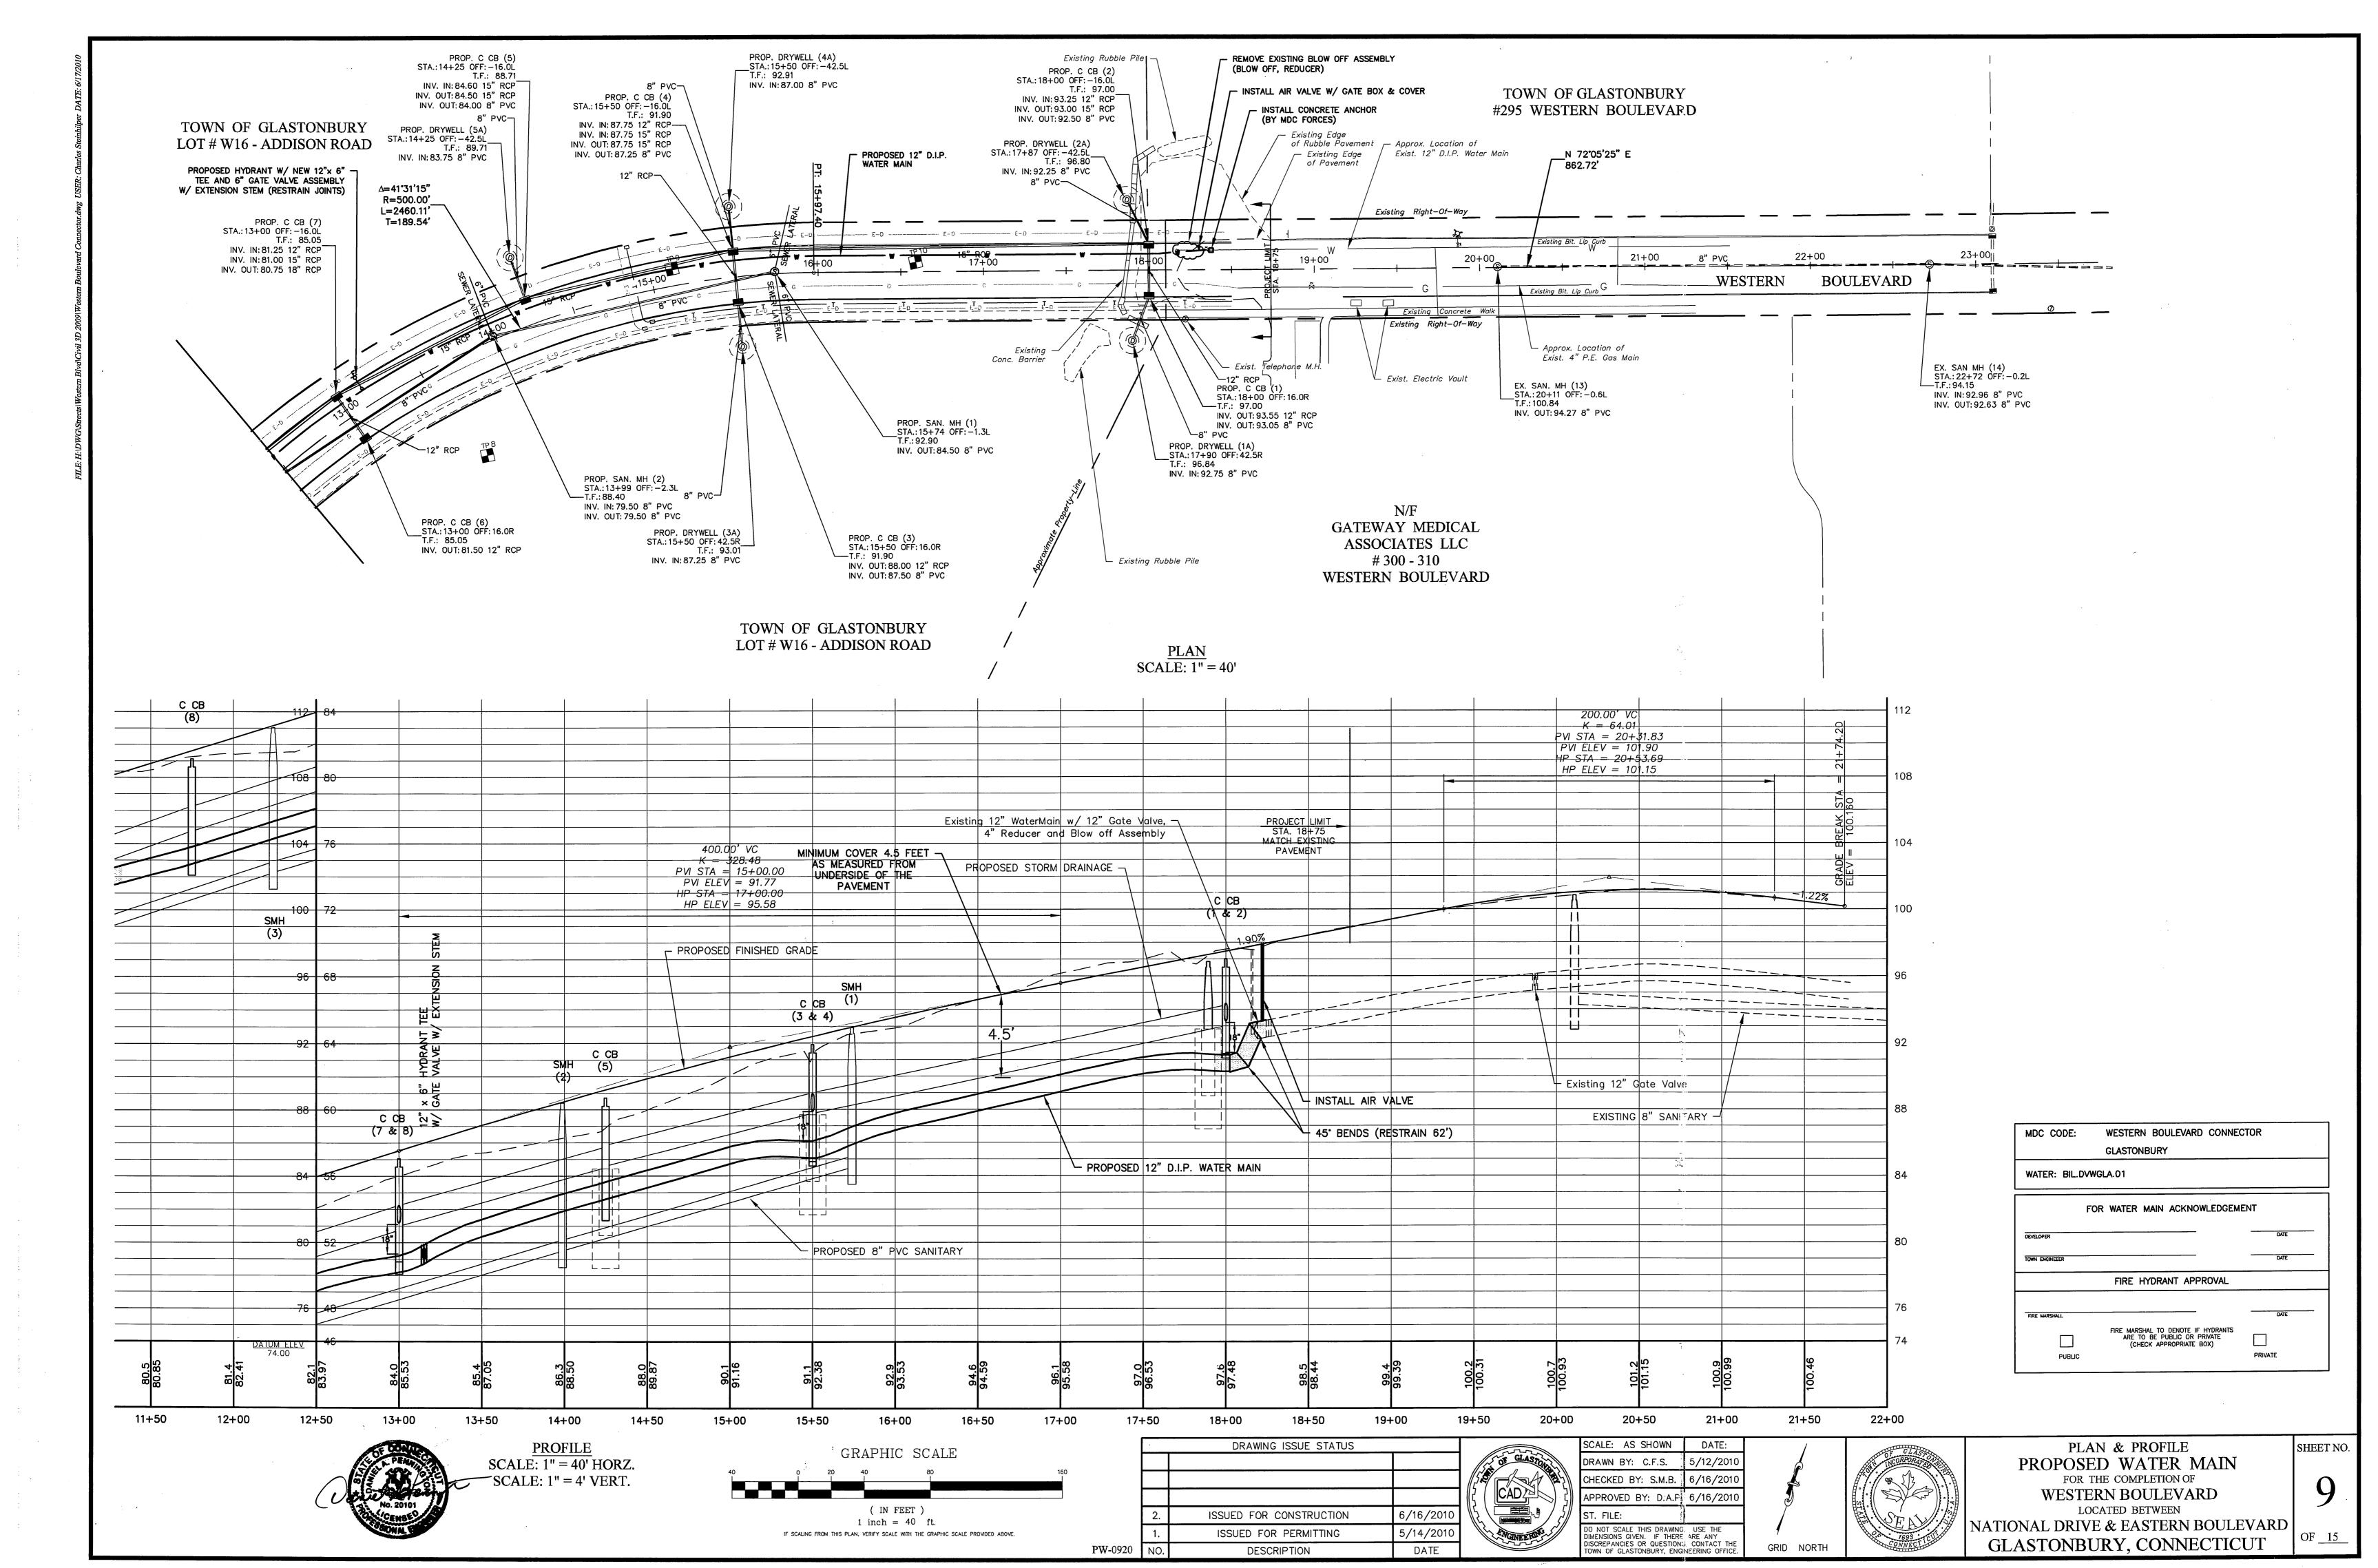
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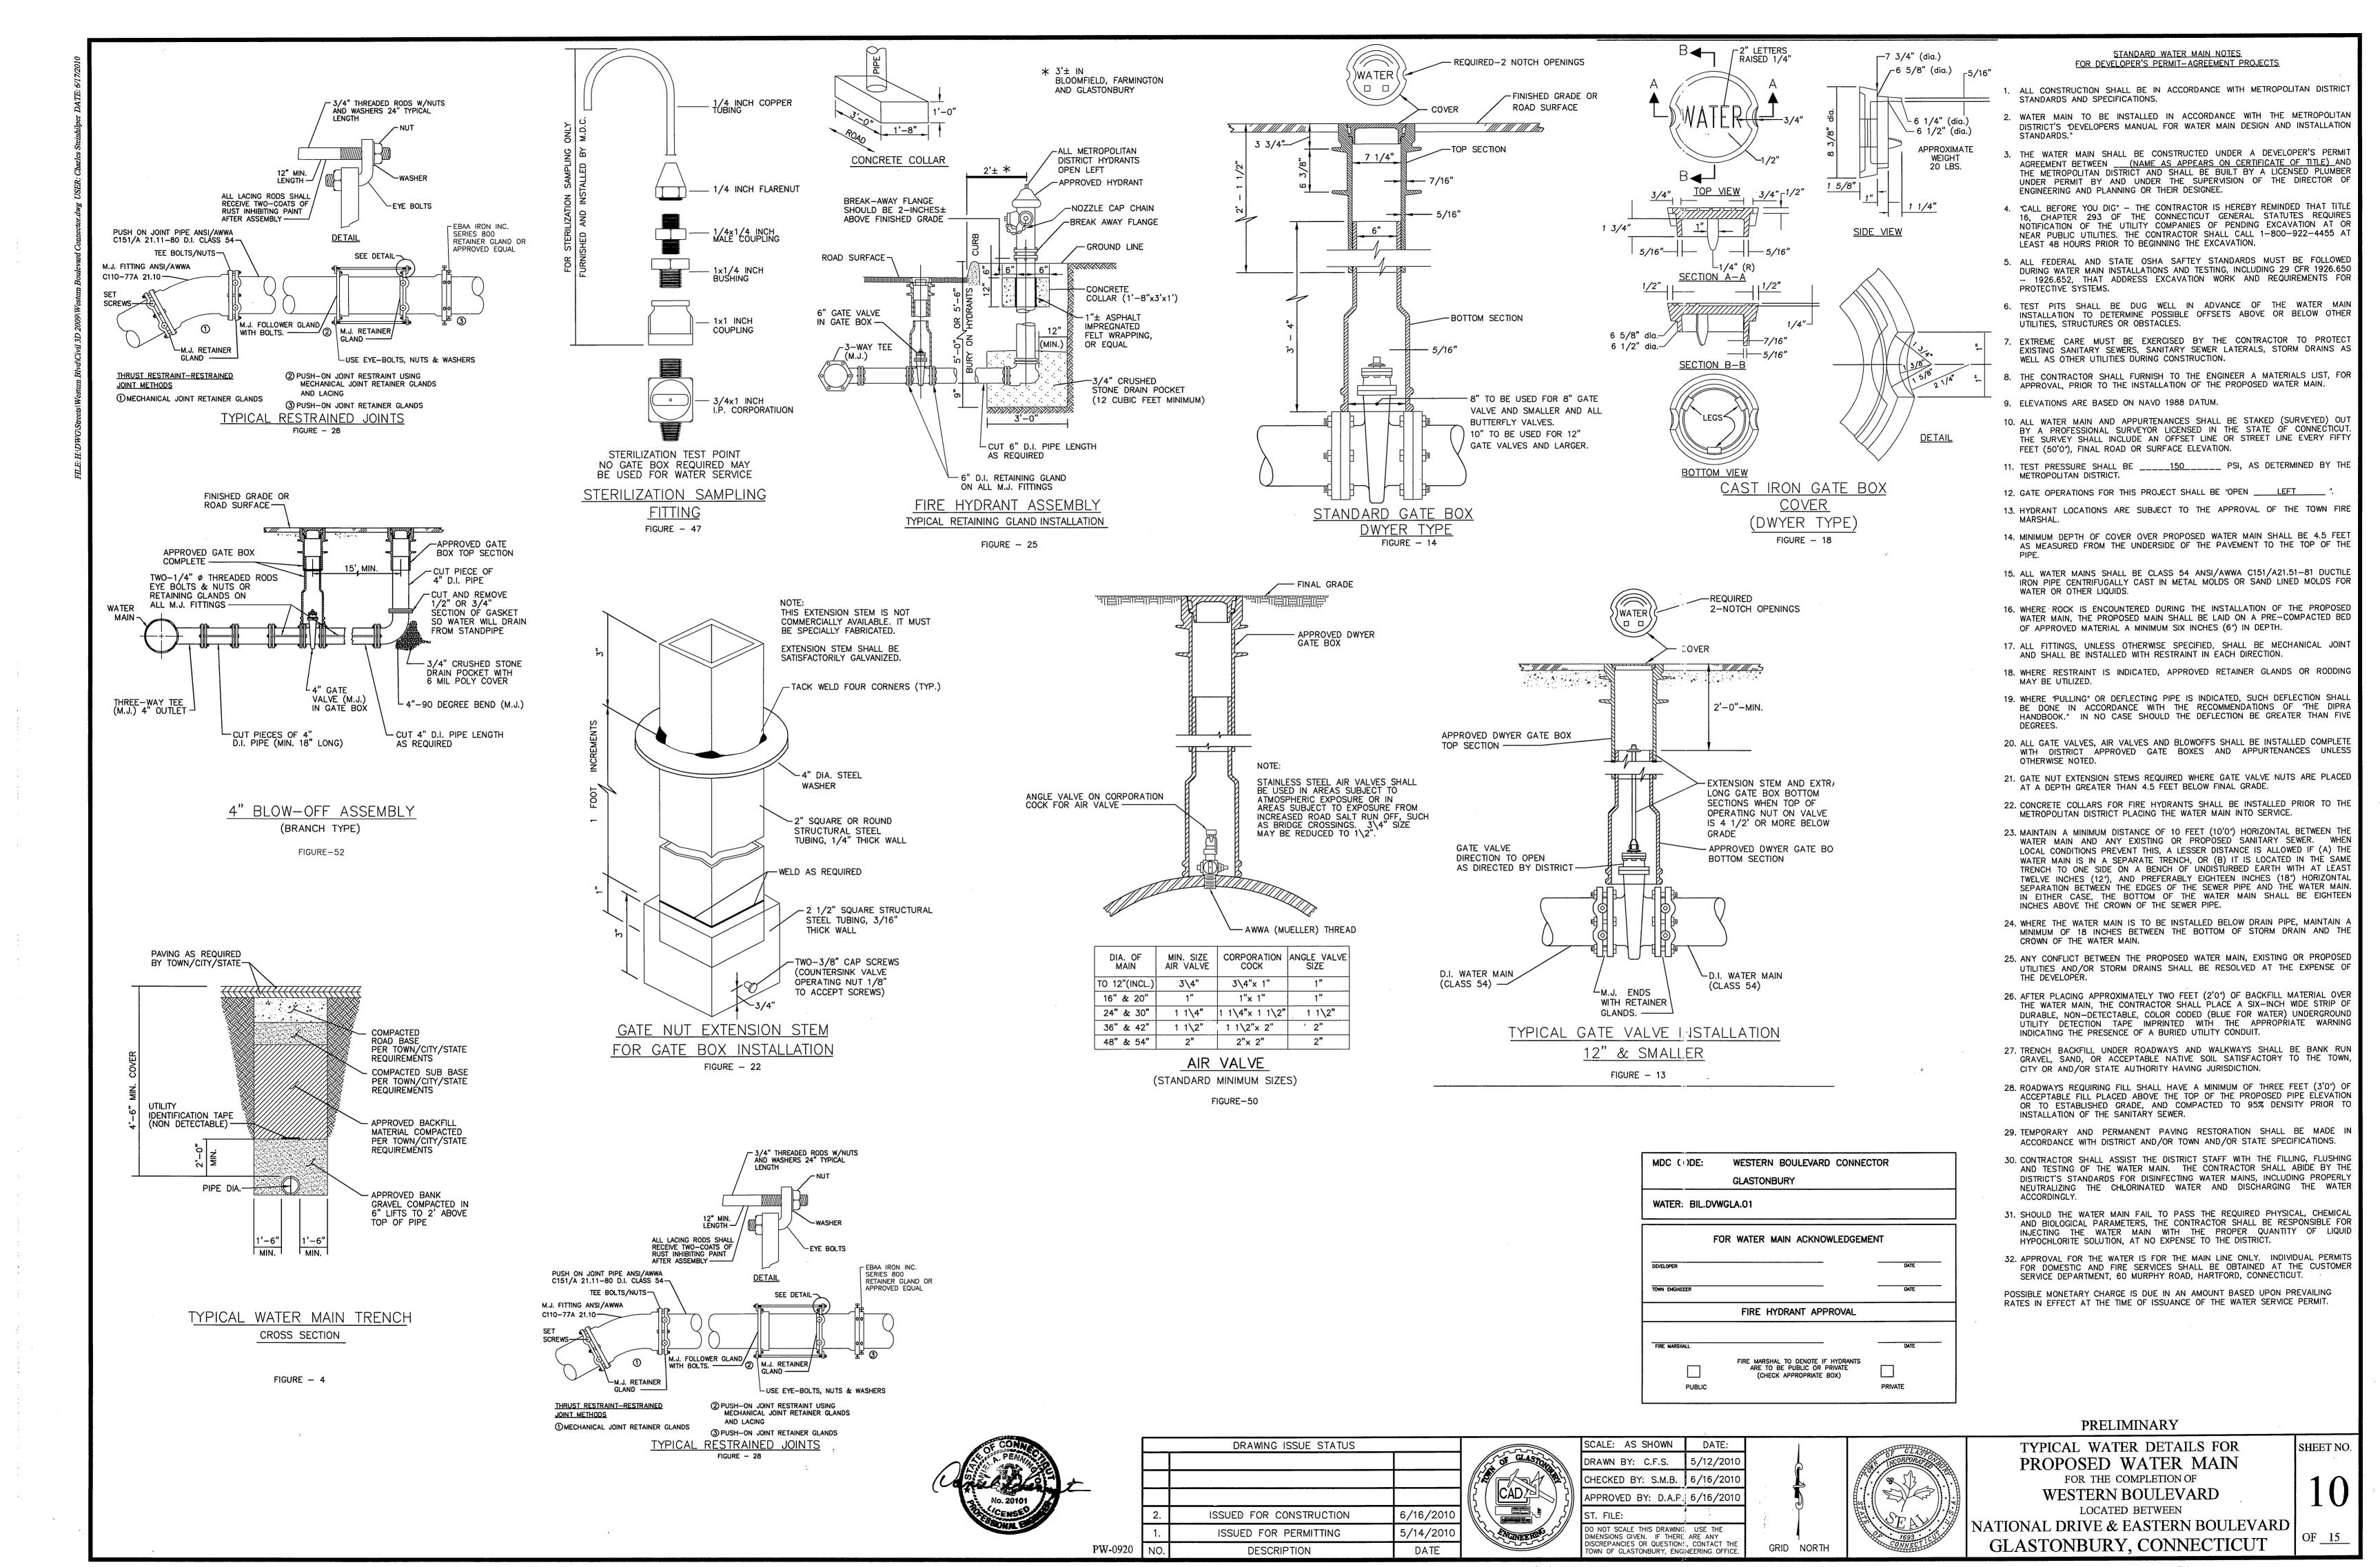
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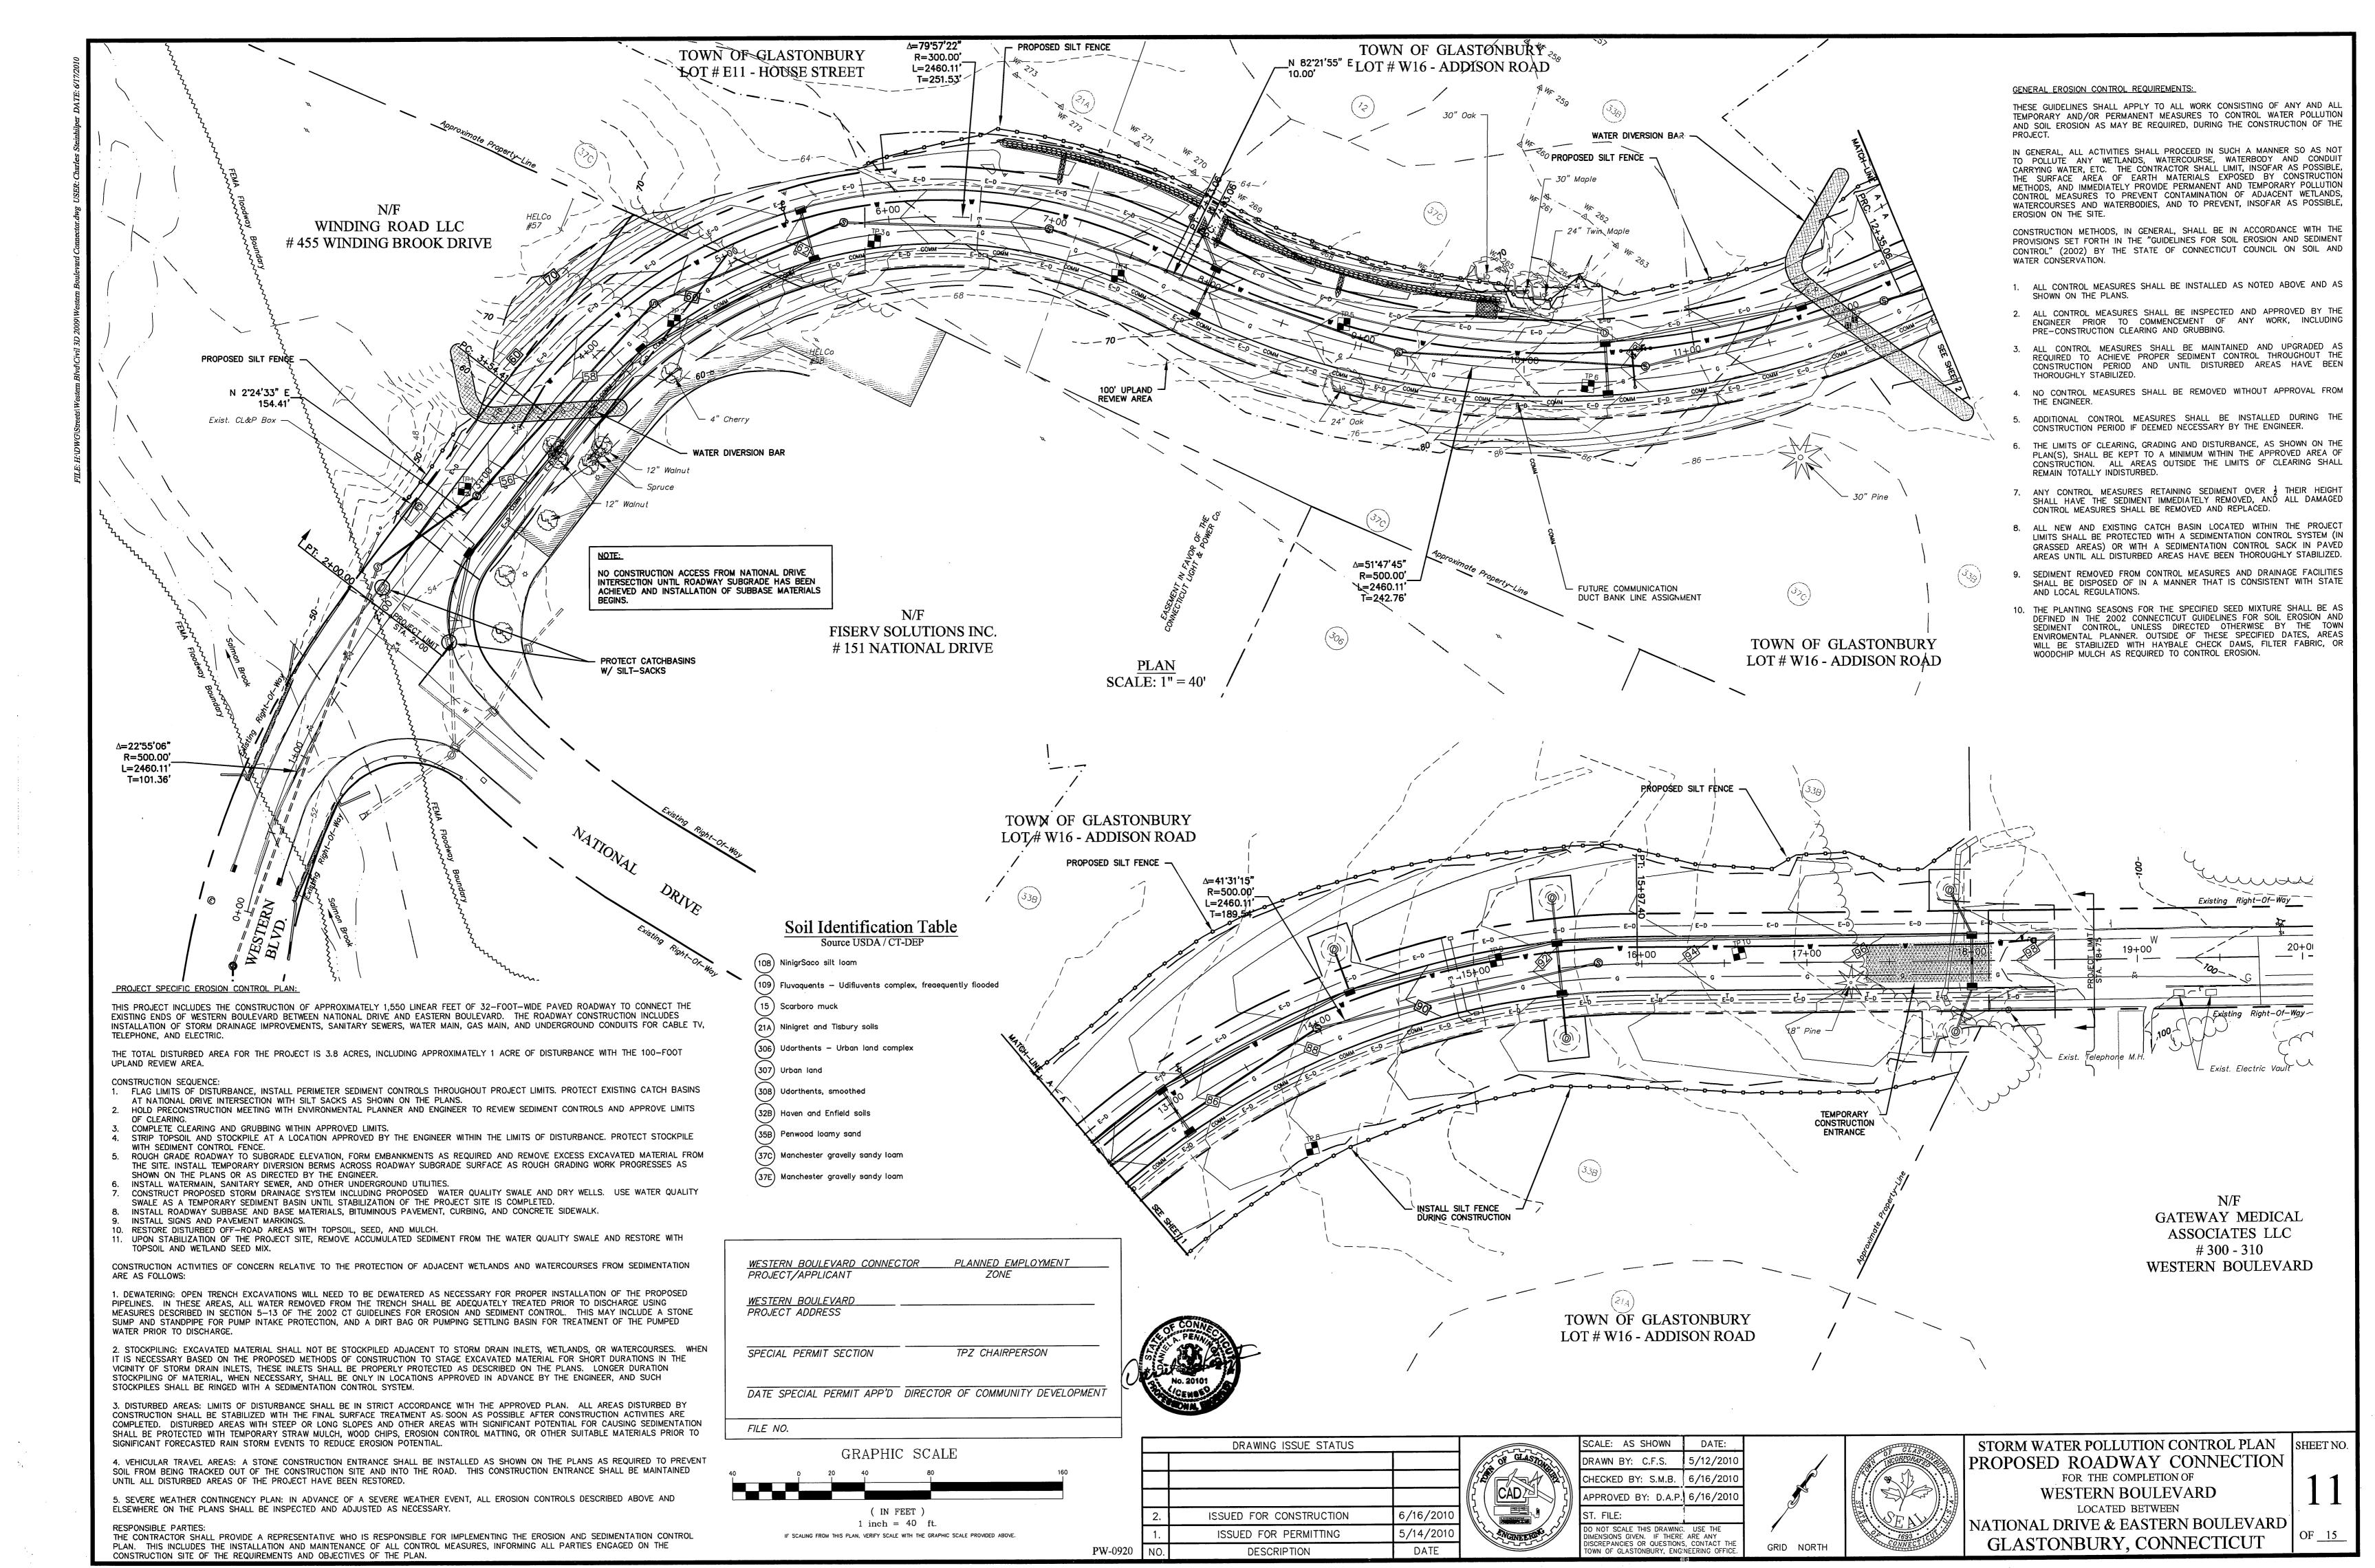








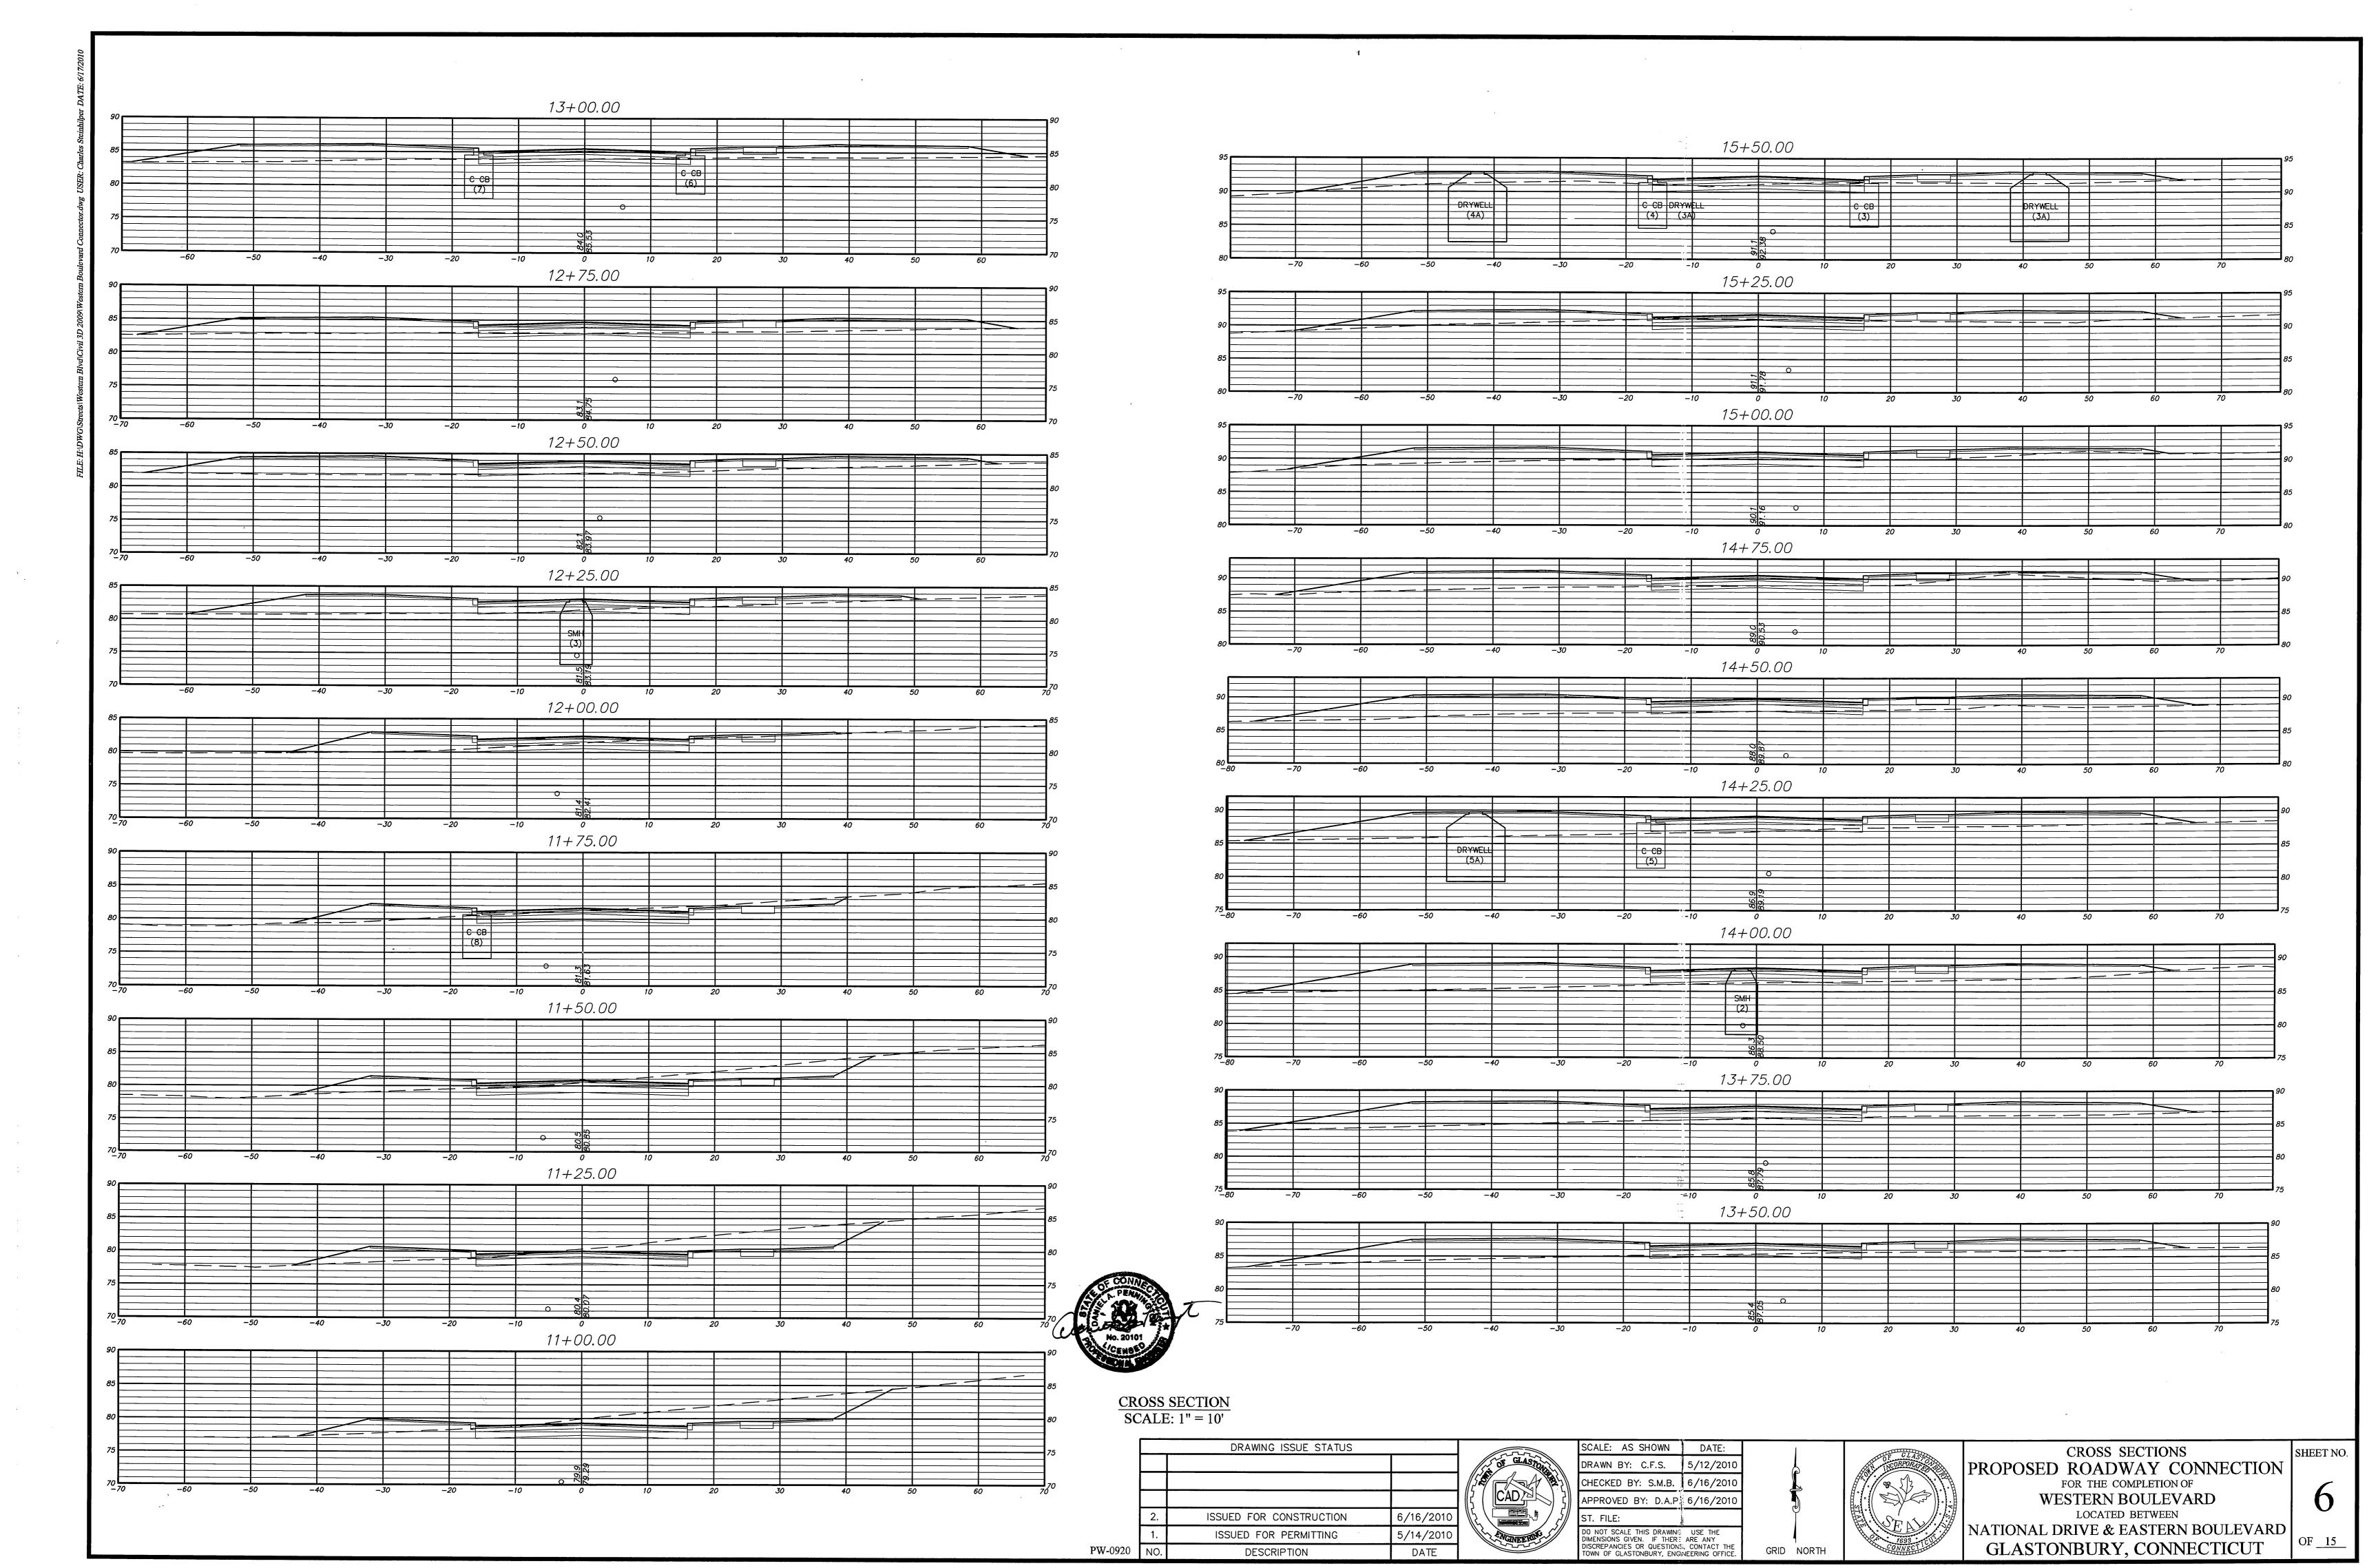

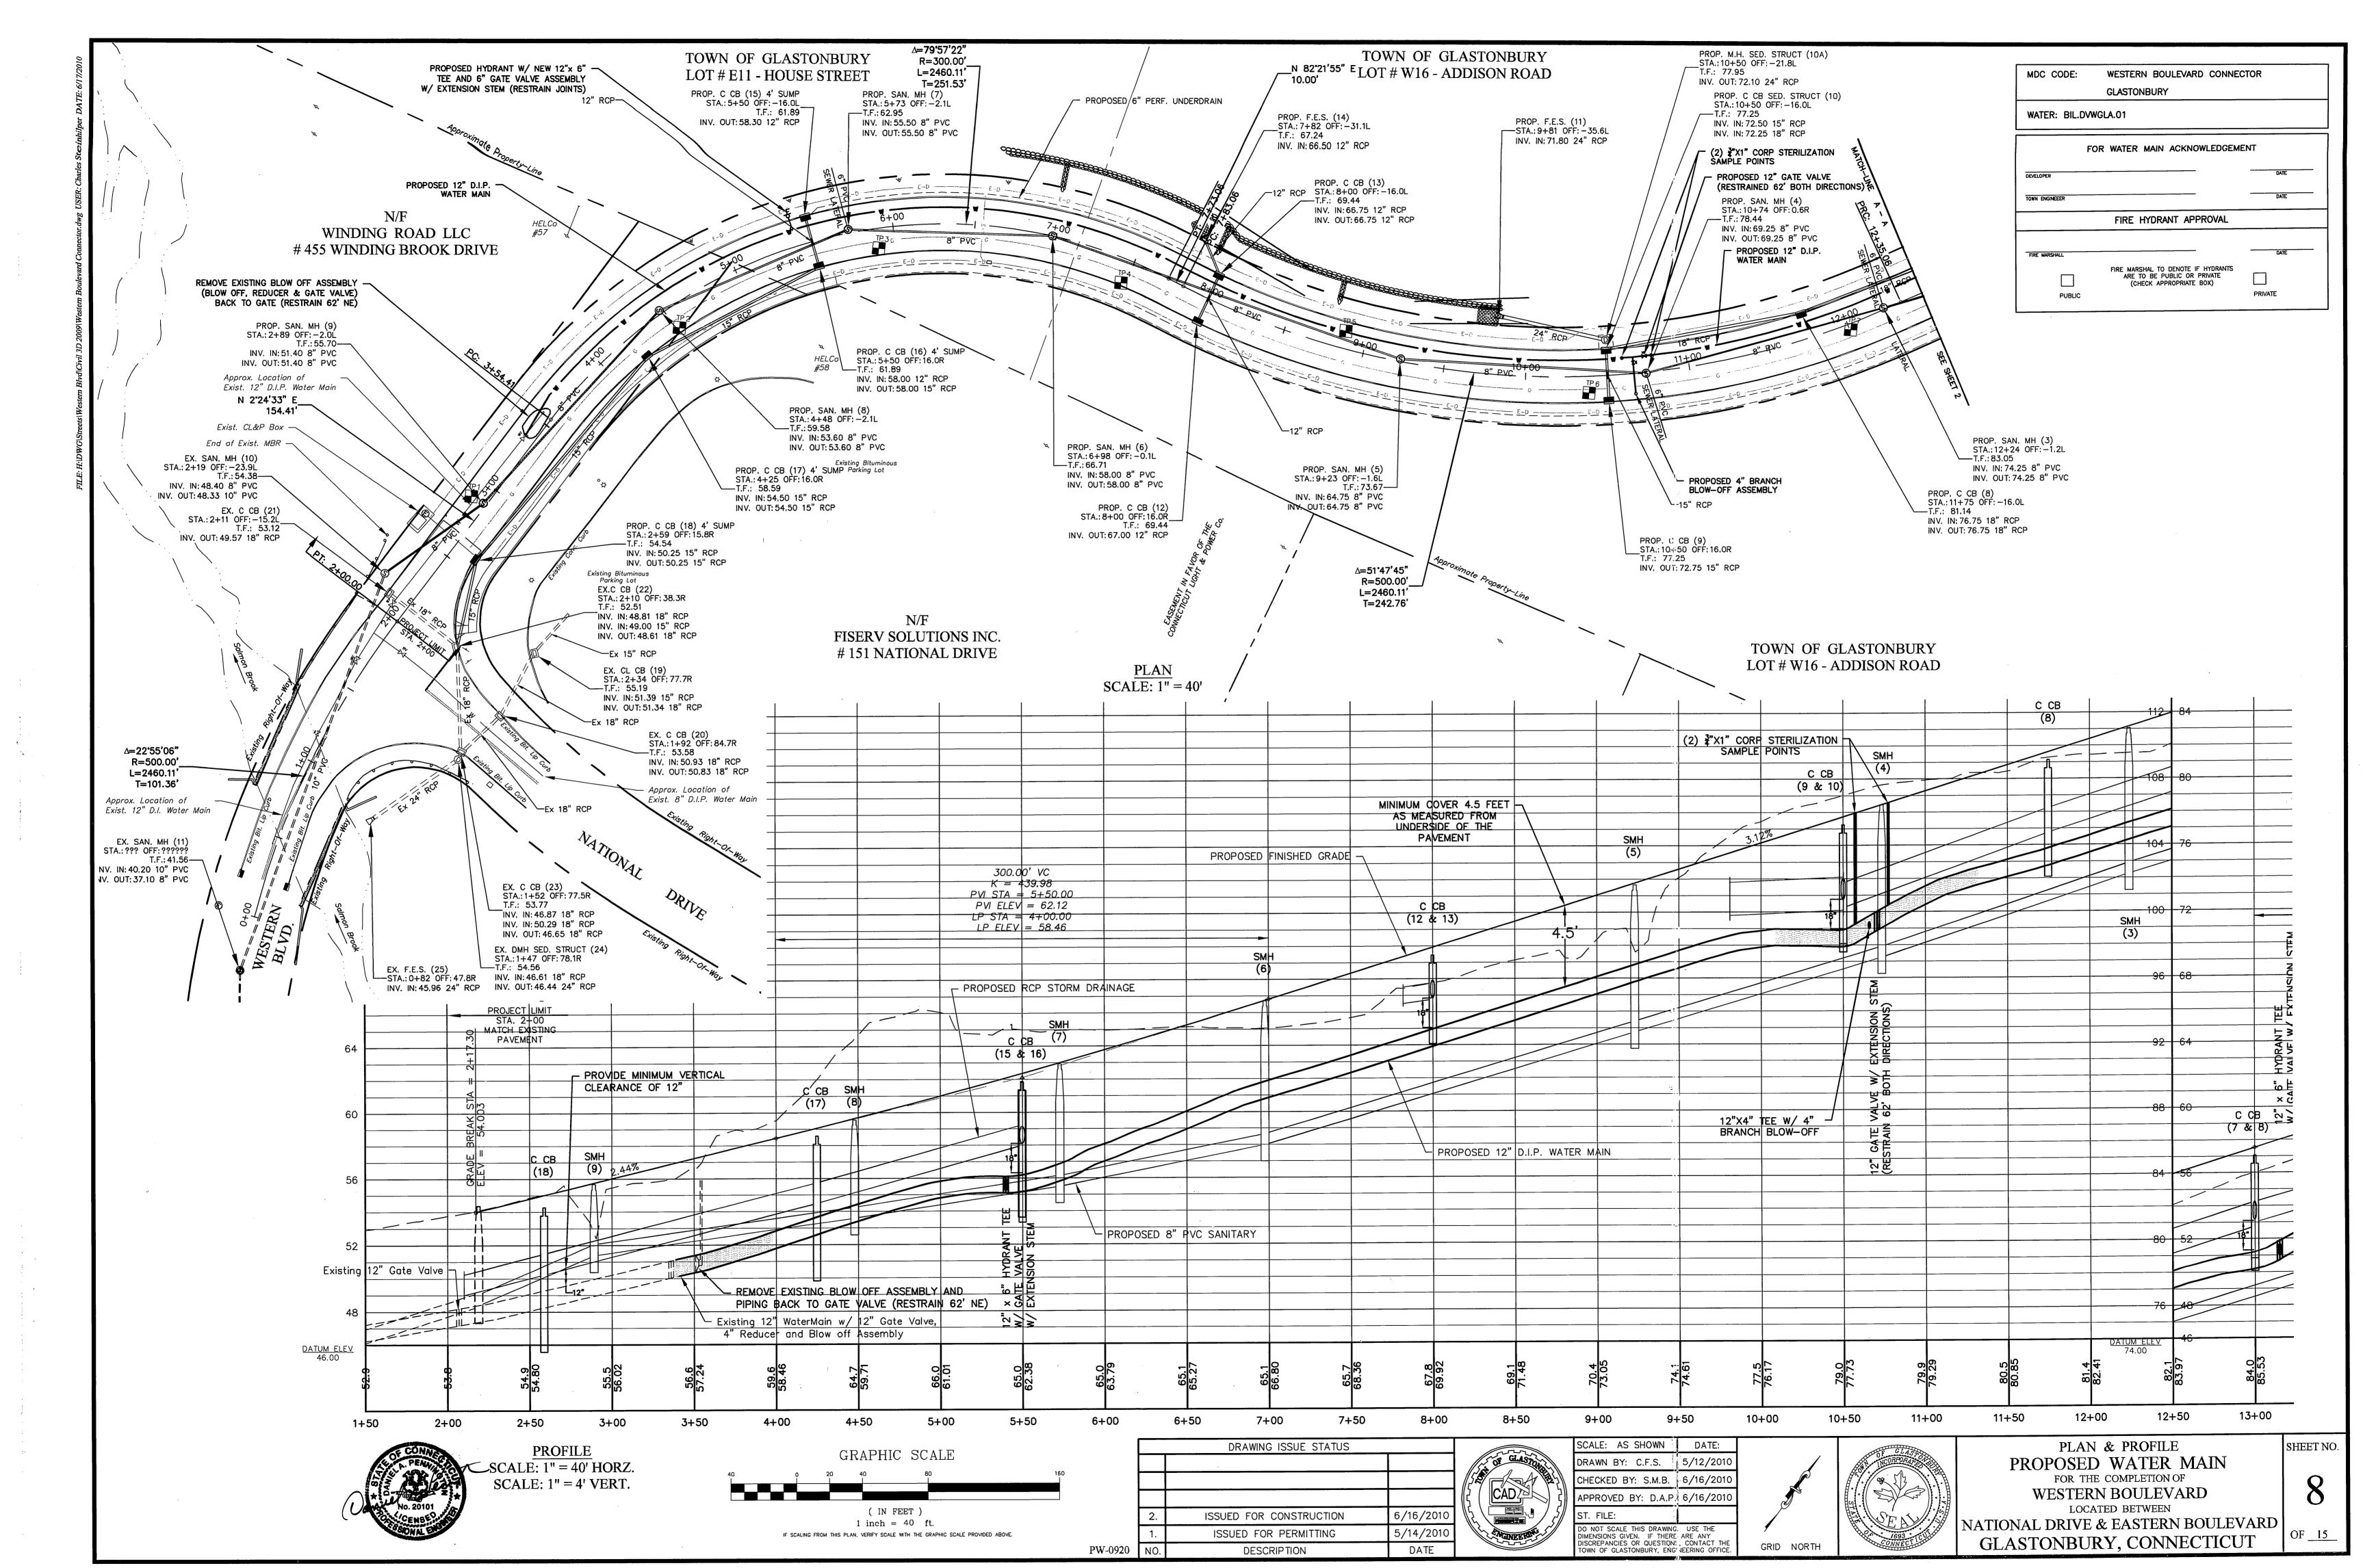

TOWN PLAN AND ZONING COMMISSION ROAD DESIGN AND CONSTRUCTION

APPLICANT: TOWN OF GLASTONBURY

FOR: WESTERN BOULEVARD CONNECTION

MOVED, that the Town Plan and Zoning Commission approve the application of the Town of Glastonbury for design and construction of a Town road – Western Boulevard westerly expansion and connection – Planned Employment Zone, in accordance with the following plans:

"TITLE SHEET PROPOSED ROADWAY CONNECTION FOR THE COMPLETION OF WESTERN BOULEVARD LOCATED BETWEEN NATIONAL DRIVE & EASTERN BOULEVARD GLASTONBURY, CONNECTICUT TOWN OF GLASTONBURY ENGINEERING SHEET NO. 1 OF 15 SCALE: AS SHOWN DRAWN BY: C.F.S. CHECKED BY: S.M.B. APPROVED BY: D.A.P. DATE: 5/12/2010 DRAWING ISSUE STATUS NO.1 ISSUED FOR PERMITTING 5/14/2010 PW-0920"

"PLAN & PROFILE PROPOSED ROADWAY CONNECTION FOR THE COMPLETION OF WESTERN BOULEVARD LOCATED BETWEEN NATIONAL DRIVE & EASTERN BOULEVARD GLASTONBURY, CONNECTICUT TOWN OF GLASTONBURY ENGINEERING SHEET NO. 2 OF 15 SCALE: AS SHOWN DRAWN BY: C.F.S. CHECKED BY: S.M.B. APPROVED BY: D.A.P. DATE: 5/12/2010 DRAWING ISSUE STATUS NO.1 ISSUED FOR PERMITTING 5/14/2010 PW-0920"

"PLAN & PROFILE PROPOSED ROADWAY CONNECTION FOR THE COMPLETION OF WESTERN BOULEVARD LOCATED BETWEEN NATIONAL DRIVE & EASTERN BOULEVARD GLASTONBURY, CONNECTICUT SHEET TOWN OF GLASTONBURY ENGINEERING NO. 3 OF 15 SCALE: AS SHOWN DRAWN BY: C.F.S. CHECKED BY: S.M.B. APPROVED BY: D.A.P. DATE: 5/12/2010 DRAWING ISSUE STATUS NO.1 ISSUED FOR PERMITTING 5/14/2010 PW-0920"

"STORM WATER POLLUTION CONTROL PLAN PROPOSED ROADWAY CONNECTION FOR THE COMPLETION OF WESTERN BOULEVARD LOCATED BETWEEN NATIONAL DRIVE & EASTERN BOULEVARD GLASTONBURY, CONNECTICUT TOWN OF GLASTONBURY ENGINEERING SHEET NO. 11 OF 15 SCALE: AS SHOWN DRAWN BY: C.F.S. CHECKED BY: S.M.B. APPROVED BY: D.A.P. DATE: 5/12/2010 DRAWING ISSUE STATUS NO.1 ISSUED FOR PERMITTING 5/14/2010 PW-0920"

"STORM WATER POLLUTION CONTROL TYPICAL DETAILS & NOTES FOR PROPOSED ROADWAY CONNECTION FOR THE COMPLETION OF WESTERN BOULEVARD LOCATED BETWEEN NATIONAL DRIVE & EASTERN BOULEVARD GLASTONBURY, CONNECTICUT TOWN OF GLASTONBURY ENGINEERING SHEET NO. 12 OF 15 SCALE: AS SHOWN DRAWN BY: C.F.S. CHECKED BY: S.M.B. APPROVED BY: D.A.P. DATE: 5/12/2010 DRAWING ISSUE STATUS NO.1 ISSUED FOR PERMITTING 5/14/2010 PW-0920"

and in compliance with the following conditions:

- 1. Healthy mature trees shall be preserved and saved when possible. Said trees shall be protected with the use of high visibility construction fence during construction or otherwise protected as required by staff.
- 2. Installation of soil erosion and sedimentation control and stabilization measures shall be the Permittee's responsibility. Once installed these measures shall then be inspected by the Environmental Planner prior to land disturbance activities. Afterwards it then shall be the Permittee's responsibility to inspect these control measures during, and immediately following, substantial storm events and maintain and/or replace the control measures, when needed, on a regular basis until the site is vegetatively stabilized. Hay bales shall be replaced every 60 days. The Environmental Planner is hereby authorized to require additional soil erosion and sediment controls and stabilization measures to address situations that arise on the site.
- 3. Tree stumps and blasted rock material shall not be buried at the site.
- 4. Topsoil stockpile areas shall not be permitted within the regulated area.
- 5. Metal waste containers shall be provided at the site to facilitate the collection of refuse material generated from construction activities. Such material shall not be buried or burned at the site.
- 6. Disturbed land areas shall be loamed, limed, fertilized and seeded as soon as practical in order to permanently stabilize such areas. The proposed wet swale to serve as a water quality management practice shall be seeded with a specialized seed mix as directed by the Environmental Planner.
- 7. The Permittee shall be fully responsible for damages caused by all activities undertaken pursuant to this permit that may have a detrimental effect on wetlands and/or watercourses, and all such activities that cause erosion and sedimentation problems.

APPROVED: TOWN PLAN & ZONING COMMISSION

WESTERN BOULEVARD CONNECTOR PLANNED EMPLOYMENT PROJECT/APPLICANT PROJECT ADDRESS SPECIAL PERMIT SECTION TPZ CHAIRPERSON DATE SPECIAL PERMIT APP'D DIRECTOR OF COMMUNITY DEVELOPMENT FILE NO.

ALL UTILITY INFORMATION AND DATA SHOWN OR INDICATED IN THE CONTRACT DOCUMENTS ARE COMPILED FROM MAPS AND DATA FURNISHED BY OTHERS. ANY SUCH INFORMATION SHOULD NOT BE CONSTRUED AS ACCURATE OR COMPLETE AND THE CONTRACTOR SHALL VERIFY ALL LOCATIONS PRIOR TO CONSTRUCTION.

THE LOCATION OF UNDERGROUND UTILITIES DEPICTED HEREON ARE BASED ON FIELD LOCATIONS AND BY INFORMATION PROVIDED BY OTHERS. THEIR TRUE LOCATIONS MAY VARY FROM THOSE INDICATED, AND ALL UNDERGROUND UTILITIES MAY NOT BE SHOWN. IF APPLICABLE, UTILIZE THE "CALL BEFORE YOU DIG" NUMBER (1-800-922-4455). TO VERIFY THE LOCATION OF ALL UNDERGROUND UTILITIES, AND RESOLVE CONFLICTS PRIOR TO STARTING CONSTRUCTION, REPAIR OR DESIGN.

Soil Identification Table Source USDA / CT-DEP

(108) NinigrSaco silt loam (109) Fluvaquents — Udifluvents complex, freaequently flooded

15) Scarboro muck

21A) Ninigret and Tisbury soils

306) Udorthents — Urban land complex (307) Urban land


(308) Udorthents, smoothed (32B) Haven and Enfield soils


35B) Penwood loamy sand


37C) Manchester gravelly sandy loam 37E) Manchester gravelly sandy loam




PW-0920

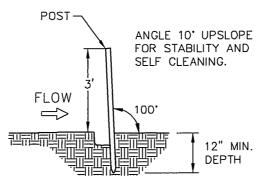

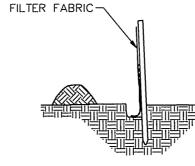

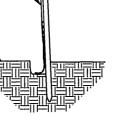

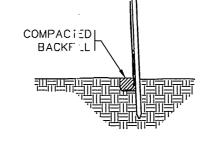

1. SET POSTS AND EXCAVATE A 6"X6" TRENCH. SET POST DOWNSLOPE.

THE HEIGHT OF THE BARRIER AT THE -

NOTES:

2.5' 2.0' 2.5'

SURFACE TOWARD WETLAND

MODIFIED RIP RAP ON SURFACE TOWARD

STONE FILTER BERM -

DRAWING ISSUE STATUS

ISSUED FOR CONSTRUCTION

ISSUED FOR PERMITTING

DESCRIPTION

STONE FILTER BERM -

THE WATER QUALITY STONE BERM SHALL BE CONSTRUCTED SO WATER CANNOT PASS AROUND THE ENDS.

STONE FILTER BERM SHALL BE CONSTRUCTED PERPENDICULAR TO THE WATER QUALITY SWALE TO A MAX. HEIGHT OF 2 FEET.

2.0' 2.0' 2.0'

CENTER SHALL BE AT LEAST SIX (3) INCHES

LOWER THAN THE HEIGHT AT EITHER END.

2. ATTACH FILTER FABRIC FENCING TO POST AND EXTEND IT TO THE TRENCH BOTTOM.

3. BACKFILL THE TRENCH AND COMPACT THE EXCAVATED SOIL.

- CT. DOT No. 3 CRUSHEI) STONE

1. THE BARRIER SHALL BE CONSTRUCTED SO WATER CANNOT PASS AROUND THE ENDS.

- 2. REPAIR OR REPLACE PROMPTLY AS NEEDED.
- 3. THE BARRIER SHALL BE COMPLETELY RÉMOVE WHEN IT HAS SERVED IT: USEFULNESS UNLESS OTHERWISE NOTED.

PLACEMENT & CONSTRUCTION OF SYNTHETIC FILTER BARRIER

OF FLOW

2.0'

1. THE BARRIER SHALL BE CONSTRUCTED SO WATER

CANNOT PASS AROUND THE ENDS.

GRASS **SWALE**

- CT. DOT No. 3 CRUSHED STONE

WATER QUALITY SWALE RIP-RAP

FILTER BERM DETAIL

STA. 6+65 to 8+00

NOT TO SCALE

GRASS SWALE

2%

OTHERWISE NOTED.

2. REPAIR OR REPLACE PROMPTLY AS NEEDED.

3. THE BARRIER SHALL BE COMPLETELY REMOVE WHEN IT HAS SERVED ITS USEFULNESS UNLESS

STONE CHECK DAM DETAIL NOT TO SCALE

CT. DOT No. 3 CRUSHED STONE

WATER QUALITY SWALE

RIP-RAP FILTER BERM DETAIL

STA. 8+00 to 9+80 NOT TO SCALE

TYPE H EROSION CONTROL MAT

TYPE H EROSION CONTROL MAT

SCALE: AS SHOWN

DRAWN BY: C.F.S.

CHECKED BY: S.M.B.

LOAM AND SEEDED SURFACE

— 7.0' —

SNOW SHELF

- LOAM AND SEEDED SURFACE


SNOW SHELF

DATE:


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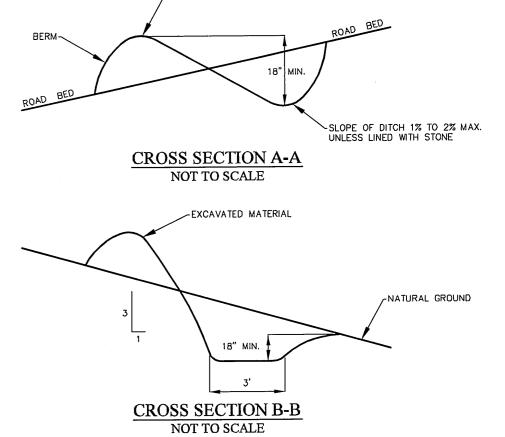
6/16/2010

NOT TO SCALE

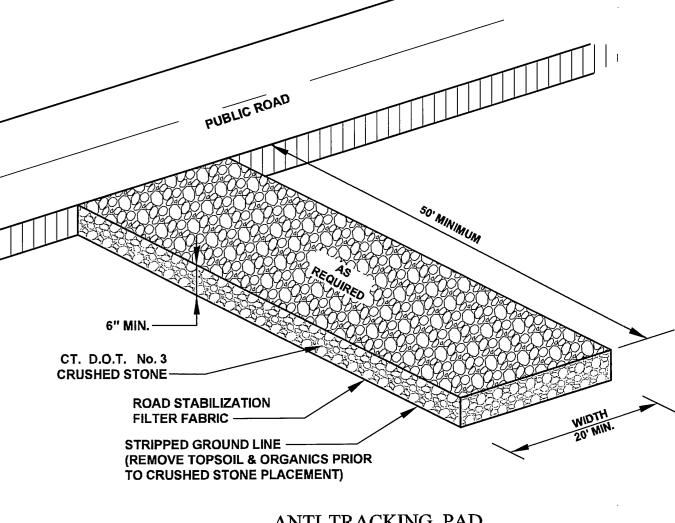

ANTI-TRACKING PAD CONSTRUCTION ENTRANCE NOT TO SCALE



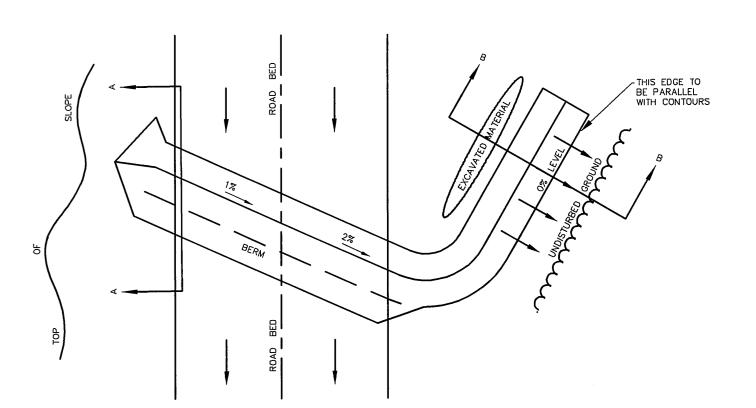

TEMPORARY WATER BAR WITH LEVEL SPREADER DETAIL

NOT TO SCALE WATER-BARS TO BE USED AT DISCRETION OF TOWN OF GLASTONBURY ENVIROMENTAL PLANNER AS FIELD CONDITIONS WARRANT.

LOCATION OF FEATURES AND CONTOUR DATA DEPICTED HEREON WERE ACQUIRED BY FIELD SURVEY ON NOVEMBER 2009.

THERE IS NO BOUNDARY/DETERMINATION OPINION. NO EASEMENTS PERTAINING TO THE SUBJECT PARCEL ARE DEPICTED HEREON.

NOT ALL IMPROVEMENTS ARE DEPICTED HEREON. HORIZONTAL CONTROL IS BASED ON THE CONNECTICUT GEODETIC SURVEY

STATE PLANE COORDINATES, NORTH AMERICAN DATUM OF 1983 - (NAD83). ELEVATIONS AND VERTICAL CONTROL IS BASED ON THE NORTH AMERICAN VERTICAL DATUM 1988 - (NAVD88).

FOR THE COMPLETION OF LOCATED BETWEEN

STORM WATER POLLUTION CONTROL TYPICAL DETAILS & NOTES FOR PROPOSED ROADWAY CONNECTION WESTERN BOULEVARD

SHEET NO

APPROVED BY: D.A.P. 6/16/2010 6/16/201 NATIONAL DRIVE & EASTERN BOULEVARD OF 15 DO NOT SCALE THIS DRAWING. USE THE DIMENSIONS GIVEN. IF THERE ARE ANY DISCREPANCIES OR QUESTIONS, CONTACT TH 5/14/2010 GLASTONBURY, CONNECTICUT GRID NORTH DATE TOWN OF GLASTONBURY, ENGINEERING OFFICE.

Test Pits Logs Investigated on April 5, 2010 along proposed route of Western Boulevard connection as shown on plans TP-2dark brown fine sandy loam topsoil 7 - 44" red-brown very fine sandy loam (silts noticeable) 48 - 51" light-brown medium coarse sand (with some gravel) 51 - 102" red-brown very fine sandy loam No groundwater observed black-brown very fine sandy loam topsoil 8 - 50" red-brown very fine sandy loam Groundwater at 50" & slumping sidewalls in pit prevented further observation dark brown very fine sandy loam topsoil (approaching 0 – 8" silt loam texture) 8 - 33" red-brown silt loam 33 - 37" red-brown very fine sandy loam 37 - 68" red-brown silt loam No groundwater observed black-brown silt loam topsoil 8 - 28" red-brown silt loam Groundwater at 28" — no infiltration potential red-brown fine sandy loam topsoil 7 - 27" red-brown very fine sandy loam 27 - 33" red-brown fine sandy loam (traces of coarse sand & 33 - 78" red-brown fine to medium sand ("beach sand") No groundwater brown very fine sandy loam topsoil 15 - 37" red-brown very fine sandy loam (silts noticeable) 37 - 48" red-brown silt loam 48 - 72" no analysis due to pit instability Groundwater at 72" brown fine sandy loam topsoil 10 - 24" red-brown very fine sandy loam 24 - 28" brown medium sand 28 - 80" brown coarse sand Groundwater at 68" brown fine sandy loam topsoil 14 - 33" brown medium coarse sand 33 - 60" red-brown fine sandy loam 60 - 76" brown medium coarse sand 76 - 96" red-brown very fine sandy loam No groundwater

THE LOCATION OF UNDERGROUND UTILITIES DEPICTED HEREON ARE

OTHERS. THEIR TRUE LOCATIONS MAY VARY FROM THOSE INDICATED,

AND ALL UNDERGROUND UTILITIES MAY NOT BE SHOWN. IF APPLICABLE

UTILIZE THE "CALL BEFORE YOU DIG" NUMBER (1-800-922-4455). TO

VERIFY THE LOCATION OF ALL UNDERGROUND UTILITIES, AND RESOLVE

CONFLICTS PRIOR TO STARTING CONSTRUCTION, REPAIR OR DESIGN.

BASED ON FIELD LOCATIONS AND BY INFORMATION PROVIDED BY

0 - 6"

brown fine sandy loam

ALL UTILITY INFORMATION AND DATA SHOWN OR INDICATED

IN THE CONTRACT DOCUMENTS ARE COMPILED FROM MAPS

AND DATA FURNISHED BY OTHERS. ANY SUCH INFORMATION


SHOULD NOT BE CONSTRUED AS ACCURATE OR COMPLETE


AND THE CONTRACTOR SHALL VERIFY ALL LOCATIONS PRIOR TO CONSTRUCTION.


49 - 96" brown medium coarse sand


No groundwater


6 - 49" red-brown fine sandy loam (silts noticeable)

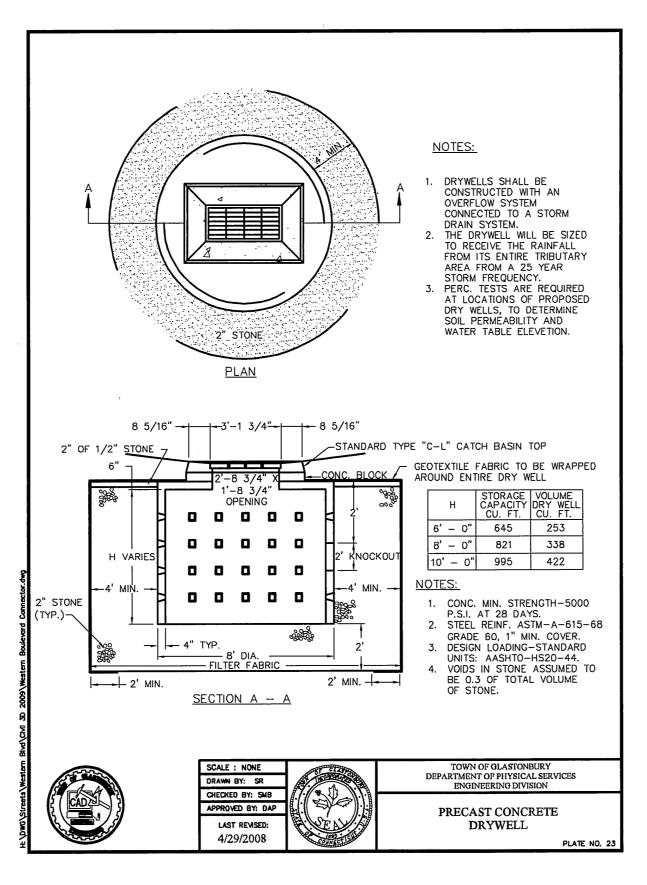


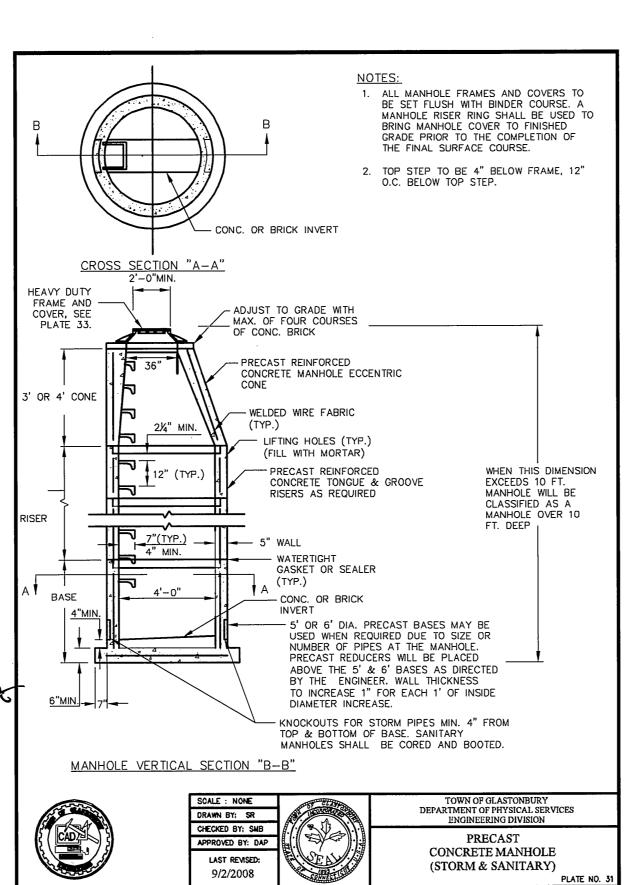

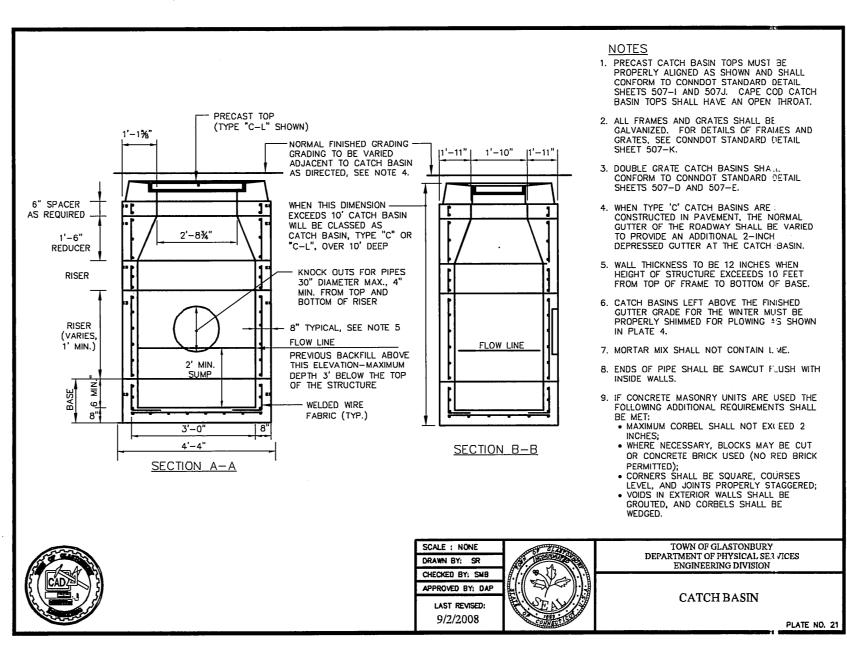

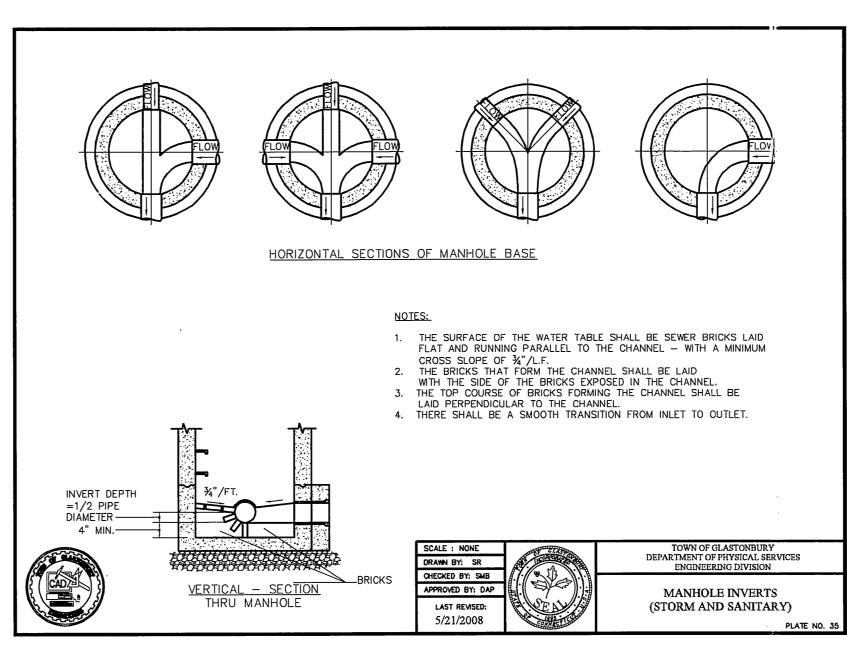

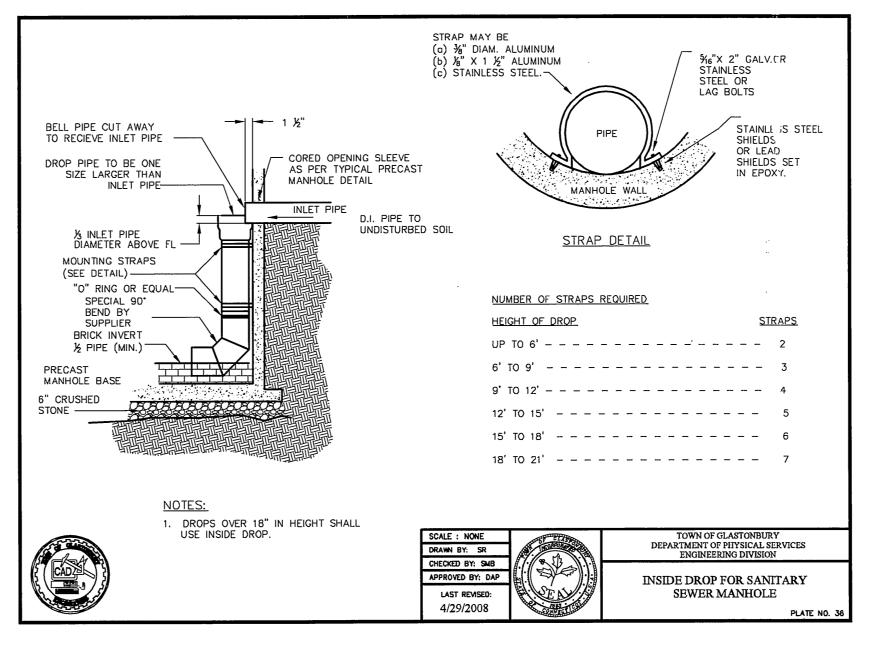

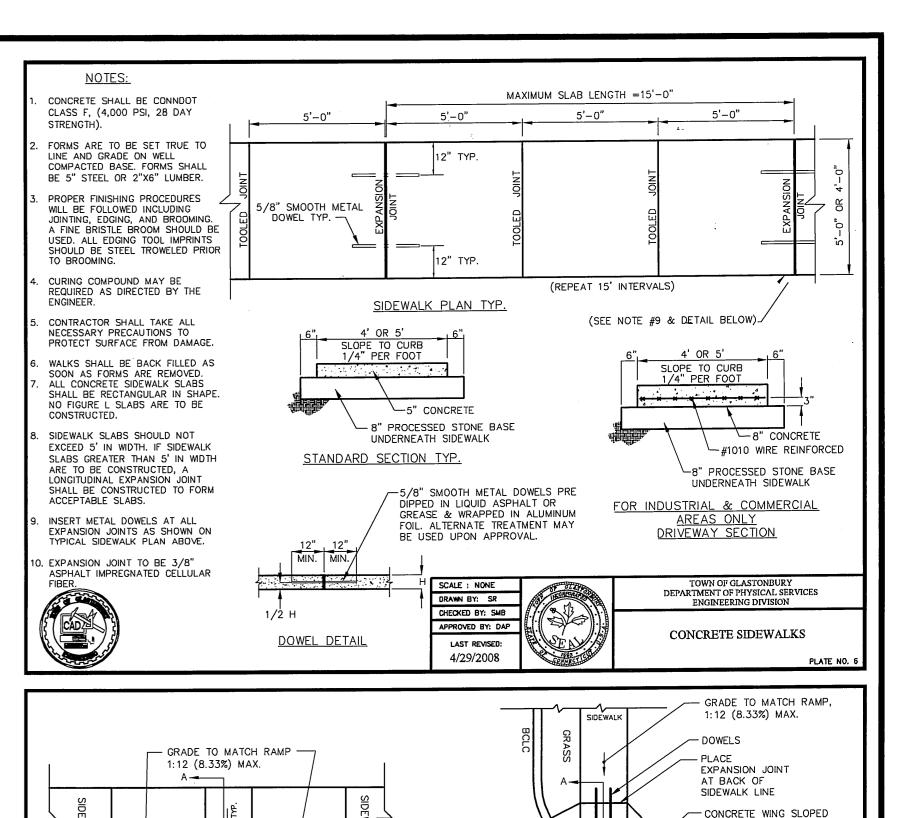

48" WIDE RAMP WITH 2' DETECTABLE WARNING STRIP

A-----

VARIES, SEE NOTE 1

CONCRETE WING SLOPED -

TO MATCH EXISTING CURB

RED IN COLOR.

DRAWN BY: SR

CHECKED BY: SMB

<u>PLAN</u>

<u>ELEVATION</u>

-USE 1-1/2 TO 2 INCHES PER FOOT WHERE GRASS STRIP

-USE 1 INCH PER FOOT MAX. WHERE SIDEWALK ABUTS CURB.

DETECTABLE WARNING STRIP SHALL BE PREFABRICATED SURFACE

TILE AS MANUFACTURED BY ENGINEERED PLASTICS INC., ADA FABRICATORS INC. OR APPROVED EQUAL. TILE SHALL BE BRICK

1. CONCRETE WING TO BE SLOPED AS FOLLOWS:

SEPARATÉS SIDEWALK FROM CURB.

- DOWELS

GRASS

SEE NOTE 1.

-48" WIDE RAMP WITH 2' DETECTABLE

PER SIDEWALK DETAIL

- CONCRETE WING SLOPED

TO MATCH EXISTING CURB,

GRASS

AT BACK OF RAMP

PLACE EXPANSION JOINT -

AT 1:2 SLOPE


12" HAUNCH →


Α -----

½" LIP BEVELED TI:12 MAX.

<u>PLAN</u>

SECTION A-A

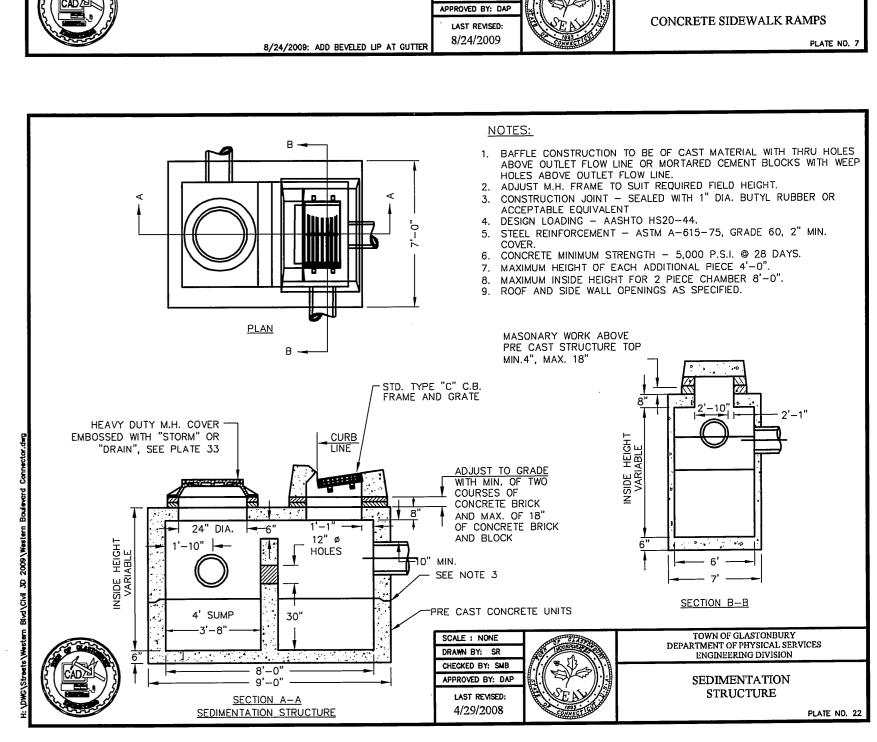

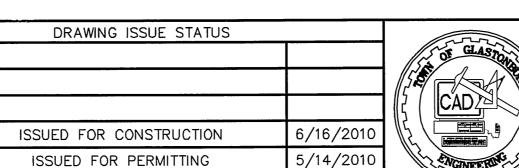

SCALE: AS SHOWN ... DATE: 5/12/2010 CHECKED BY: S.M.B. 6/16/2010 APPROVED BY: D.A.P. 6/16/2010 ST. FILE: DO NOT SCALE THIS DRAWING USE THE DIMENSIONS GIVEN. IF THERE ARE ANY DISCREPANCIES OR QUESTIONS, CONTACT THE TOWN OF GLASTONBURY, ENGINEERING OFFICE.

GRID NORTH



TYPICAL DETAILS & NOTES FOR PROPOSED ROADWAY CONNECTION FOR THE COMPLETION OF WESTERN BOULEVARD LOCATED BETWEEN

PW-0920

ISSUED FOR PERMITTING DESCRIPTION

DATE

NATIONAL DRIVE & EASTERN BOULEVARD GLASTONBURY, CONNECTICUT

SHEET NO.

TO MATCH EXISTING


-CONSTRUCTION JOINT (TYP.)


— GUTTER LINE


LFACE OF EXISTING CURB


DEPARTMENT OF PHYSICAL SERVICES

VARIES, SEE NOTE 1

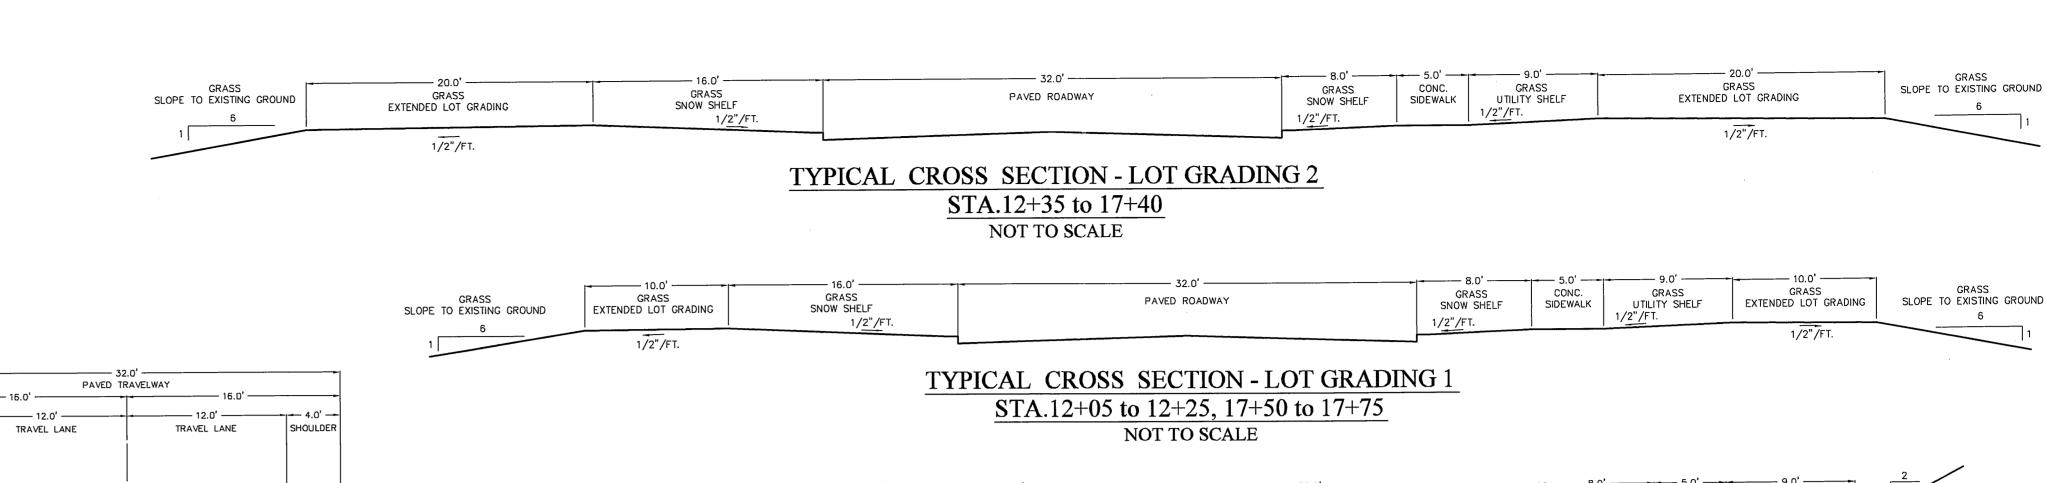

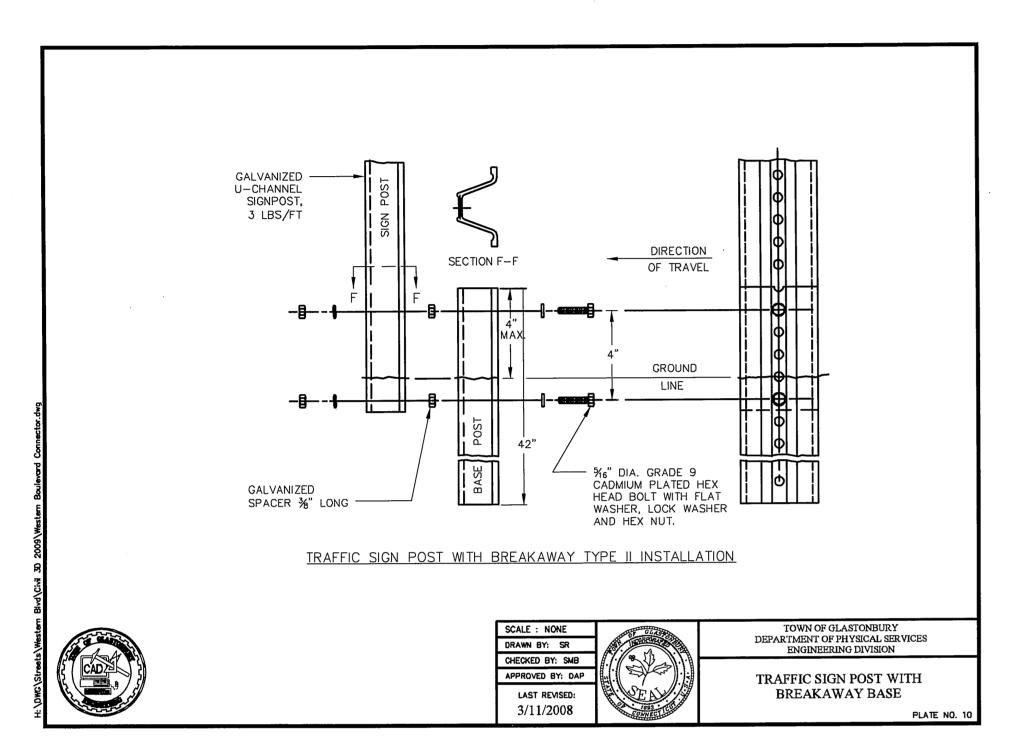


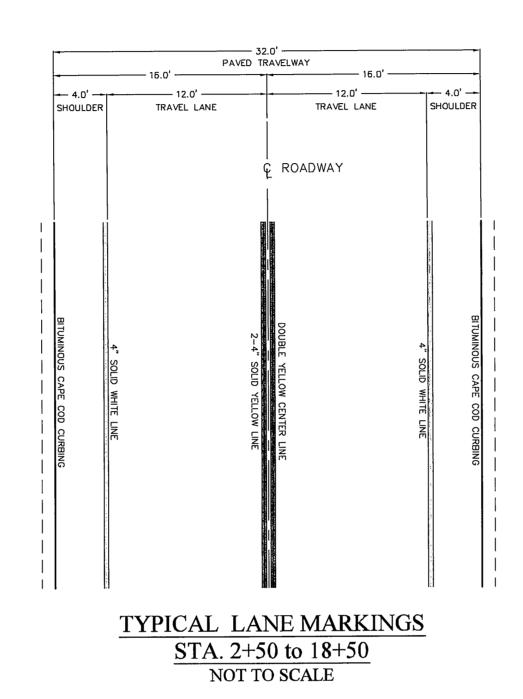


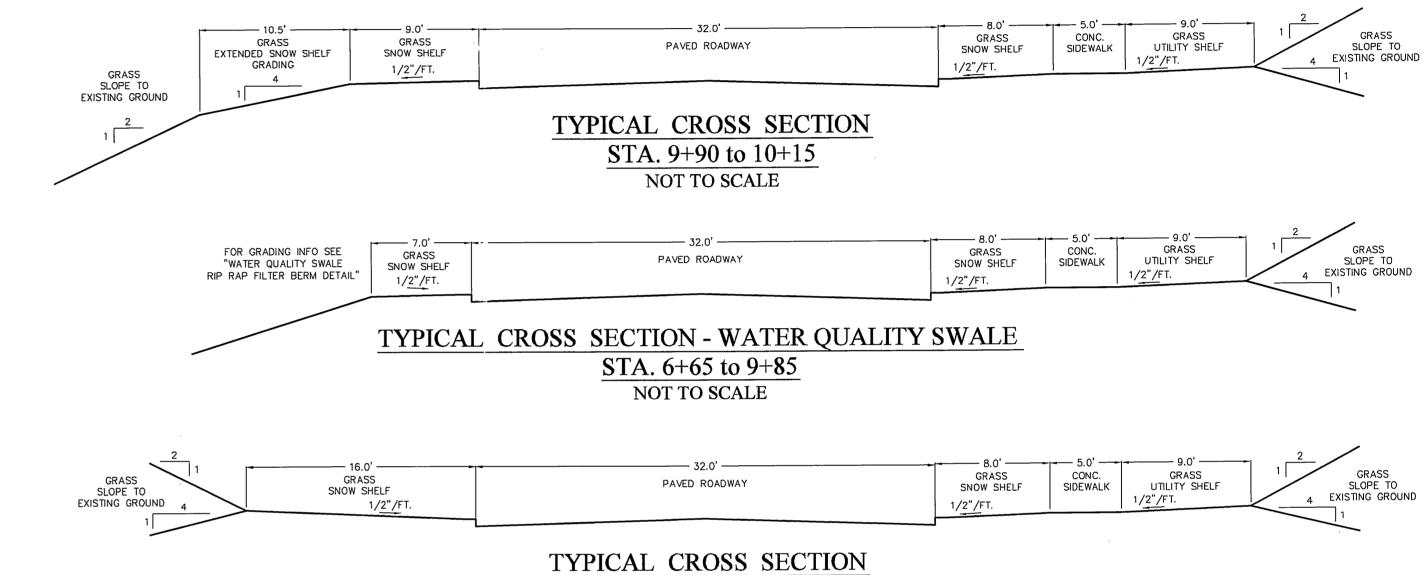



STA. 3+30 to 6+60, 10+20 to 12+0, 17+80 to 18+50


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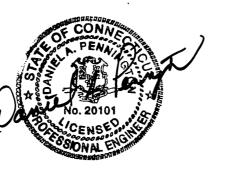


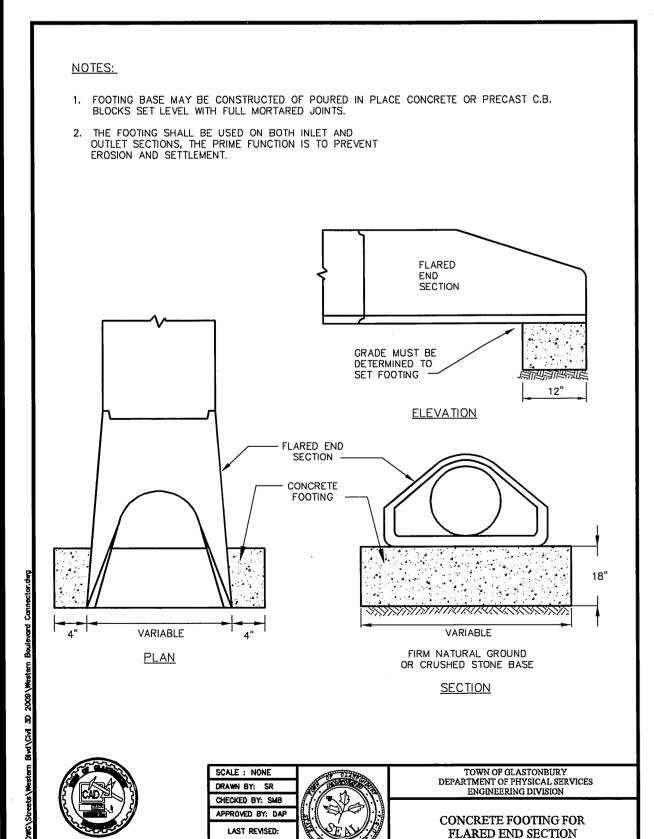

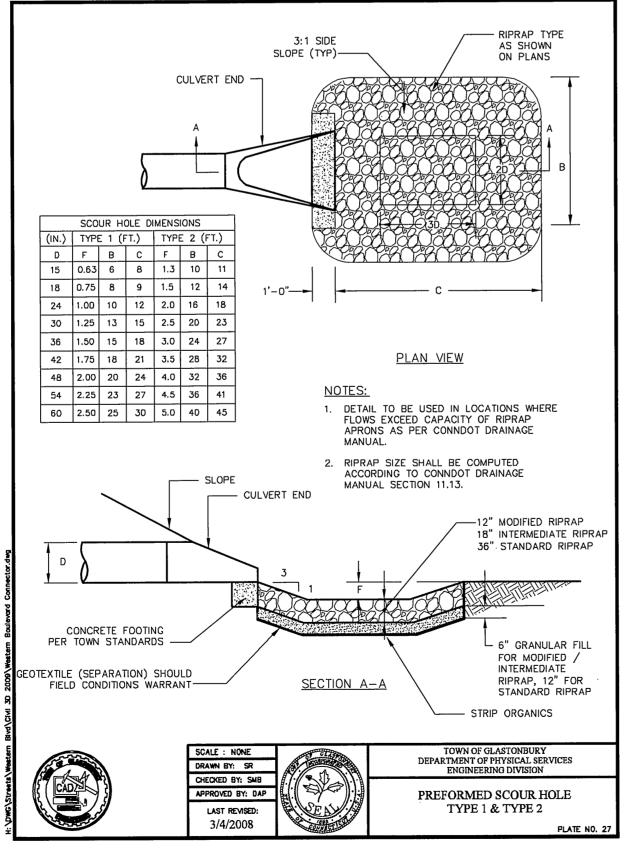


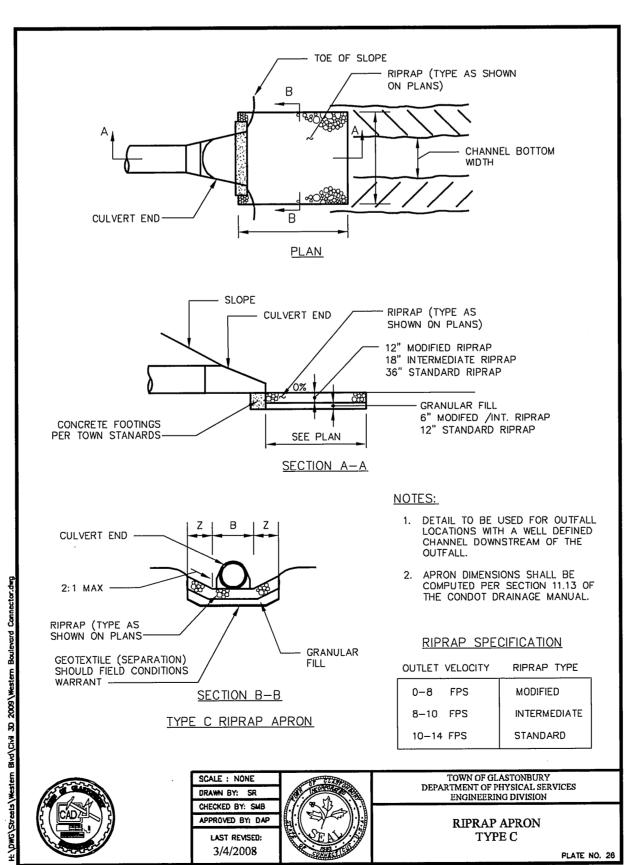


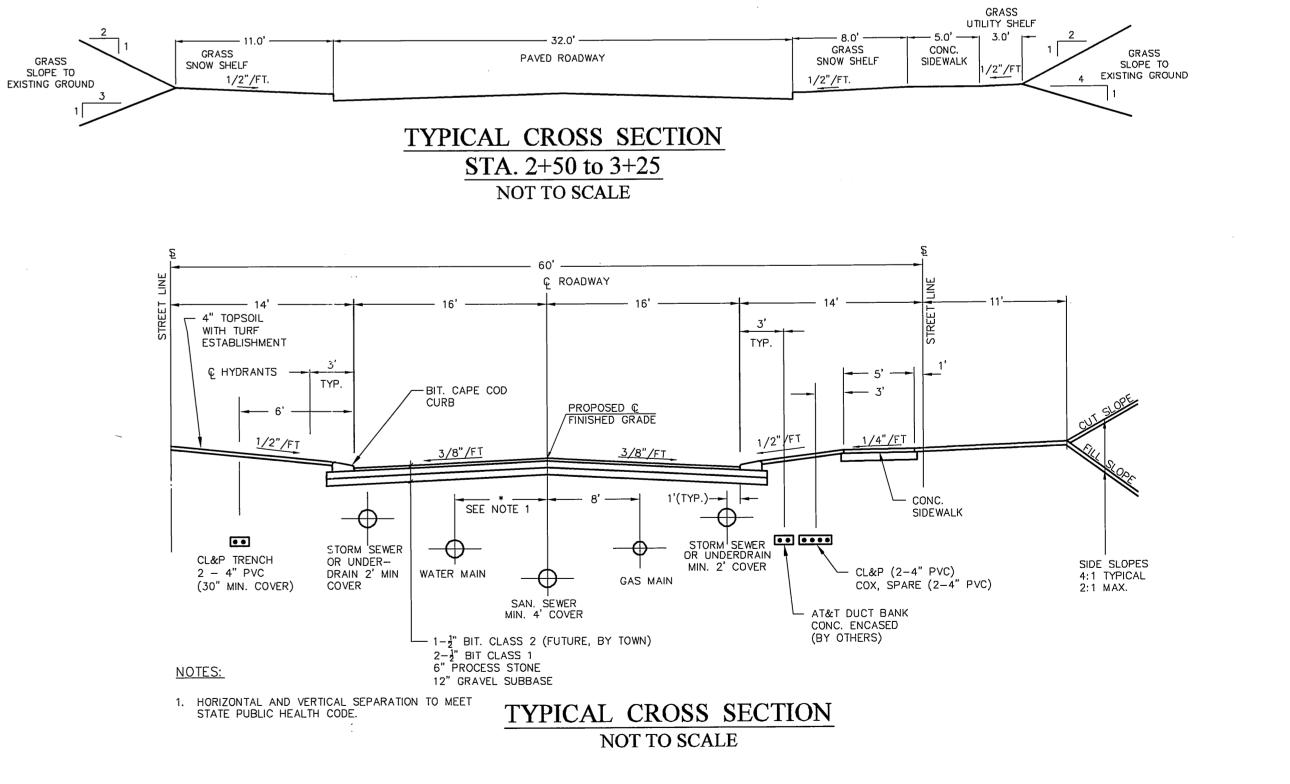

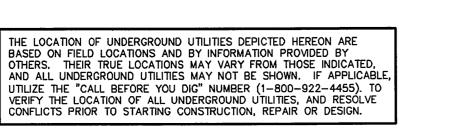

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-0920	NO.	DESCRIPTION	DATE	\$

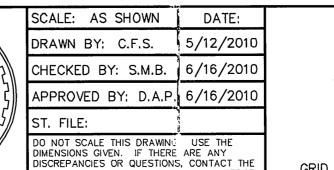

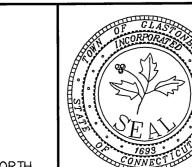

TYPICAL DETAILS & NOTES FOR PROPOSED ROADWAY CONNECTION FOR THE COMPLETION OF WESTERN BOULEVARD LOCATED BETWEEN

SHEET NO.

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4/29/2008


NATIONAL DRIVE & EASTERN BOULEVARD DO NOT SCALE THIS DRAWING USE THE DIMENSIONS GIVEN. IF THERE ARE ANY DISCREPANCIES OR QUESTIONS, CONTACT THE GLASTONBURY, CONNECTICUT GRID NORTH TOWN OF GLASTONBURY, ENGINEERING OFFICE


2. Install the conduit, gluing all couplings.

6. Fill in the remainder of the trench with native backfill.


3. Install secondaries and other utility cables or conduits in the trench.

4. Backfill with 12 inches clean fill not to contain stones larger than 2 inches in maximum diameter. 5. Install cable warning tape 12 inches over the conduit.

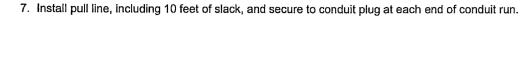

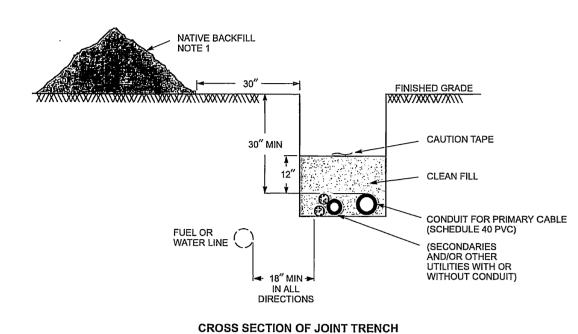

DUCT BANK TYPE 1 NOT TO SCALE

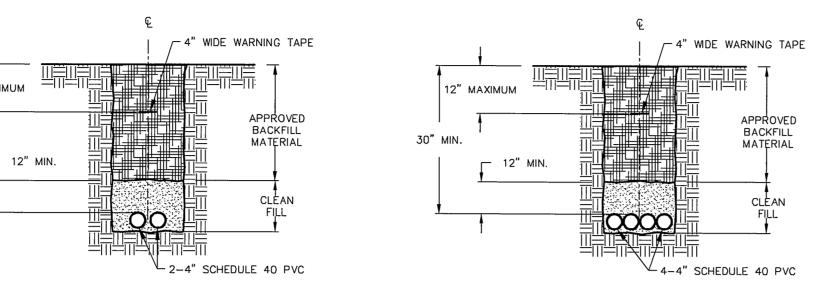


DUCT BANK TYPE 2 NOT TO SCALE

1. The trench shall be backfilled immediately following placement of the conduit. 2. 1/4-inch-diameter nylon pull line and plastic conduit plugs to be supplied and installed by contractor.

ORIGINAL 6/24/98 APPROVED	THREE-PHASE PRIMARY CABLE INSTALLATION DIRECT-BURIED - IN CONDUIT			T/MA
12/18/00 RDVsnus	NORTHEAST UTILITIES	CONSTRUCTION STANDARD	DTR 51.102	3

CONNECTICUT NATURAL GAS NOTES:

- 1. A MINIMUM OF 1'0" VERTICAL CLEARANCE AND 3'0" HORIZONTAL CLEARANCE MUST BE MAINTAINED BETWEEN THE GAS LINE AND ALL OTHER STRUCTURES.
- 2. MINIMUM COVER OVER PIPE SHALL BE MEASURED AS FOLLOWS:
- a. IN TRAVELED PORTION OF THE ROADWAY MINIMUM COVER SHALL BE 30" FROM THE TOP OF PIPE TO THE TOP OF TRENCH USING THE SHALLOW SIDE MEASUREMENT.
- b. OFF OF THE TRAVEL PORTION WHEN THE SECTION IS AT A LOWER ELEVATION THAN THE TRAVEL WAY MINIMUM COVER SHALL BE FROM 24" FROM THE TOP OF THE TRENCH USING THE SHALLOW SIDE FOR
- c. OFF OF THE TRAVEL PORTION WHEN THE SECTION IS AT A HIGHER ELEVATION THAN THE TRAVEL WAY MINIMUM COVER SHALL BE FROM 24" WITH THE ELEVATION TAKEN FROM THE GUTTER LINE.
- 3. MINIMUM COVER OF SERVICE LINES IN PRIVATE PROPERTY SHALL BE 18" WHEN OUTSIDE PAVED AREAS, I.E. PARKING LOT, OR WHEN APPROVED BY A CNG INSPECTOR OR DESIGNEE.
- 4. THE BOTTOM OF THE TRENCH MUST BE FREE OF ROCKS, DEBRIS OR WATER THAT COULD DAMAGE THE PIPE OR ITS COATING,
- 5. PRIOR TO LAYING THE PIPE, A MINIMUM OF 3" OF SCREENED SAND MUST BE PLACED IN THE BOTTOM OF THE TRENCH, (SCREENED SAND SHOULD BE COMPARABLE TO MASON SAND). 6. THE FIRST LAYER OF PIPE PROTECTION MUST BE A MINIMUM OF 4" OF SAND ON THE SIDES AND 6"
- OF SAND ON THE TOP. 7. EXPOSED PIPING MUST BE BACKFILLED WITH A MINIMUM OF 6" OF SAND PRIOR TO LEAVING THE JOB
- SITE EACH DAY AND WITNESSED BY A CNG REPRESENTATIVE OR CNG CONTRACTOR. 8. THE FINAL BACKFILLING PROCEDURE SHALL BE WITNESSED AND INSPECTED BY A CNG REPRESENTATIVE.
- ONLY APPROVED SELECT BACKFILL MATERIAL WILL BE USED. 9. THE BUILDER, UPON APPROVAL OF A CNG REPRESENTATIVE OR ITS SUBCONTRACTOR, IS TO PLACE WARNING TAPE APPROXIMATELY ON FOOT BELOW FINISHED GRADE BEFORE COMPLETING TRENCH BACKFILL WHEN IN PAVED AREA. WARNING TAPE SHALL BE 6" BELOW GRADE WHEN OUT OF PAVED
- THE BUILDER IS REQUIRED TO COMPACT THE BACKFILL MATERIAL WITHIN ESTABLISHED PROTOCOL. TRENCH SETTLEMENT IS THE RESPONSIBILITY OF THE CUSTOMER TO CORRECT.
- 11. ONLY PERSONNEL QUALIFIED BY CNG WILL BE ALLOWED TO INSTALL GAS LINES.
- 12. CNG WILL REQUIRE A SUITABLE LOCATION TO STORE PIPE AND MATERIALS. SECURITY IS THE RESPONSIBILITY OF THE DEVELOPER.
- 13. THE BUILDER WILL BE RESPONSIBLE FOR PAYMENTS TO CNG'S SUBCONTRACTOR FOR ANY ADDITIONAL ITEMS REQUIRED TO COMPLETE THE INSTALLATION, I.E. BACKFILL MATERIAL, LABOR OR MATERIAL. IN ADDITION, THE BUILDER WILL ALSO BE RESPONSIBLE FOR ITS DAMAGE TO UNDERGROUND FACILITIES AND TO THOSE FACILITIES EXPOSED. THE BUILDER WILL BE RESPONSIBLE FOR PROTECTING AND SUPPORTING ALL EXPOSED UNDERGROUND FACILITIES IN A MANNER ACCEPTABLE TO THE SUBJECT

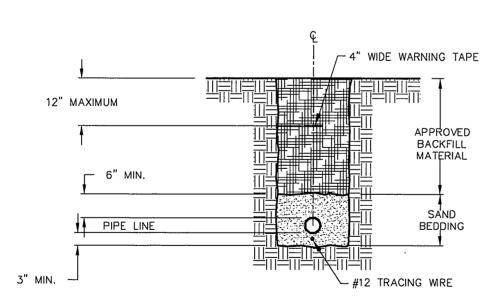



GAS MAIN TRENCH DETAIL NOT TO SCALE


THE LOCATION OF UNDERGROUND UTILITIES DEPICTED HEREON ARE BASED ON FIELD LOCATIONS AND BY INFORMATION PROVIDED BY OTHERS. THEIR TRUE LOCATIONS MAY VARY FROM THOSE INDICATED, AND ALL UNDERGROUND UTILITIES MAY NOT BE SHOWN. IF APPLICABLE, UTILIZE THE "CALL BEFORE YOU DIG" NUMBER (1-800-922-4455). TO VERIFY THE LOCATION OF ALL UNDERGROUND UTILITIES, AND RESOLVE CONFLICTS PRIOR TO STARTING CONSTRUCTION, REPAIR OR DESIGN.



		DRAWING ISSUE STATUS		
				/c.
:				
	2.	ISSUED FOR CONSTRUCTION	6/16/2010	1/5/
	1.	ISSUED FOR PERMITTING	5/14/2010	1/5
W-0920	NO.	DESCRIPTION	DATE	`

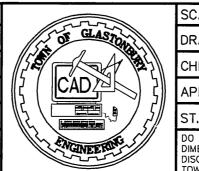

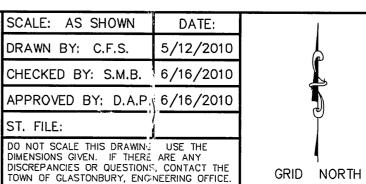

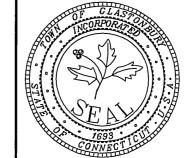

TYPICAL UTILITY DETAILS & NOTES FOR PROPOSED ROADWAY CONNECTION FOR THE COMPLETION OF WESTERN BOULEVARD LOCATED BETWEEN

ALL UTILITY INFORMATION AND DATA SHOWN OR INDICATED IN THE CONTRACT DOCUMENTS ARE COMPILED FROM MAPS AND DATA FURNISHED BY OTHERS. ANY SUCH INFORMATION SHOULD NOT BE CONSTRUED AS ACCURATE OR COMPLETE AND THE CONTRACTOR SHALL VERIFY ALL LOCATIONS PRIOR

NATIONAL DRIVE & EASTERN BOULEVARD OF __15 GLASTONBURY, CONNECTICUT