
## TOWN OF GLASTONBURY COMMUNITY CENTER PAVILION AND PICKLEBALL COURT ILLUMINATION PW - 2215 LOCATED ON 300 WELLES STREET

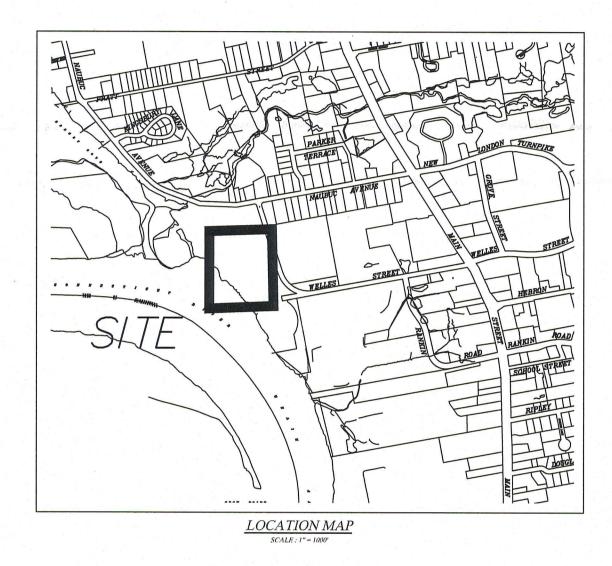

## TABLE OF CONTENTS


COVER SHEET
CONSTRUCTION PLANS
DETAILS
PAVILION DESIGN PLAN

SHEET 1
SHEET 2-3
SHEET 4
SHEET 5

JONATHAN LUIZ TOWN MANAGER

DANIEL A. PENNINGTON
MANAGER OF PHYSICAL SERVICES/TOWN ENGINEER

ISSUED FOR CONSTRUCTION

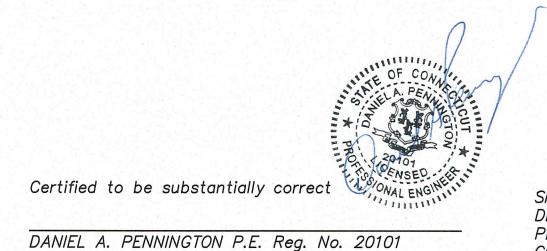

SHEET NO. 1-4
DESIGNED BY: GLASTONBURY ENGINEERING DIVISION
PER: DANIEL A. PENNINGTON, P.E.
CONN. P.E. REGISTRATION: 20101


	DRAWING ISSUE STATUS			SCALE: AS SHOWN	DATE:	
				DRAWN BY: S.Troy	11-3-2023	
				CHECKED BY: S.M.B.	11-3-2023	
				APPROVED BY: D.A.P.	11-3-2023	
	2.	ISSUED FOR CONSTRUCTION	4-12-2024	ST. FILE:	HATE	
	1.	ISSUED FOR PERMITTING	11-3-2023	MANUAL REVISIONS TO THIS DOCUMENT ARE PROHIBITED. ALL REVISIONS MUST BE PERFORMED ON CADD FILE SHOWN IN THE LEFT MARGIN. IF THERE ARE ANY DISCREPANCIES OR QUESTIONS, CONTACT THE TOWN OF GLASTONBURY, ENGINEERING OFFICE AT (860) 652—7735.		HATE!
.W. 2215	NO.	DESCRIPTION	DATE			10.75



PLANS DEPICTING
COMMUNITY CENTER PAVILLION
LOCATED AT
RIVERFRONT COMMUNITY CENTER
300 WELLES STREET
GLASTONBURY, CONNECTICUT

SHEET NO.

OF 4

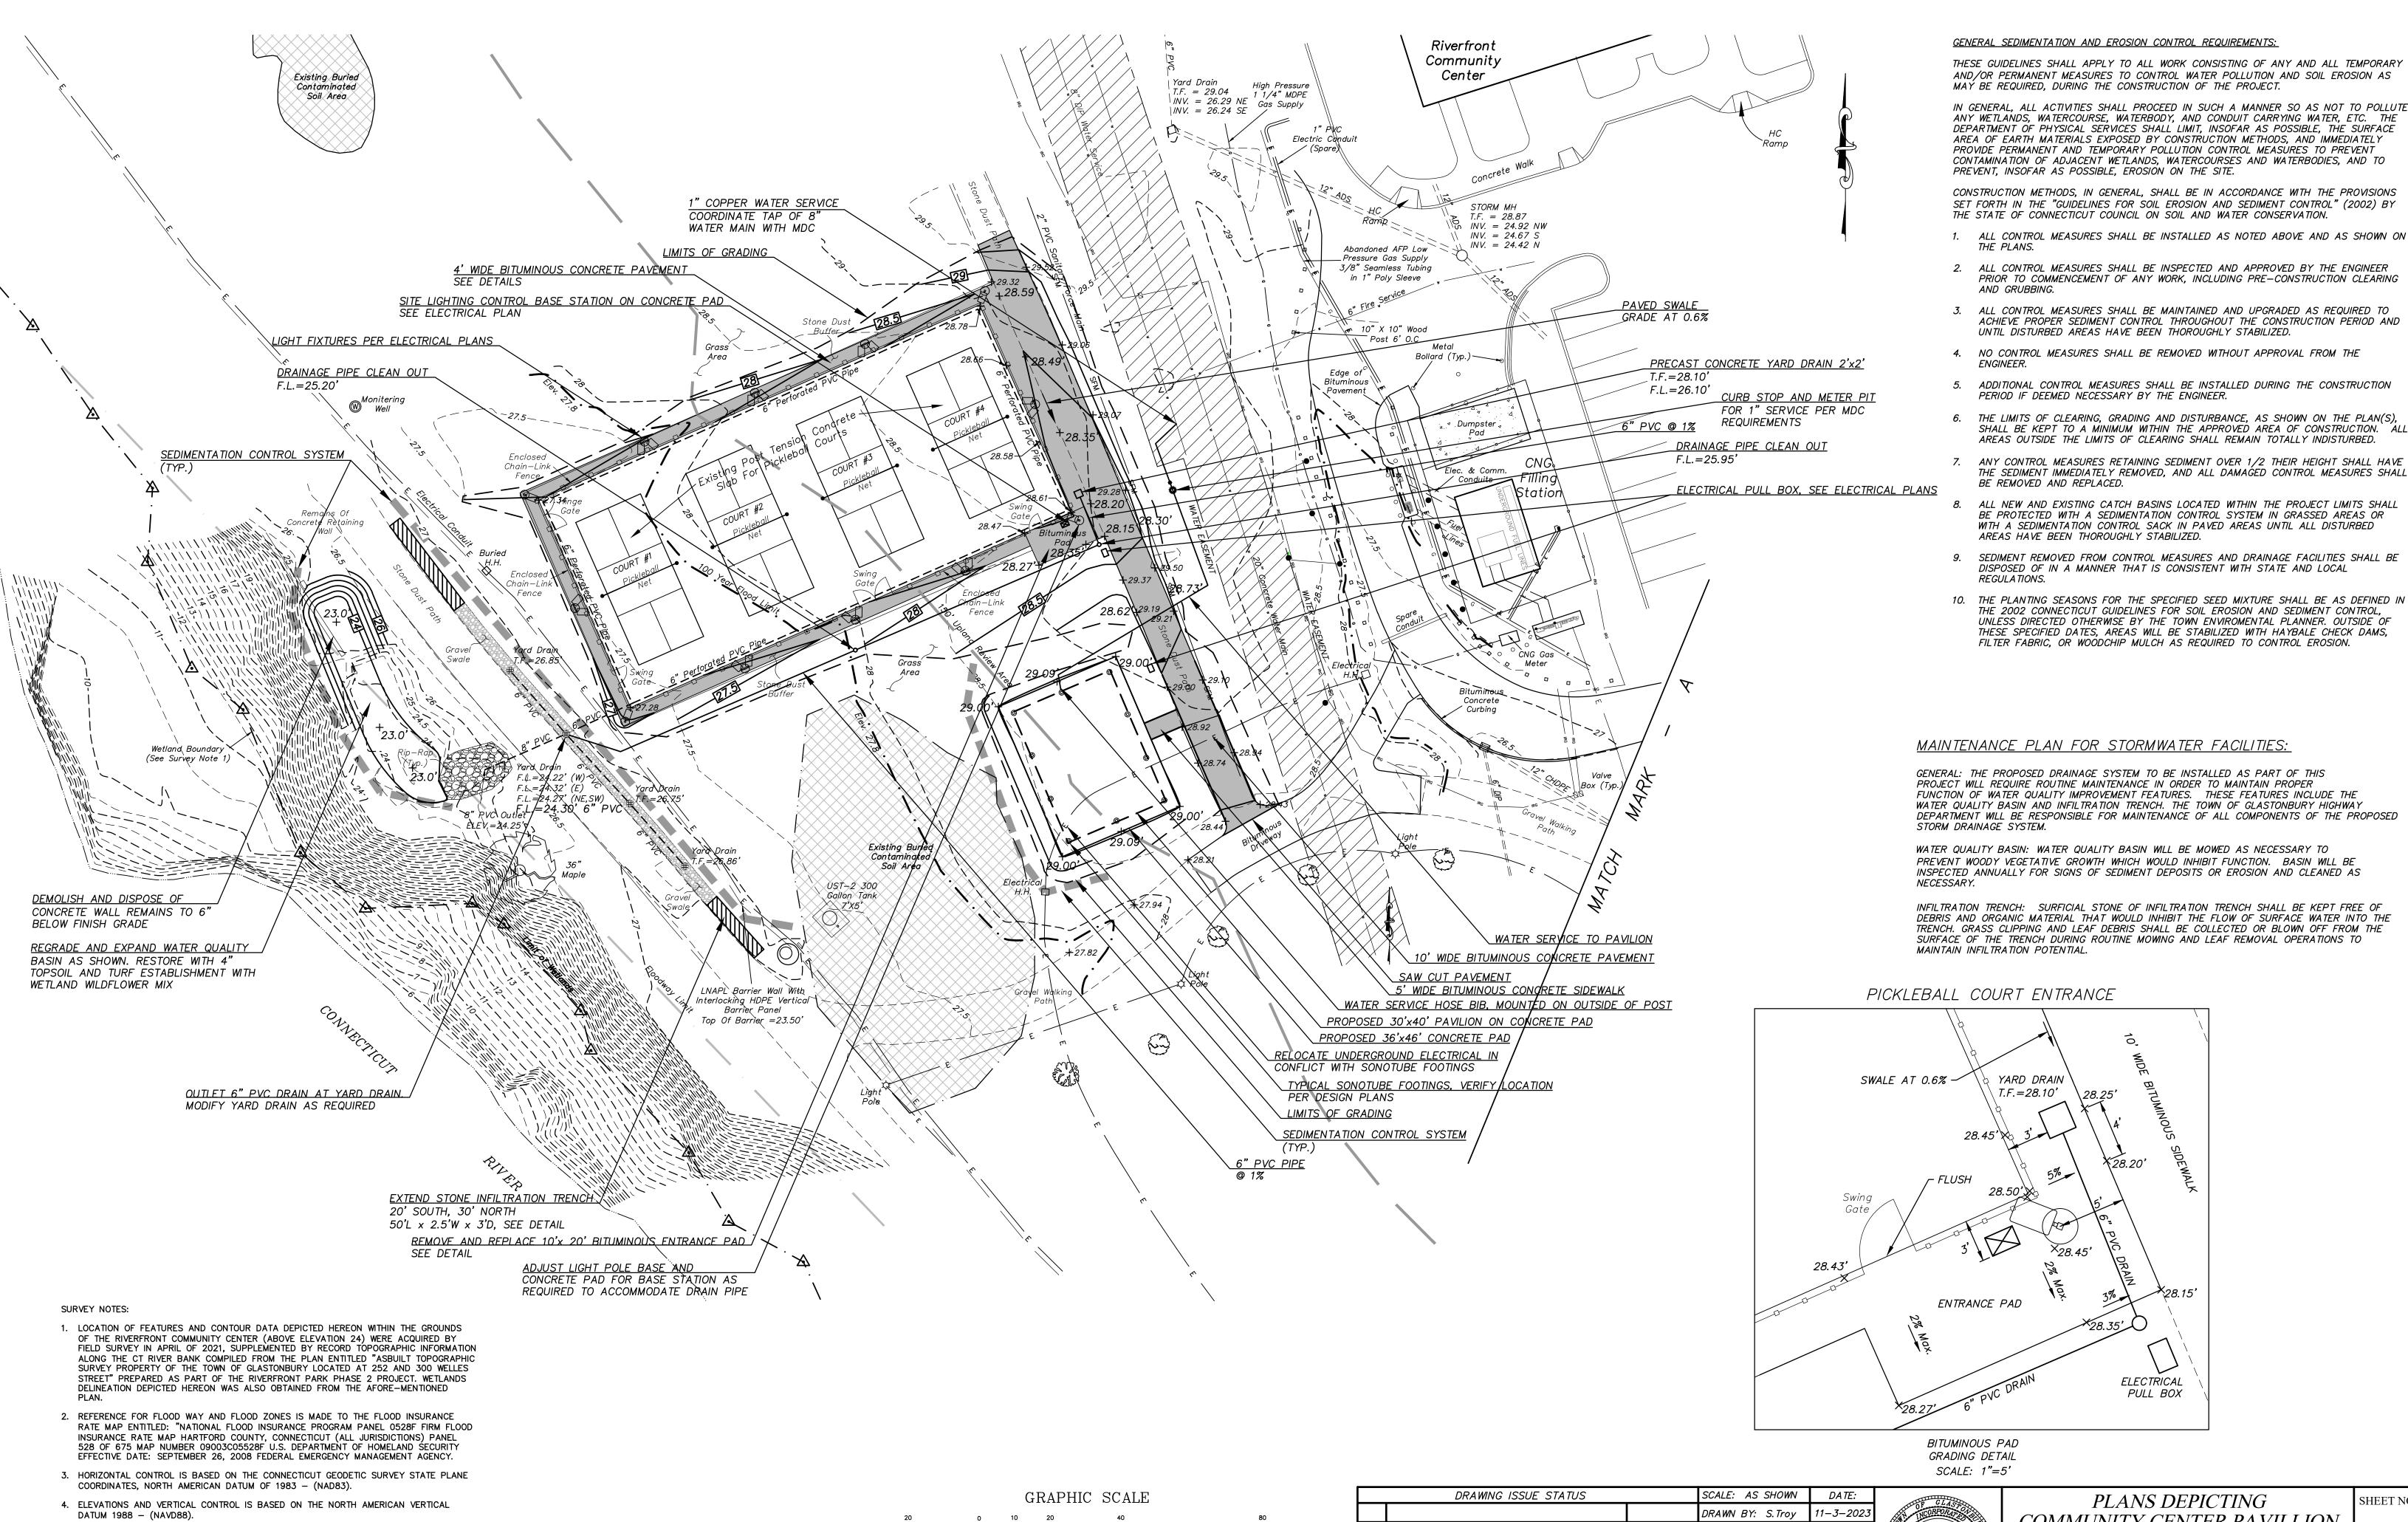

( IN FEET ) 1 inch = 20 ft.

5. THERE IS NO BOUNDARY/DETERMINATION OPINION.

7. NOT ALL IMPROVEMENTS ARE DEPICTED HEREON.

6. NO EASEMENTS PERTAINING TO THE SUBJECT PARCEL ARE DEPICTED HEREON.

COMMUNITY CENTER PAVILLION LOCATED AT RIVERFRONT COMMUNITY CENTER 300 WELLES STREET

CHECKED BY: S.M.B.

*4*−12−2024 ST. FILE:

1-3-2023

DATE

ISSUED FOR CONSTRUCTION

ISSUED FOR PERMITTING

DESCRIPTION

P.W. 2215 NO.

APPROVED BY: D.A.P. 11-3-2023


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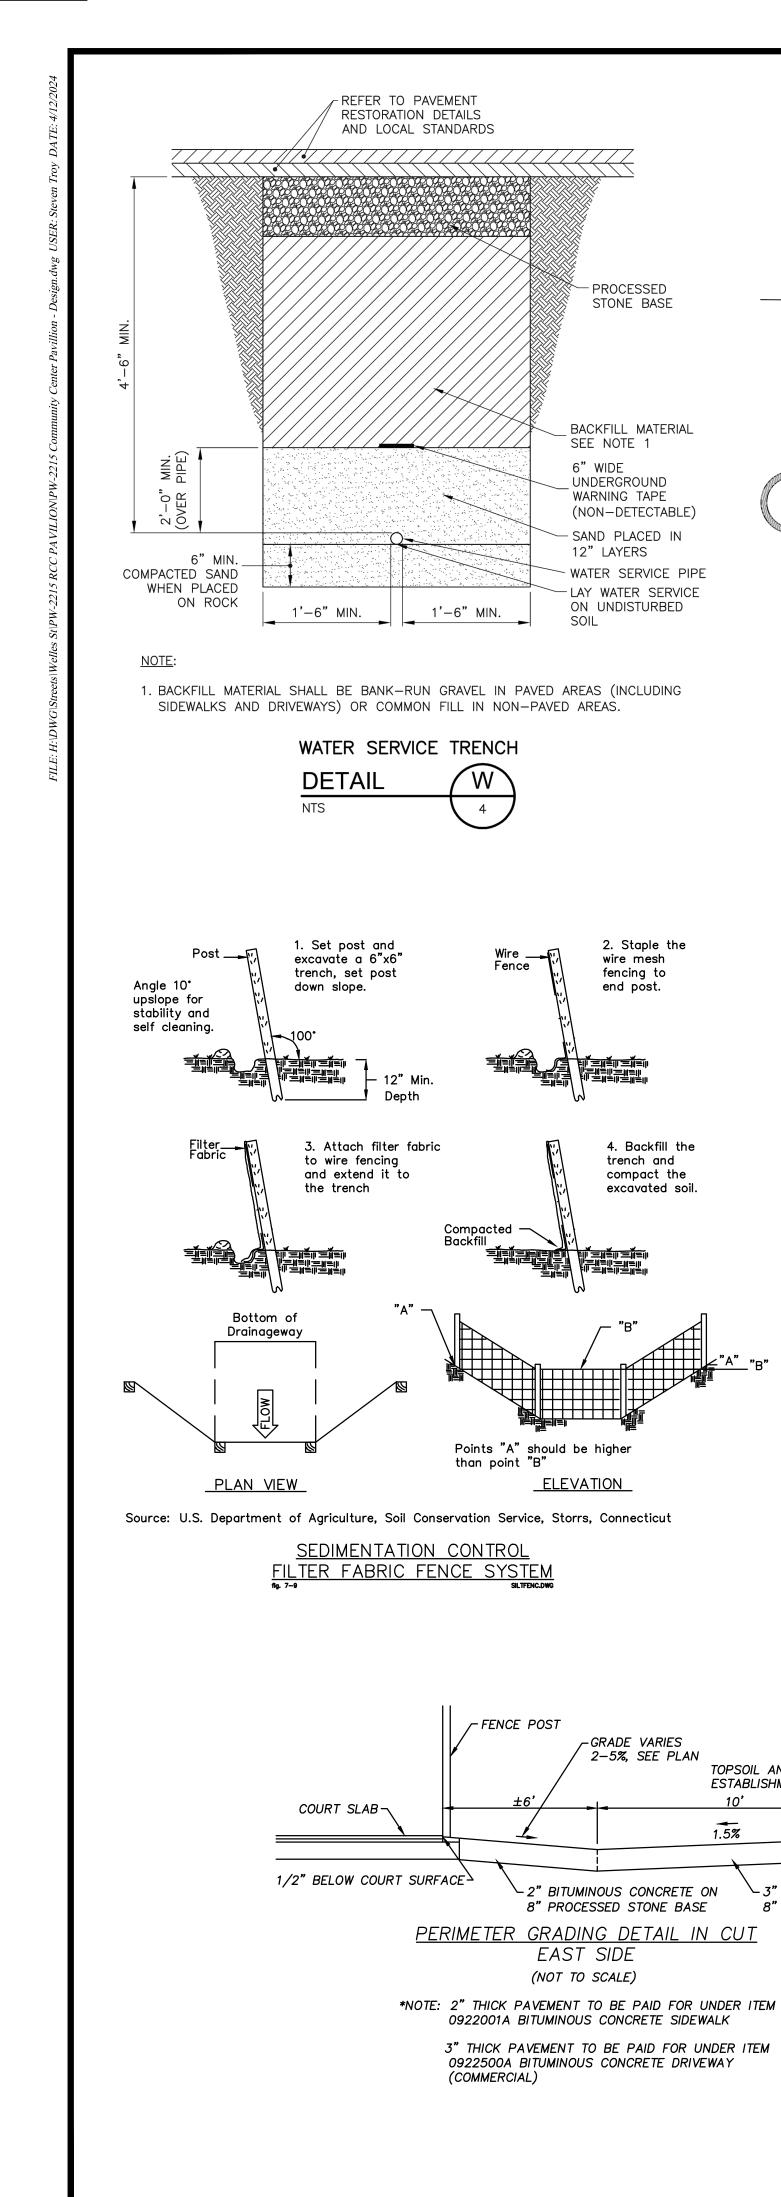
11-*3*-2023


GLASTONBURY, CONNECTICUT

SHEET NO

OF <u>4</u>



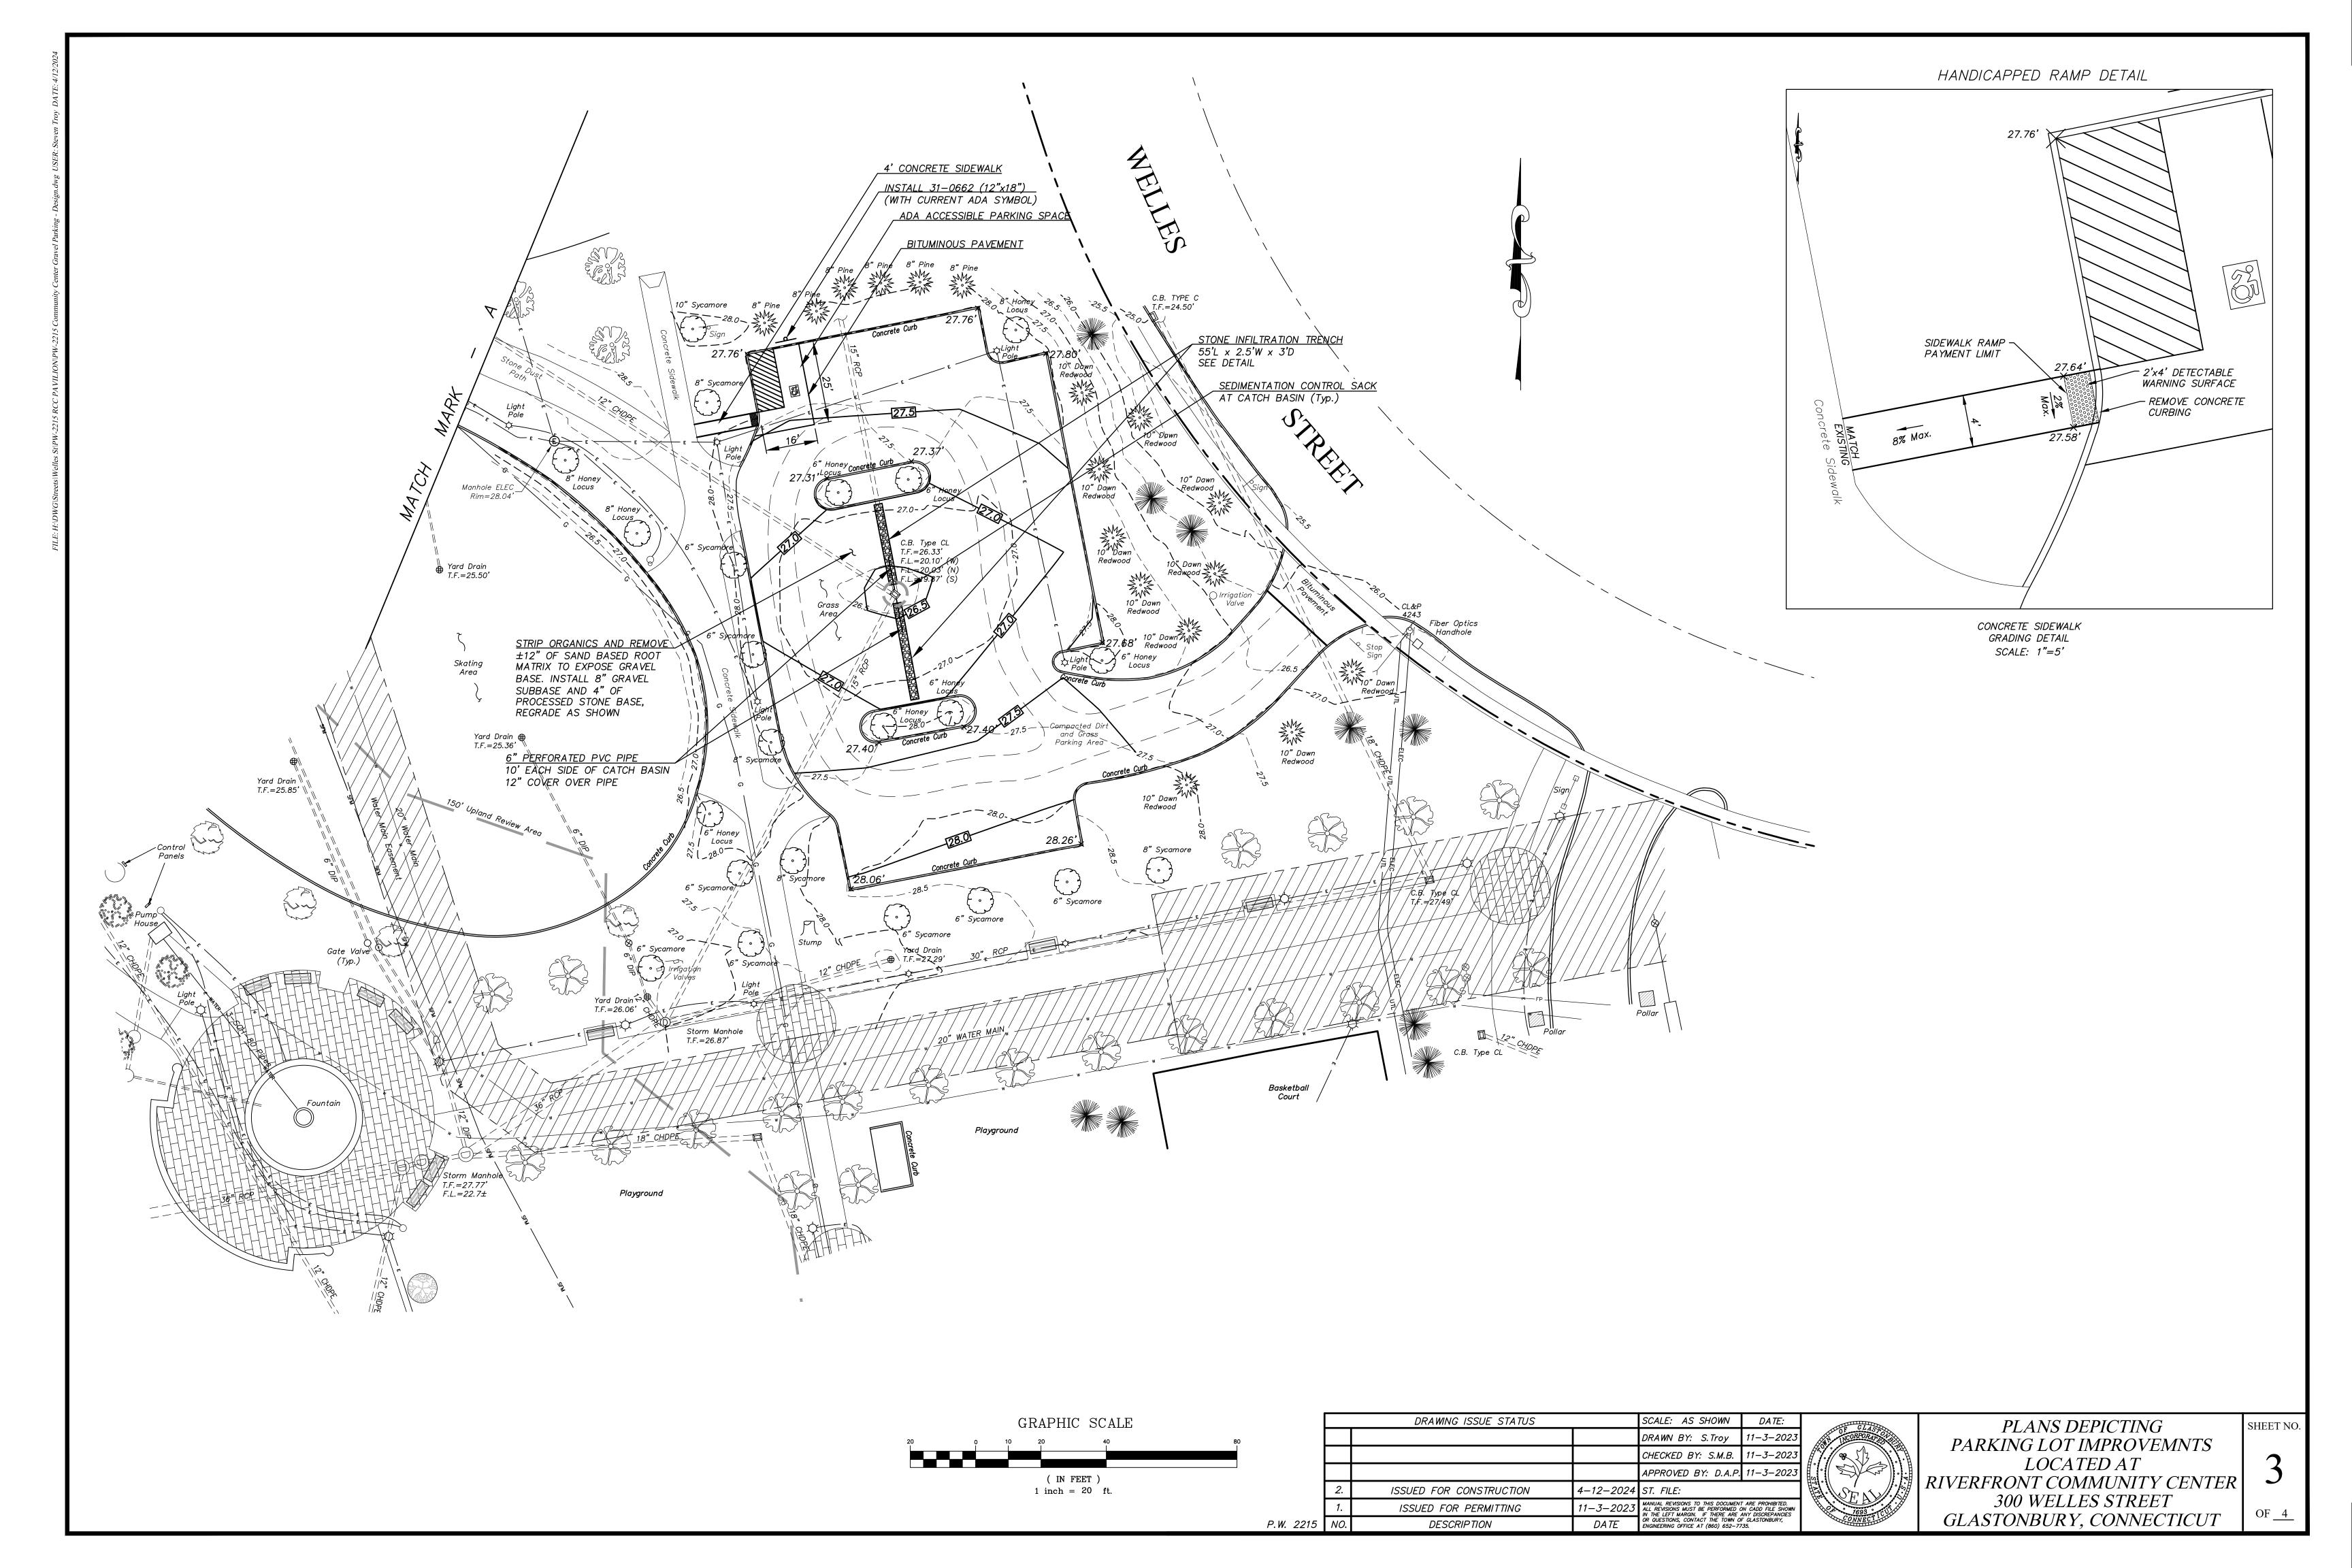

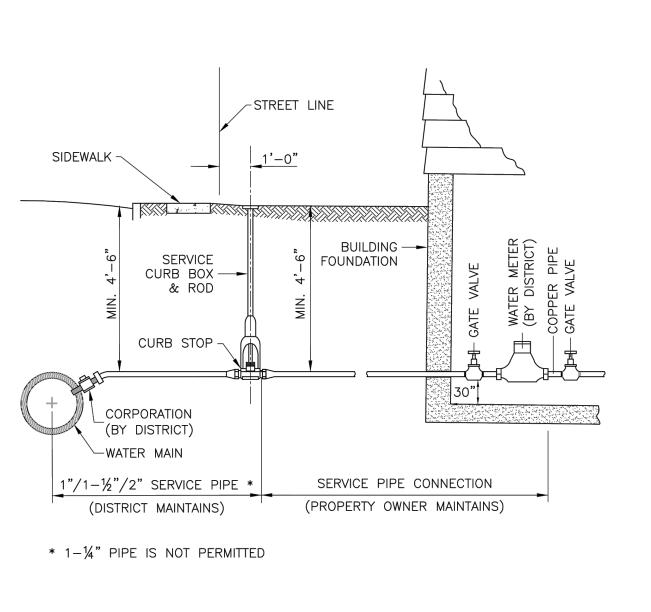

TYPE K COPPER WATER SERVICE

- PROCESSED

STONE BASE

BACKFILL MATERIAL

(NON-DETECTABLE)

WATER SERVICE PIPE

LAY WATER SERVICE

2. Staple the

4. Backfill the

trench and

Compacted -Backfill

Points "A" should be higher

ELEVATION

-GRADE VARIES

-2" BITUMINOUS CONCRETE ON

8" PROCESSED STONE BASE

PERIMETER GRADING DETAIL IN CUT EAST SIDE (NOT TO SCALE)

0922001A BITUMINOUS CONCRETE SIDEWALK

3" THICK PAVEMENT TO BE PAID FOR UNDER ITEM 0922500A BITUMINOUS CONCRETE DRIVEWAY

TOPSOIL AND TURF -ESTABLISHMENT

►3" BITUMINOUS CONCRETE ON

8" PROCESSED STONE BASE

1.5%

than point "B"

FENCE POST

(COMMERCIAL)

compact the

excavated soil.

wire mesh

fencing to end post.

ON UNDISTURBED


- SAND PLACED IN


SEE NOTE 1

UNDERGROUND


WARNING TAPE

12" LAYERS

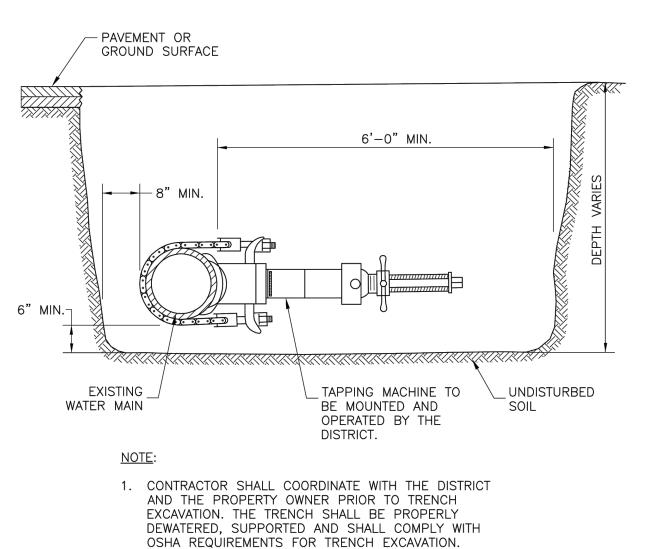


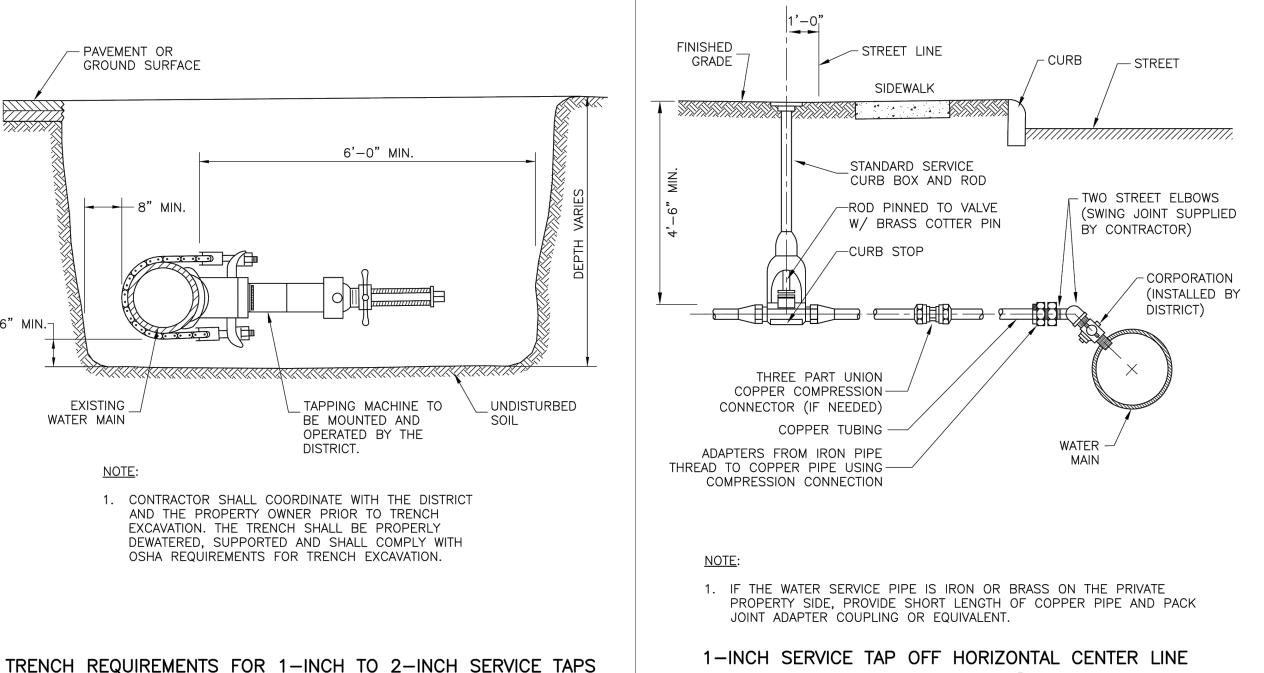



1-INCH SERVICE TAP OFF HORIZONTAL CENTER LINE NTS

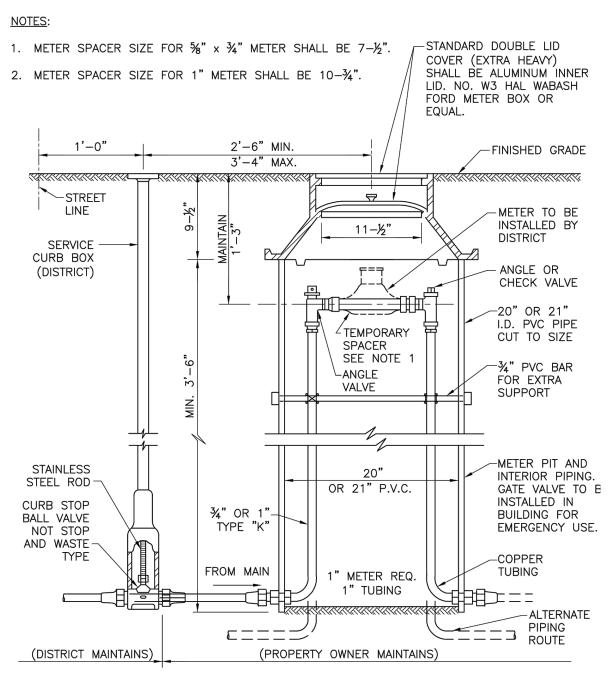


METER BOX FOR 1" SERVICE AND \%" x \\%" TO 1" METER

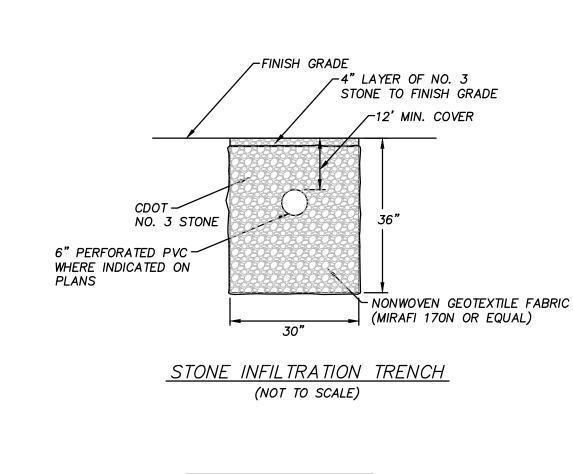

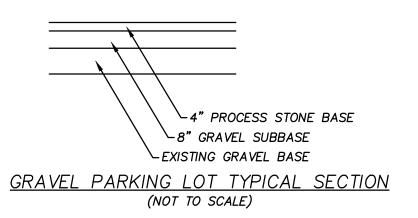

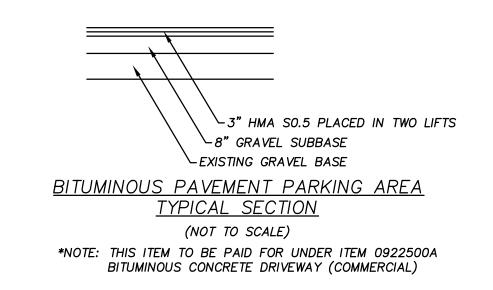

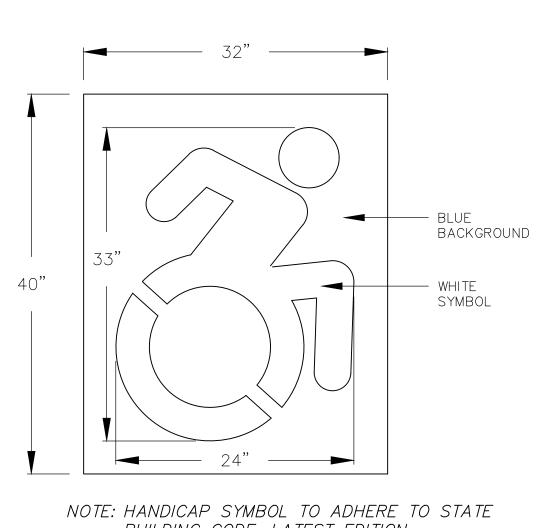

BUILDING CODE, LATEST EDITION CONNECTICUT SYMBOL OF ACCESSIBILITY

45° AND SPACED 2' O.C. CONNECTICUT SYMBOL OF ACCESSIBILITY (WHITE SYMBOL W/BULK BACKGROUND) ACCESSIBLE STALL NOTE: UNIFORM FEDERAL ACCESSIBILITY STANDARDS, SECTION 4.30, & 2010 ADA. TYPICAL HANDICAP

PARKING STALL LAYOUT

4" SOLID WHITE LINE @ -


——————8' VAN——

4" PAINT WHITE -

	TOPSOIL AND TURF — ESTABLISHMENT
COURT SLAB	12:1
	4:1  2" BITUMINOUS CONCRETE ON 8" PROCESSED STONE BASE  1/2" BELOW COURT SURFACE
	<u>NDING DETAIL IN CUT</u> D SOUTH SIDES

(NOT TO SCALE) \*NOTE: 2" THICK PAVEMENT TO BE PAID FOR UNDER ITEM 0922001A BITUMINOUS CONCRETE SIDEWALK

> SCALE: AS SHOWN DRAWING ISSUE STATUS DRAWN BY: S.Trov 11-*3*-2023 CHECKED BY: S.M.B. 11–3–202 APPROVED BY: D.A.P. 11-3-2023 ISSUED FOR CONSTRUCTION 4-12-2024 ST. FILE: MANUAL REVISIONS TO THIS DOCUMENT ARE PROHIBITED.
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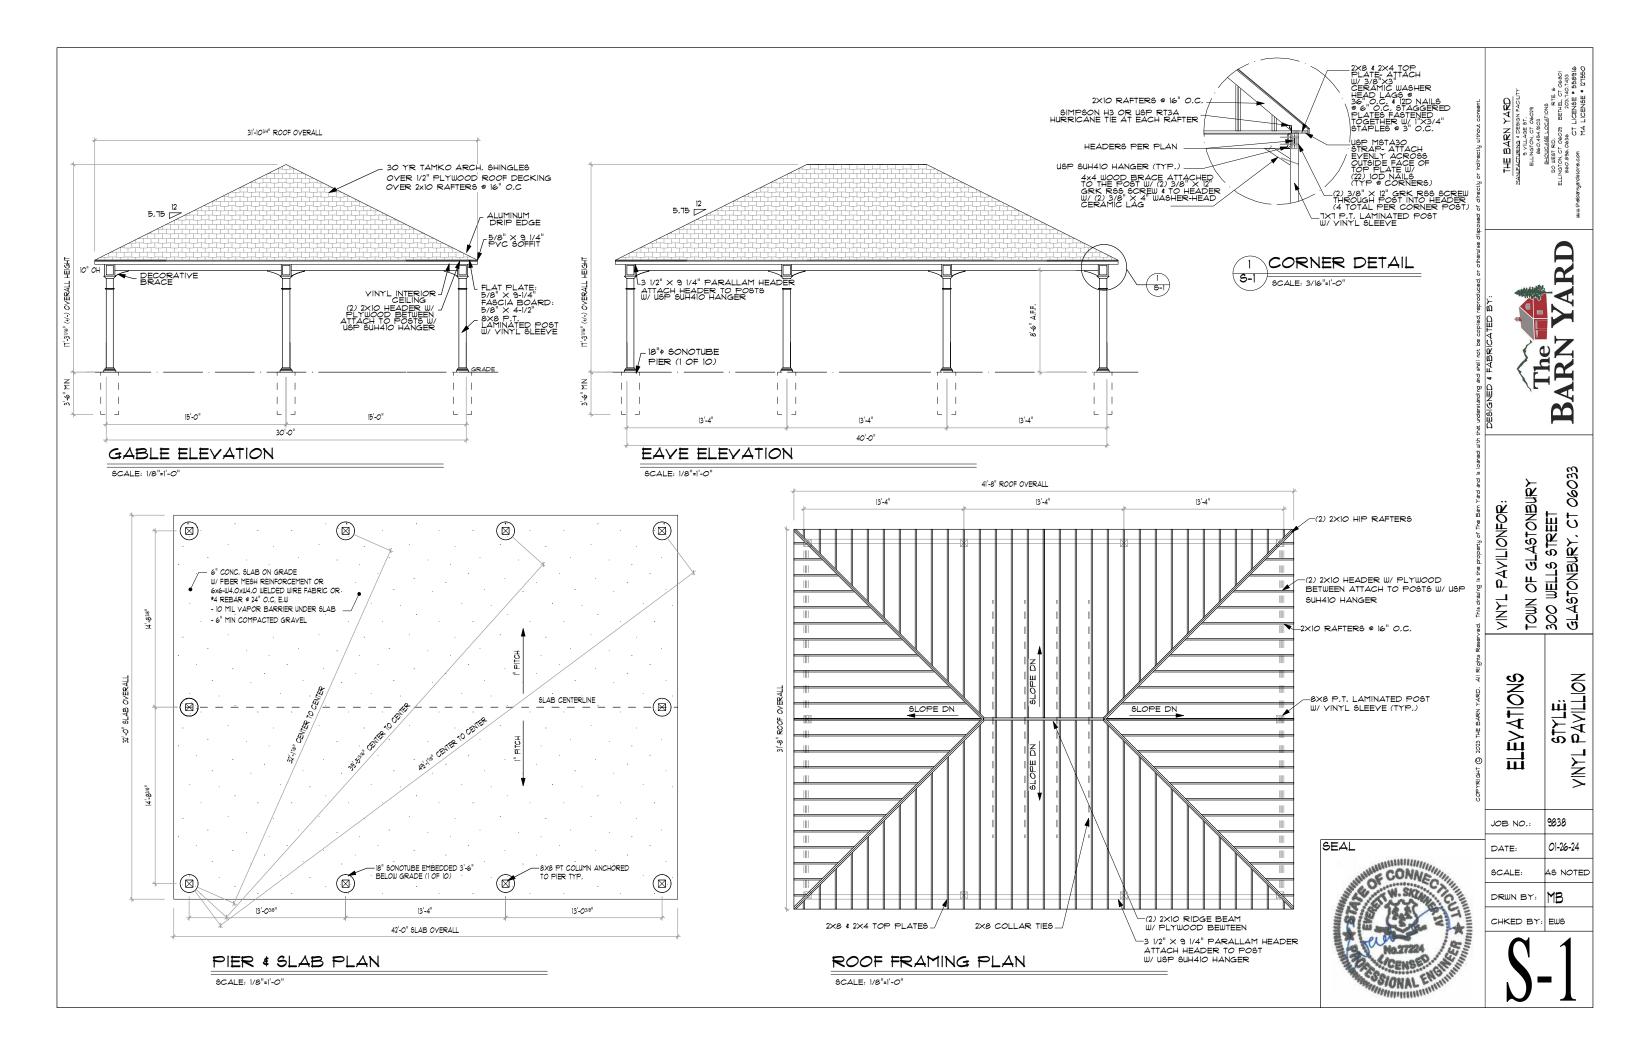


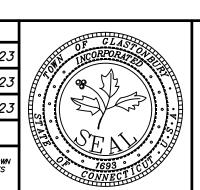DETAILS DEPICTING COMMUNITY CENTER PAVILLION LOCATED AT RIVERFRONT COMMUNITY CENTER 300 WELLES STREET

SHEET NO OF <u>4</u> GLASTONBURY, CONNECTICUT

P.W. 2215 NO.


DESCRIPTION



## SE-1 SITE ELECTRICAL PLAN SE-3 PICKLEBALL COURTS POWER RISER DIAGRAM AND DETAILS TOWN OF GLASTONBURY RIVERFRONT COMMUNITY CENTER 300 WELLES STREET GLASTONBURY, CONNECTICUT 06033 PICKLEBALL LIGHTING AND PAVILION POWER MEP ENGINEER BEMIS ASSOCIATES LLC 185 MAIN STREET FARMINGTON, CONNECTICUT Phone: 860-667-3233 Fax: 860-321-7070

LIST OF DRAWINGS


COVER SHEET

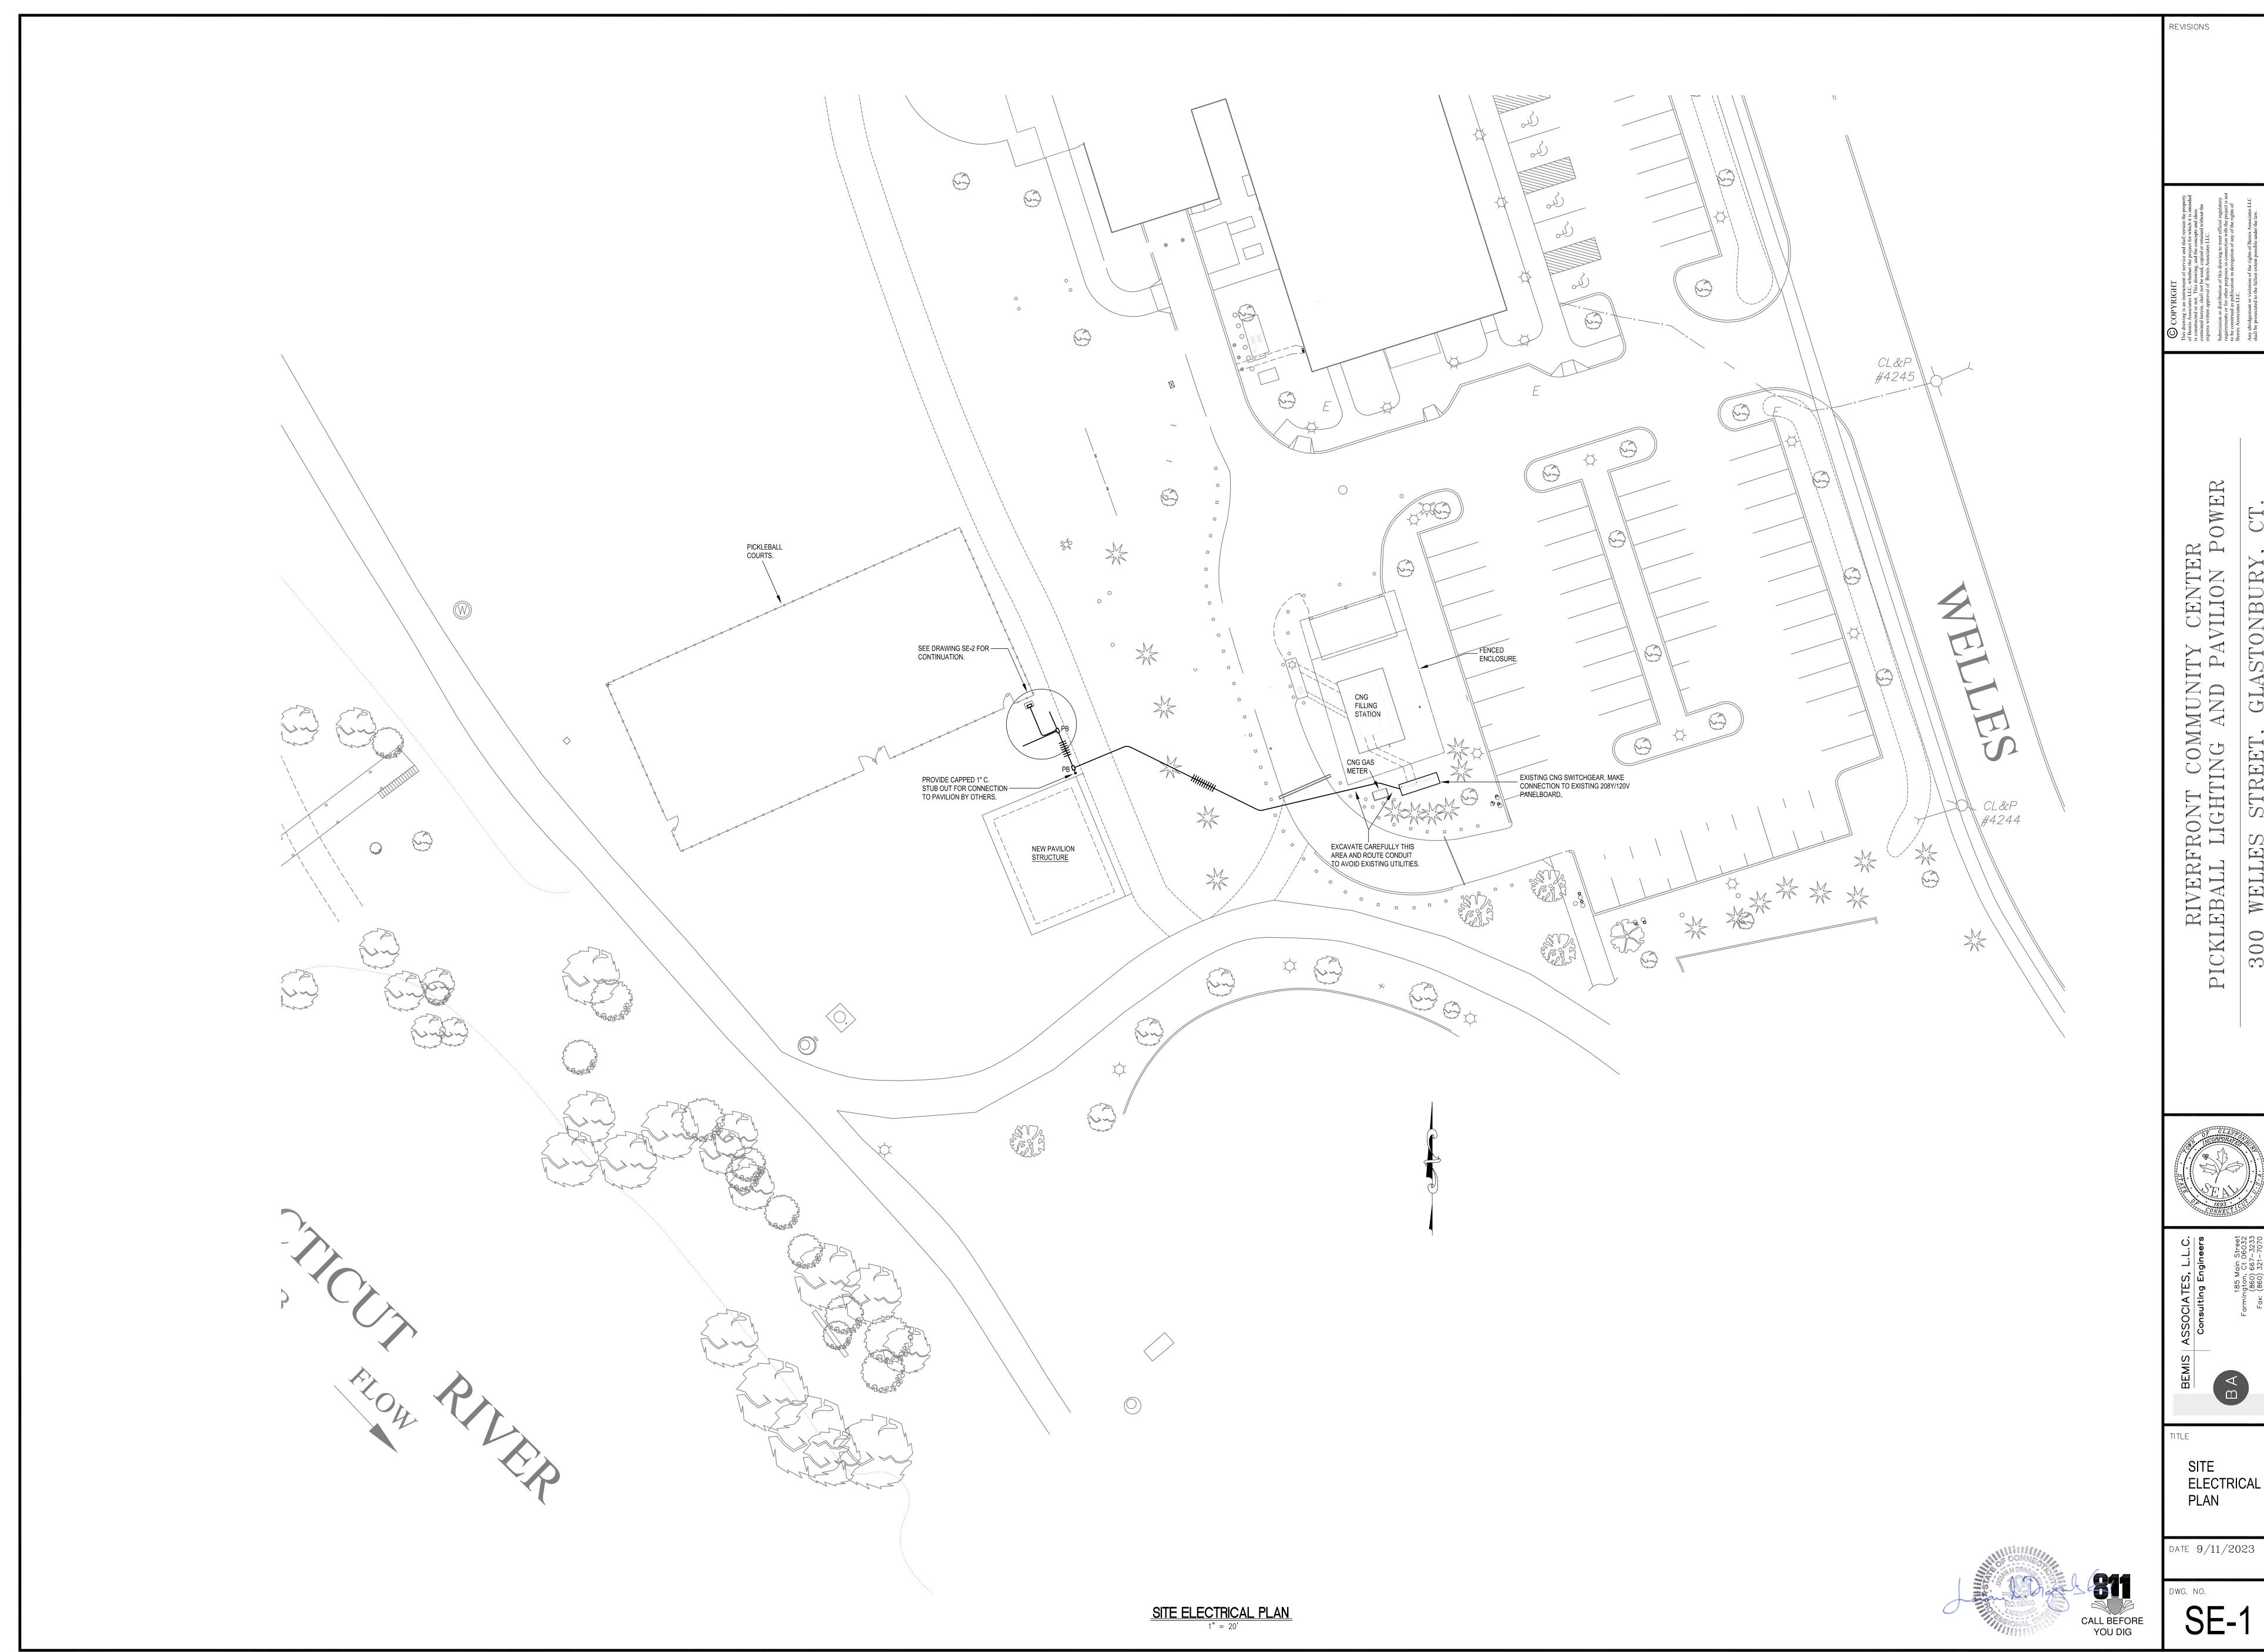


STREET,

DATE 9/11/2023

SE-1

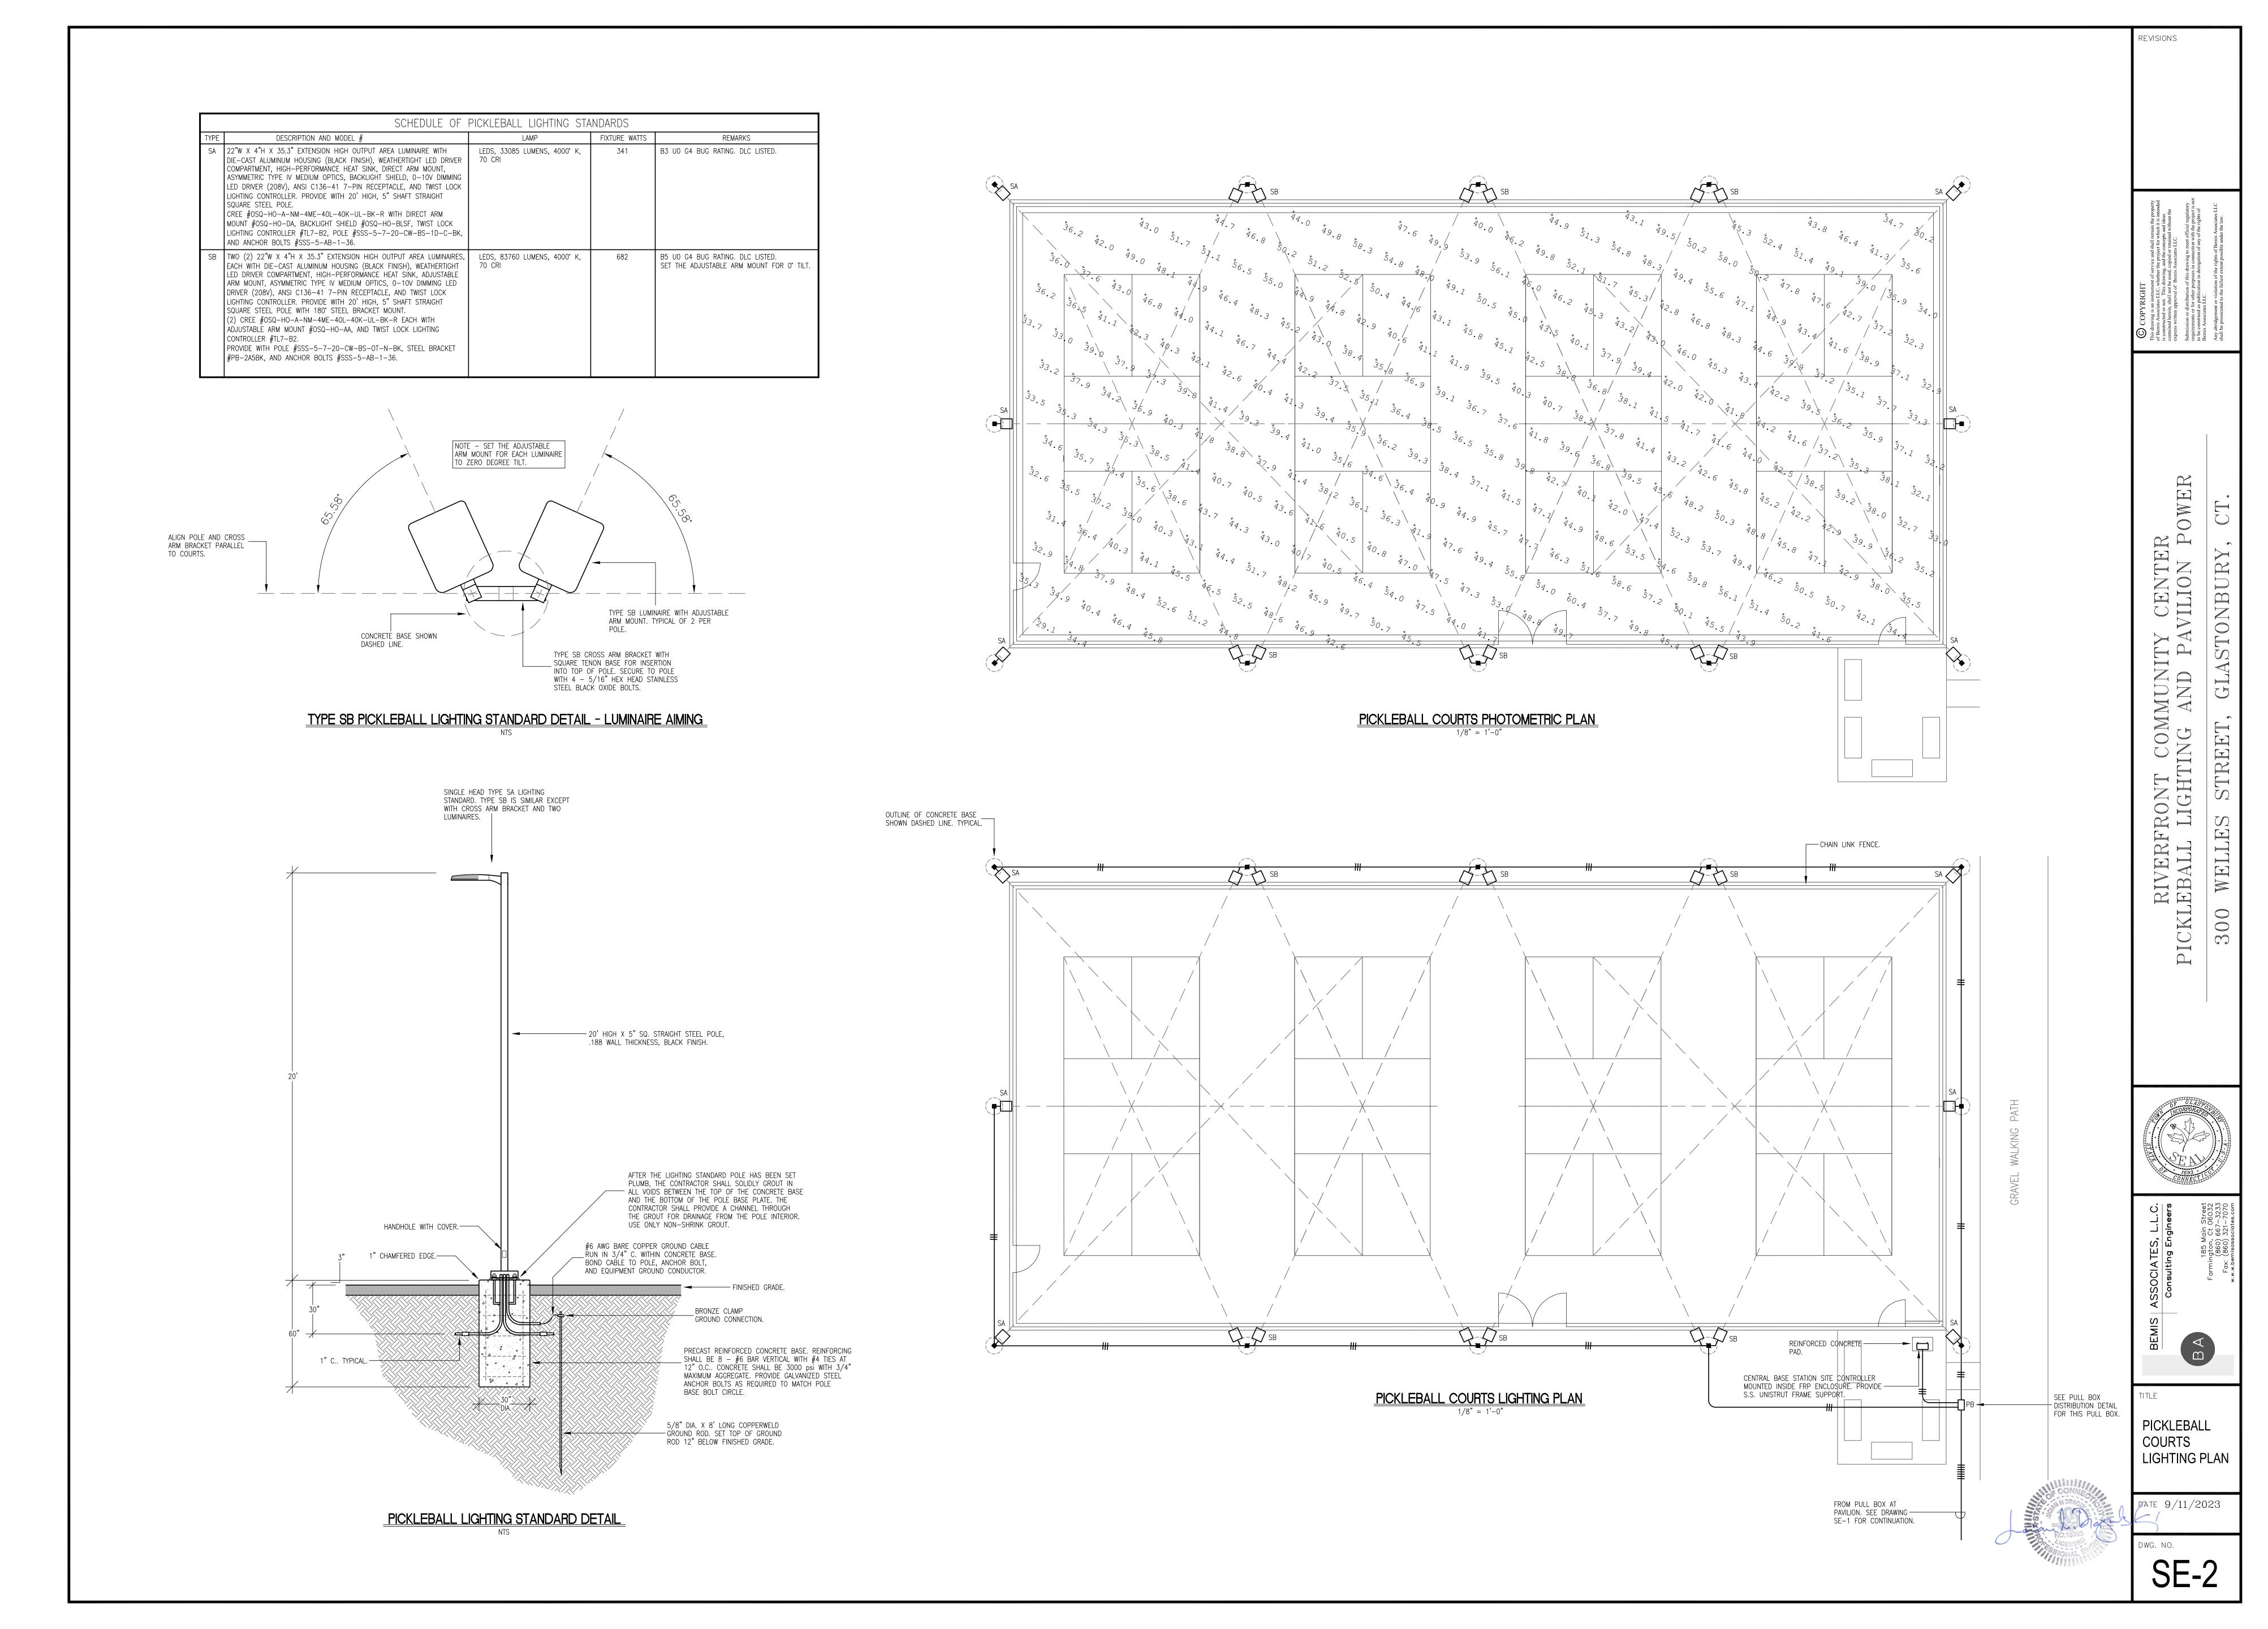

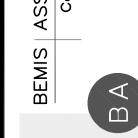

TITLE **PICKLEBALL COURTS POWER** 

RISER DIAGRAM AND DETAILS

DATE 9/11/2023

ELECTRICAL SPECIFICATION NOTES

I - THE PROJECT SCOPE OF WORK INCLUDES BUT IS NOT LIMITED TO THE FOLLOWING: A. CONNECTIONS TO EXISTING PANELBOARD. B. FRP ENCLOSURE AND MOUNTING STANCHION.

C. PICKLEBALL LIGHTING STANDARDS AND CONTROLS. D. REINFORCED PRECAST LIGHTING STANDARD CONCRETE BASES. E. BRANCH CIRCUIT WIRING. F. CIRCUIT BREAKERS.

G. PULL BOXES. H. TRENCHING AND BACKFILL. I. RESTORATION OF DISTURBED PAVEMENT AND LAWN.

- THE CONTRACTOR SHALL VERIFY AND OBTAIN ALL NECESSARY DIMENSIONS AT THE BUILDING 3 - FINISHED WORK: THE INTENT OF THE SPECIFICATIONS AND DRAWINGS IS TO CALL FOR

FINISHED WORK, COMPLETED, TESTED AND READY FOR OPERATION. 4 - GOOD PRACTICE: IT IS NOT INTENDED THAT THE DRAWINGS SHOW EVERY CONDUIT, JUNCTION BOX, FITTING OR MINOR DETAIL AND IT IS UNDERSTOOD THAT WHILE THE DRAWINGS MUST BE FOLLOWED AS CLOSELY AS CIRCUMSTANCES WILL PERMIT, THE SYSTEMS SHALL BE INSTALLED ACCORDING TO THE INTENT AND MEANING OF THE CONTRACT DOCUMENTS AND IN ACCORDANCE WITH GOOD PRACTICE.

- CODES AND STANDARDS - COMPLY WITH ALL FEDERAL, STATE AND LOCAL CODES AND STANDARDS WHEREVER APPLICABLE INCLUDING THE FOLLOWING: 2022 CONNECTICUT STATE BUILDING CODE, 2021 INTERNATIONAL BUILDING CODE, 2022 CONNECTICUT FIRE SAFETY CODE, 2021 INTERNATIONAL FIRE CODE, 2020 NFPA 70 NATIONAL ELECTRICAL CODE, ICC/ANSI A117.1-2017 ACCESSIBLE AND USABLE BUILDINGS AND FACILITIES, ADA, NFPA, UNDERWRITERS LABORATORIES, FACTORY MUTUAL INSURANCE COMPANY, NEMA STANDARDS.

3 - NOTE THAT THE DRAWINGS ARE DIAGRAMMATIC AND INDICATE THE GENERAL ARRANGEMENT OF THE ELECTRICAL EQUIPMENT AND SYSTEMS, WITHOUT SHOWING EVERY DETAIL AND FITTING. 7 - RACEWAYS


A. PROVIDE EMT CONDUIT FOR ALL ABOVE GRADE WORK. CONNECTORS, COUPLINGS, AND FITTINGS SHALL BE WATER TIGHT GALVANIZED STEEL GLAND COMPRESSION TYPE. B. PROVIDE RIGID PVC CONDUIT FOR ALL UNDERGROUND WORK. PVC CONDUIT SHALL BE HEAVY WALL SCHEDULE 40 PVC FOR UNDERGROUND WORK AND EXTRA HEAVY WALL SCHEDULE 80 PVC FOR UNDERGROUND WORK BELOW VEHICULAR TRAFFIC AREAS. JOINTS AND FITTINGS SHALL BE SOLVENT WELDED ALL TO ASTM STANDARDS FOR UNDERGROUND INSTALLATION AND IN ACCORDANCE WITH ARTICLE 352 OF THE NATIONAL ELECTRIC CODE.

C. PROVIDED RIGID METALLIC CONDUIT (RMC) WHERE CALLED FOR ON THE DRAWINGS AND FOR UNDERGROUND HORIZONTAL AND VERTICAL SWEEPS AND BENDS IN UNDERGROUND CONDUIT RUNS. RIGID STEEL CONDUIT CONNECTORS, COUPLINGS,

AND FITTINGS SHALL BE THREADED AND GALVANIZED. D. THE MINIMUM CONDUIT BURIAL DEPTH SHALL BE 30". 3 - CONDUCTORS SHALL BE COPPER, RATED 600 VOLTS, 90 DEG. C., COLOR CODED, TYPE THWN-2

FOR SIZES #10 AWG AND SMALLER AND TYPE XHHW-2 FOR SIZES #8 AWG AND LARGER. 9 - WIRE SIZE #8 AWG AND LARGER SHALL BE STRANDED. WIRE OF SIZE SMALLER THAN #8 AWG SHALL BE SOLID.

10 - MINIMUM SIZE CONDUCTOR SHALL BE #12 AWG. MINIMUM CONDUIT SIZE SHALL BE 3/4" DIAMETER.

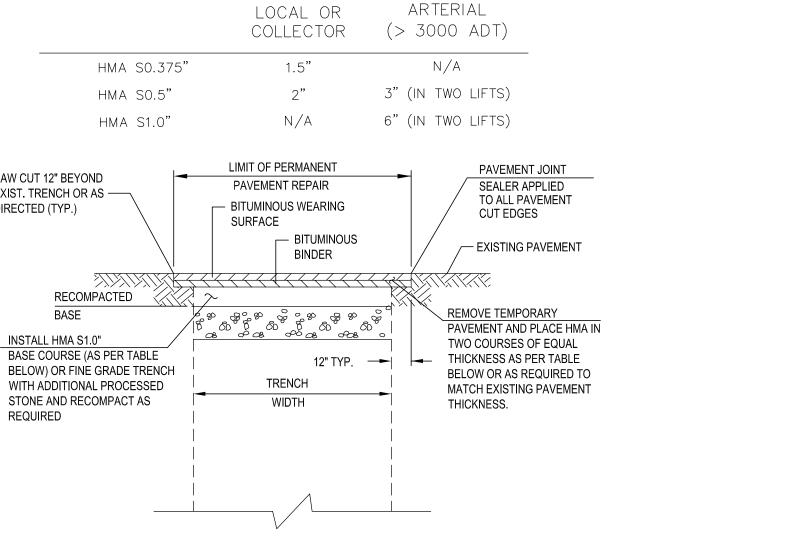


PAVEMENT REPAIR DETAIL

SAW CUT 12" BEYOND


DIRECTED (TYP.)

REQUIRED

EXIST. TRENCH OR AS ----

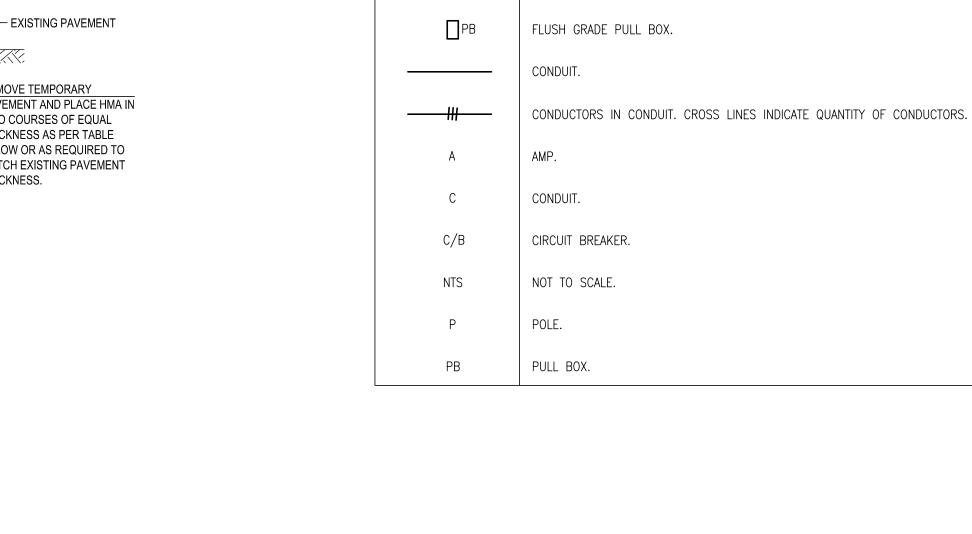

SYMBOL/ABBREVIATION

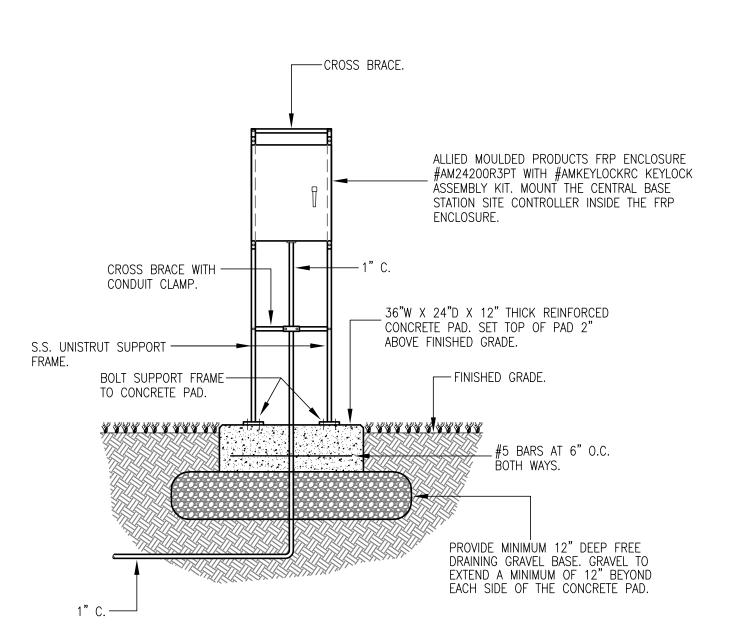

1. PROCESS STONE BASE SHALL BE CRUSHED TRAP ROCK

AGGREGATE SHALL NOT BE USED.

TOWN ENGINEER.

CONFORMING TO ARTICLE M.05.01 OF THE FORM 817 AND TOWN

PAVEMENT OR CONCRETE BASE MAY CONSIST OF 2" HMA S0.5", 6"

3. AT THE REQUEST OF THE TOWN ENGINEER THE CONTRACTOR SHALL

HMA S1.0", AND 10" GRAVEL SUBBASE AT THE DISCRETION OF THE


VERIFY AND SUBMIT PROPER TESTING RESULTS THAT COMPACTION

MEETS WITH TOWN'S STANDARDS FOR A 95% COMPACTED DENSITY.


SPECIFICATIONS. GRAVEL OR RECLAIMED MISCELLANEOUS

2. PERMANENT TRENCH REPAIRS FOR STREETS WITH CONCRETE

CENTRAL BASE STATION FRP ENCLOSURE DETAIL

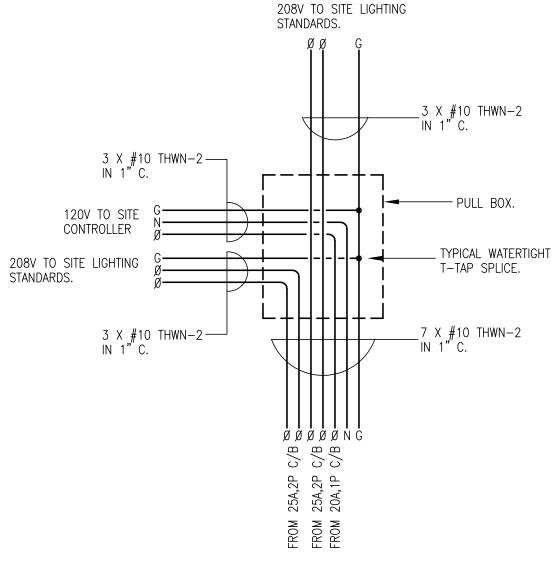

PULL BOX DISTRIBUTION DETAIL

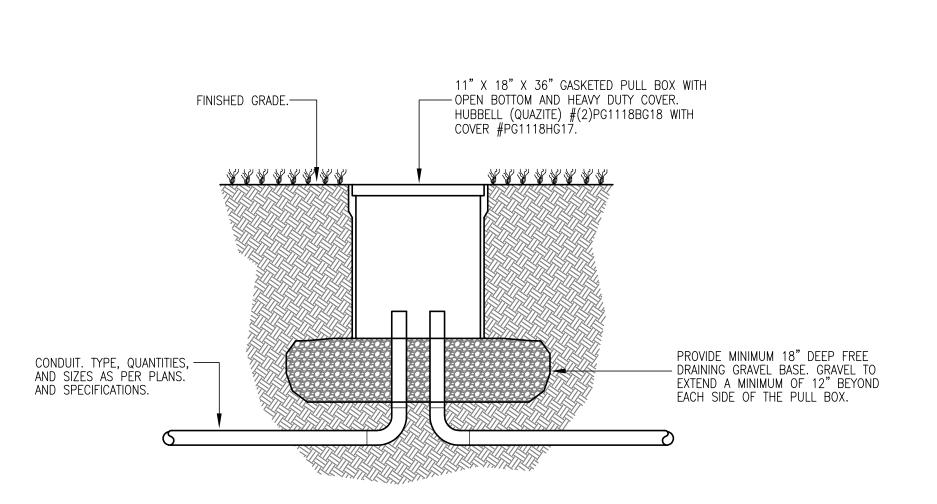


DRAWING LEGEND

SINGLE HEAD PICKLEBALL LIGHTING STANDARD.

TWO HEAD PICKLEBALL LIGHTING STANDARD.

DESCRIPTION

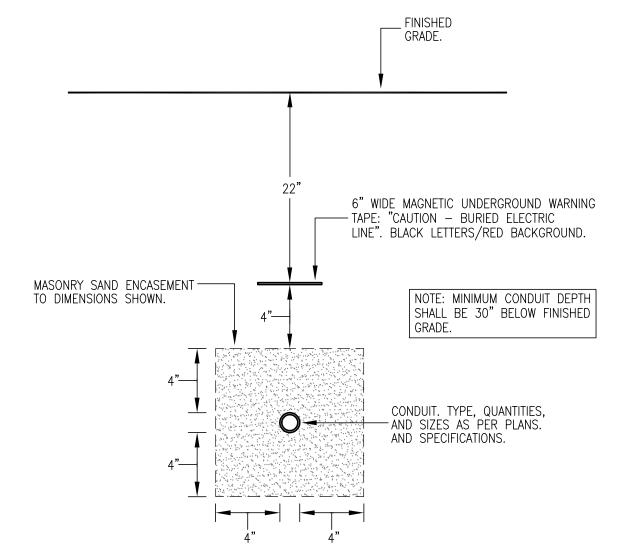

UNDERGROUND CONDUIT DETAIL

