# DRAWING INDEX A0.1 GENERAL NOTES, AND

40.1 GENERAL NOTES, AND DEMOLITION PLAN 41.0 FOUNDATION PLAN

FIRST FLOOR PLAN

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A2.0 EAST AND WEST EXTERIOR ELEVATIONS

A2.1 SOUTH EXTERIOR ELEVATION AND BUILDING

SECTION

A3.0 TYP. WALL SECTION AND WINDOW + DOOR

SCHEDULES

### **GENERAL NOTES:**

All work shall be in accordance with the current Connecticut Building Code of which the 2015 International Residential Code and 2015 International Energy Code is a part. All electric installations shall in accordance with the 2017 National Electric Code (NFPA 70).

Windows shall be furnished and installed in accordance with R301.2.1.2 of the International Residential Code.

The Contractor shall maintain a current and complete set of Contract Documents at the site during all phases of construction for use by all trades.

The Contractor shall verify all dimensions in field. The Contractor shall notify the Architect immediately if there is a conflict.

The Contractor shall review with the Owner and Architect the scope of demolition prior to commencement of work to determine what elements of the existing installation, if any, should be salvaged for the owner's further use.

The Contractor shall review architectural and structural documents prior to commencement of construction, and provide bracing, shoring or reinforcement as required to maintain integrity of the existing installation.

The Contractor shall review all documents for coordination prior to commencement of construction. For example, coordinate positioning of floor joists with location of recessed lighting.

All dimensions are to the centerline of structure (posts). Centerline of of interior partition studs, and to outside of stud at exterior walls unless otherwise specified.


The Contractor may propose to the Architect substitutions or modifications to the contract documents. The Contractor may not make substitutions or modifications without the approval of the Architect. Such approvals by the Architect must be in writing when the Architect deems the impact on cost, quality, schedule or design intent is acceptable.


The Contractor shall review the location of all wall or ceiling mounted penetrations and equipment with the Owner and Architect prior to installation.

The Contractor shall be responsible to patch and repair all surfaces disturbed by New Construction.

The Contractor shall repair and reseed all lawn areas affected by New Construction.

## LEGEND

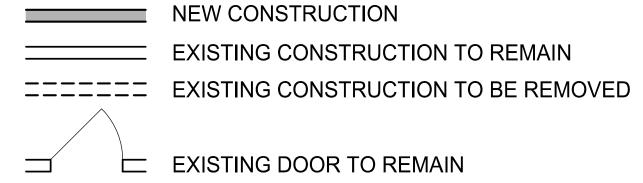

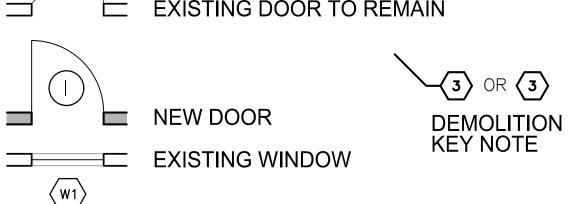

NEW WINDOW

#### **DEMOLITION KEY NOTES:**

1 REMOVE PORTION OF EXISTING WOOD-FRAMED WALL AS REQUIRED FOR NEW CONSTRUCTION.

 $\left\langle 2\right\rangle$  REMOVE EXISTING GARAGE IN ITS ENTIRETY.

REMOVE WINDOW AND ALL ASSOCIATED HARDWARE IN ITS ENTIRETY.

REMOVE DOOR AND ALL ASSOCIATED HARDWARE IN ITS ENTIRETY.

FREMOVE PORTION OF EXISTING FRONT ENTRY ENCLOSURE AND WOOD-FRAMED STOOP.
CONTRACTOR TO RETAIN EXISTING FOUNDATION AND FLOOR FRAMING.

6 REMOVE PORTION OF EXISTING WOOD-FRAMED DECK AS REQUIRED BY NEW CONSTRUCTION.

REMOVE PORTION OF EXISTING ASPHALT DRIVE AS REQUIRED BY NEW CONSTRUCTION.

8 REMOVE EXISTING CASEWORK, COUNTERTOPS, AND KITCHEN APPLIANCES. RELOCATE APPLIANCES TO NEW LOCATION.

9 REMOVE EXISTING SIDING, TYPICAL THROUGHOUT.

## **DESIGN STANDARDS:**

#### **DESIGN GRAVITY LOADS**

ROOF 30 PSF 15 PSF ATTIC 10 PSF 7 PSF FLOORS 40 PSF 15 PSF

\* NOTIFY ARCHITECT OF ANY CHANGES IN DEAD LOADS PRIOR TO START OF CONSTRUCTION

\* FLOORS ARE NOT DESIGNED FOR STONE FINISHES OR HYDRONIC HEATING SYSTEMS

#### **DESIGN WIND LOADS**

Building Category - II
Wind Exposure Category - B
Wind Speed:
V (ultimate) = 125 mph
V (asd) = 97 mph

#### SNOW LOADS

Ground Snow Load = 30 psf

SEISMIC DESIGN LOADS

Seismic Design Category - B


## CODE STANDARDS

2018 CT STATE BUILDING CODE:

2015 International Building Code
2015 International Residential Code
of the International Code Council, Inc.
2015 International Existing Building Code
2015 International Plumbing Code
2015 International Mechanical Code
2015 International Energy Conservation Code
2017 NERA 70 National Electrical Code

2017 NFPA 70, National Electrical Code, of the National Fire Protection Association Inc. 2009 ICC/ANSI A117.1 Accessible and Usable Buildings and Facilities\ \DEMOLITION PLAN

 $(00)\frac{D_{1/4}}{1/4} = 1'-0"$ 

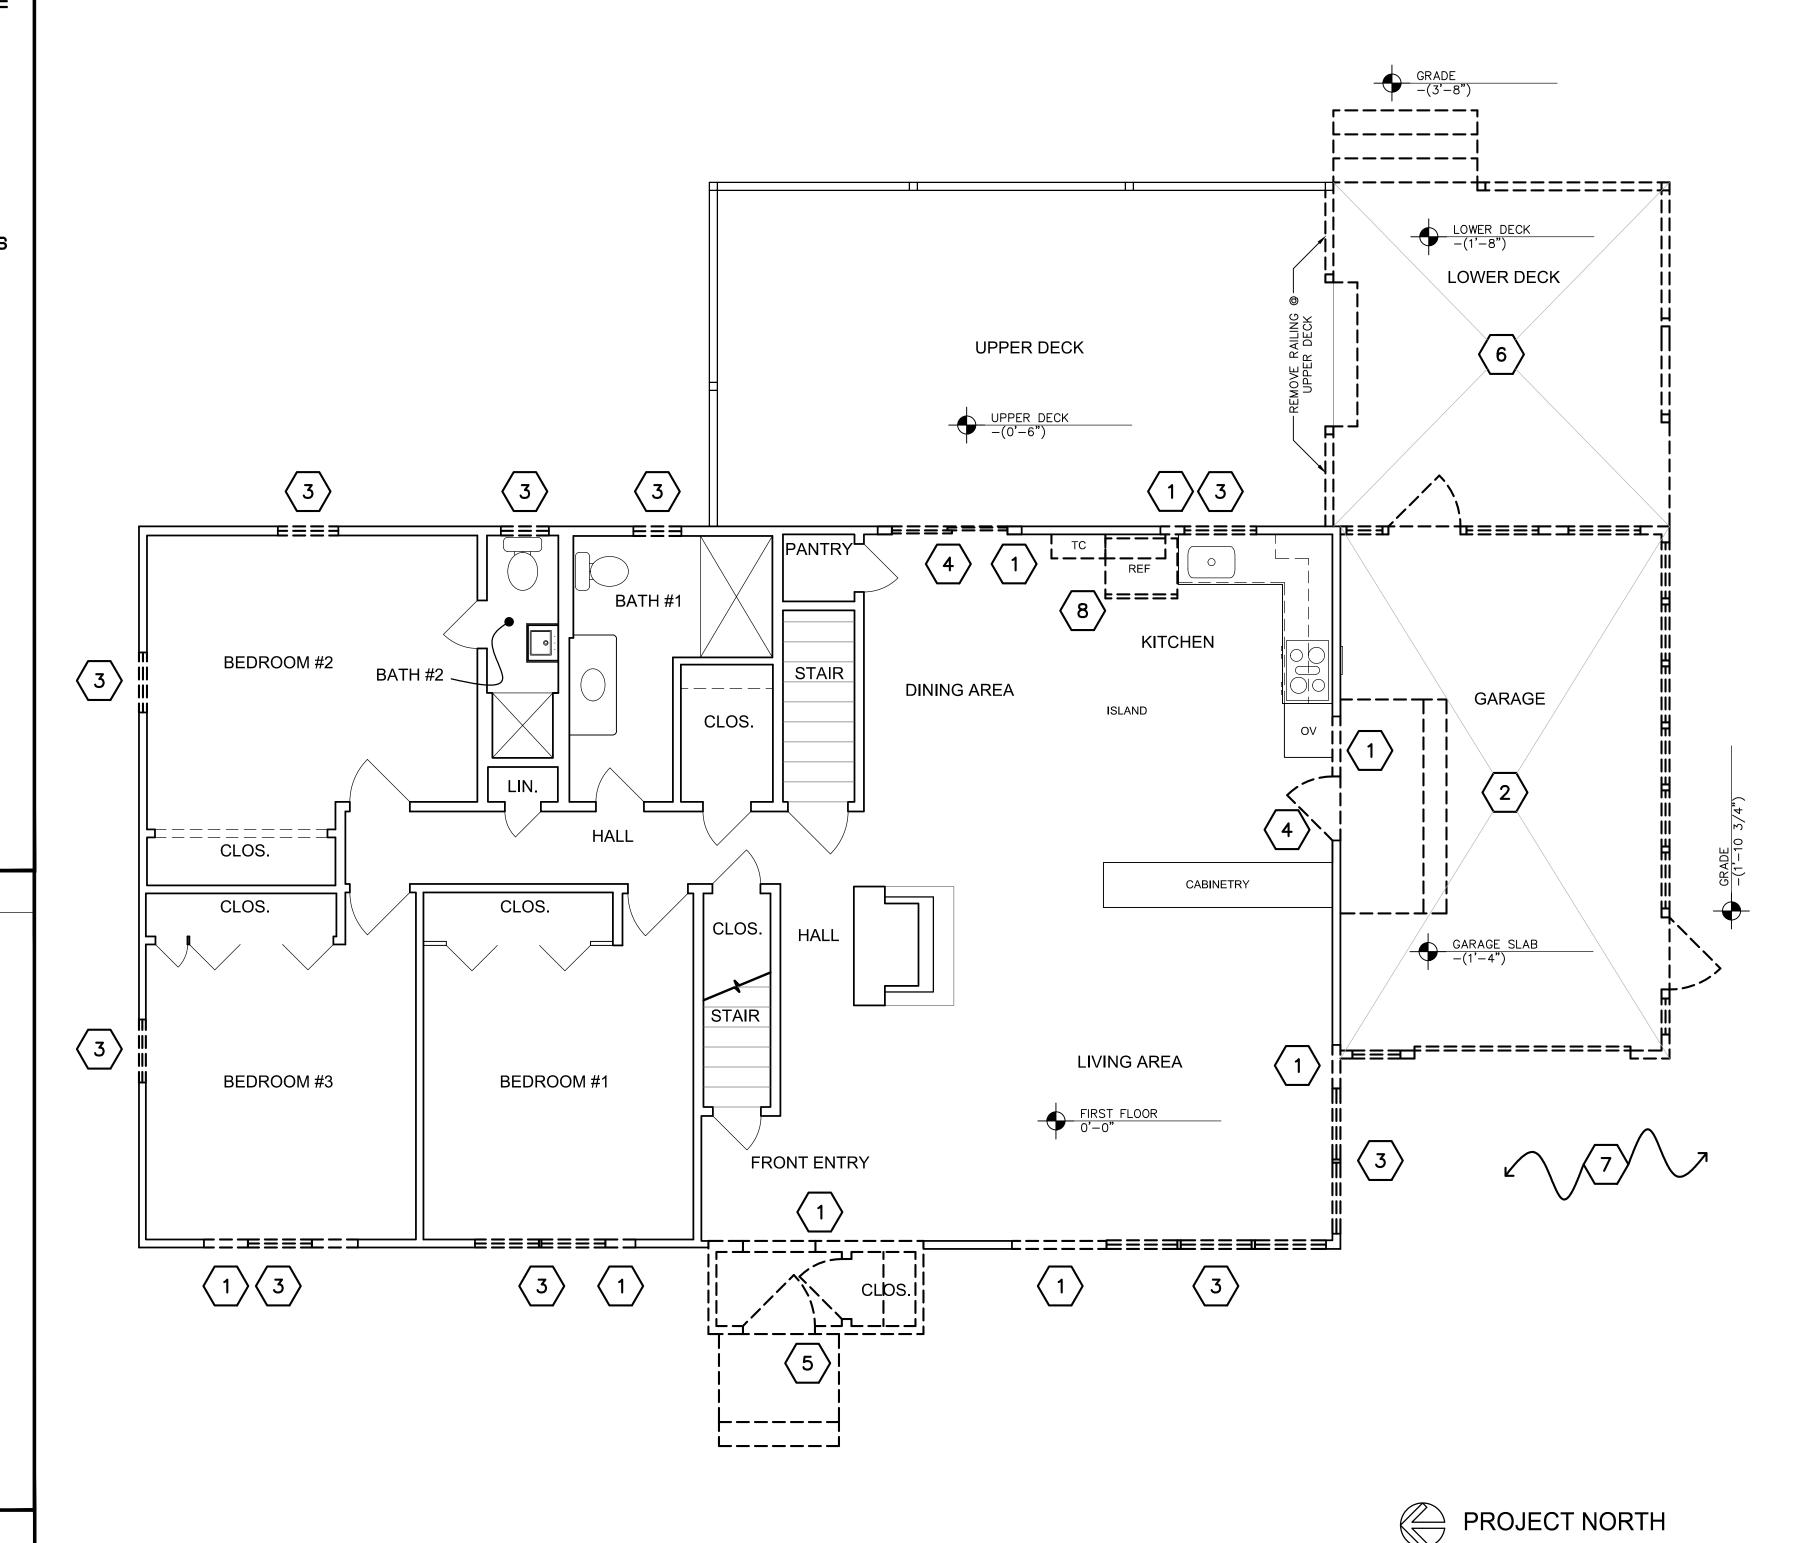



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Drawing Name:

Demolition Plan & General Notes


Scale: As Noted

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28 Thompson Strees

et 060

Drawing Name:

Foundation Plan

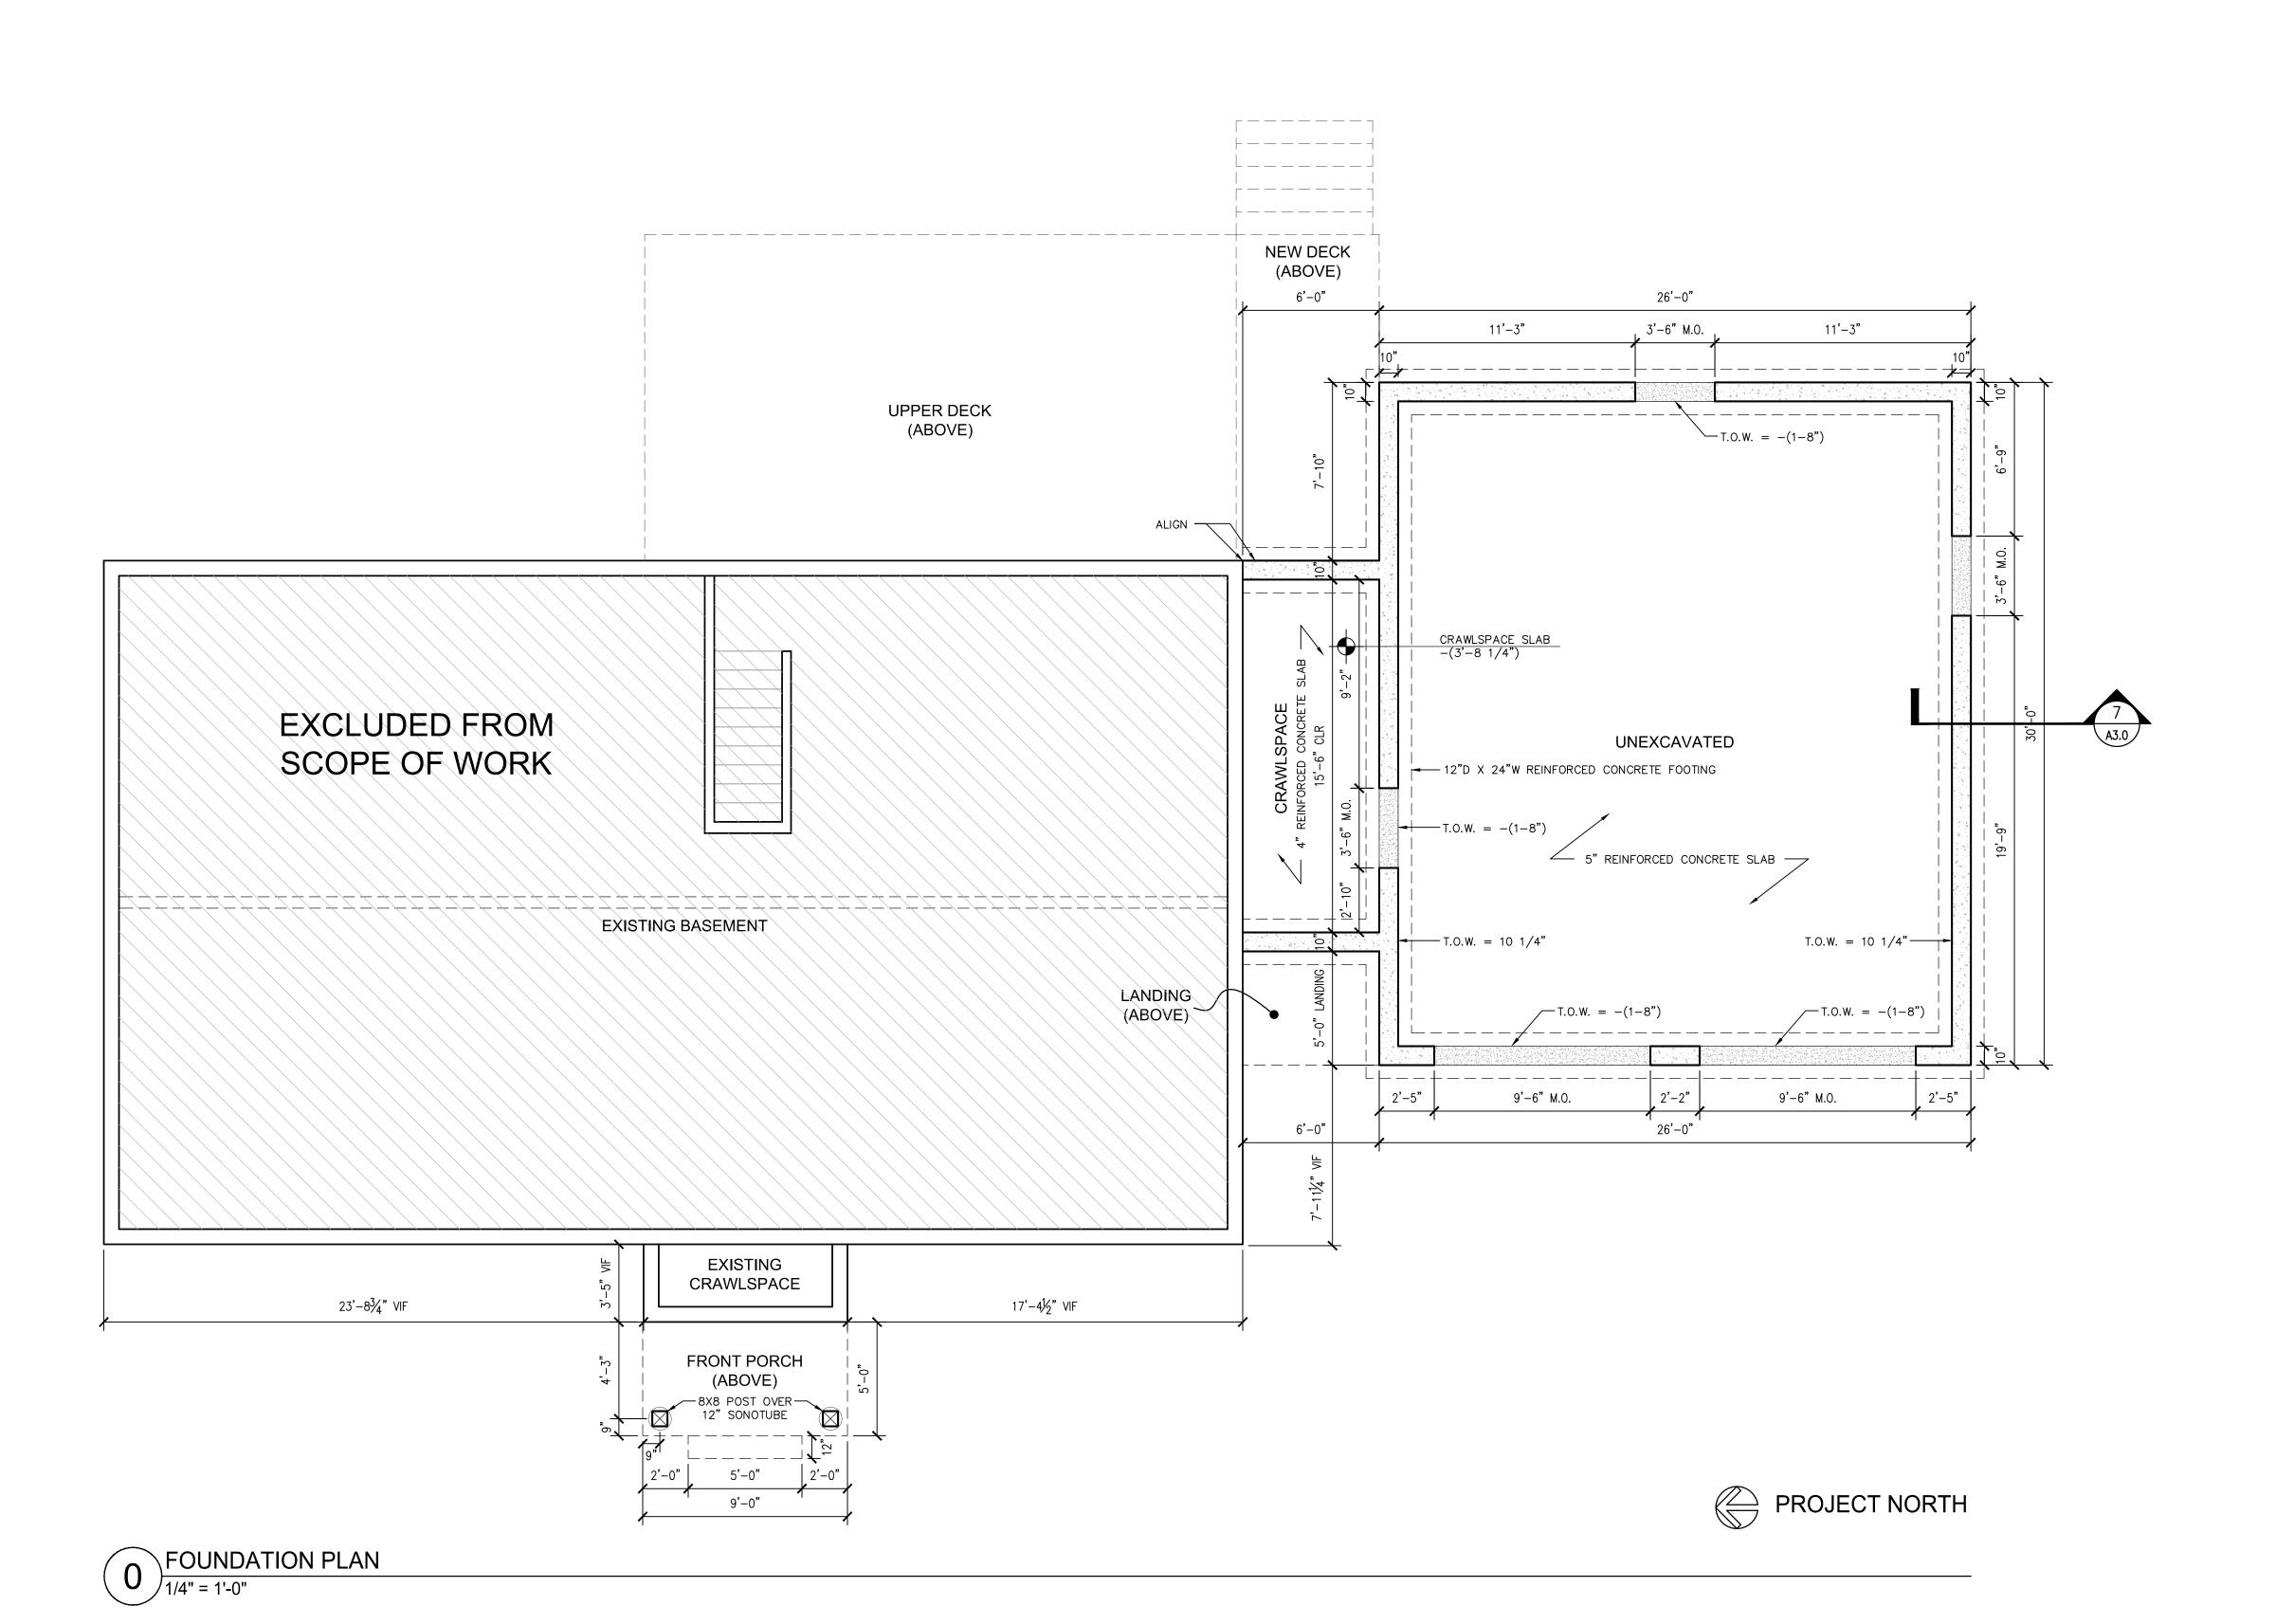
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Drawing Name:

First Floor Plan


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Drawing Name:

Second Floor Plan

Scale: As Noted
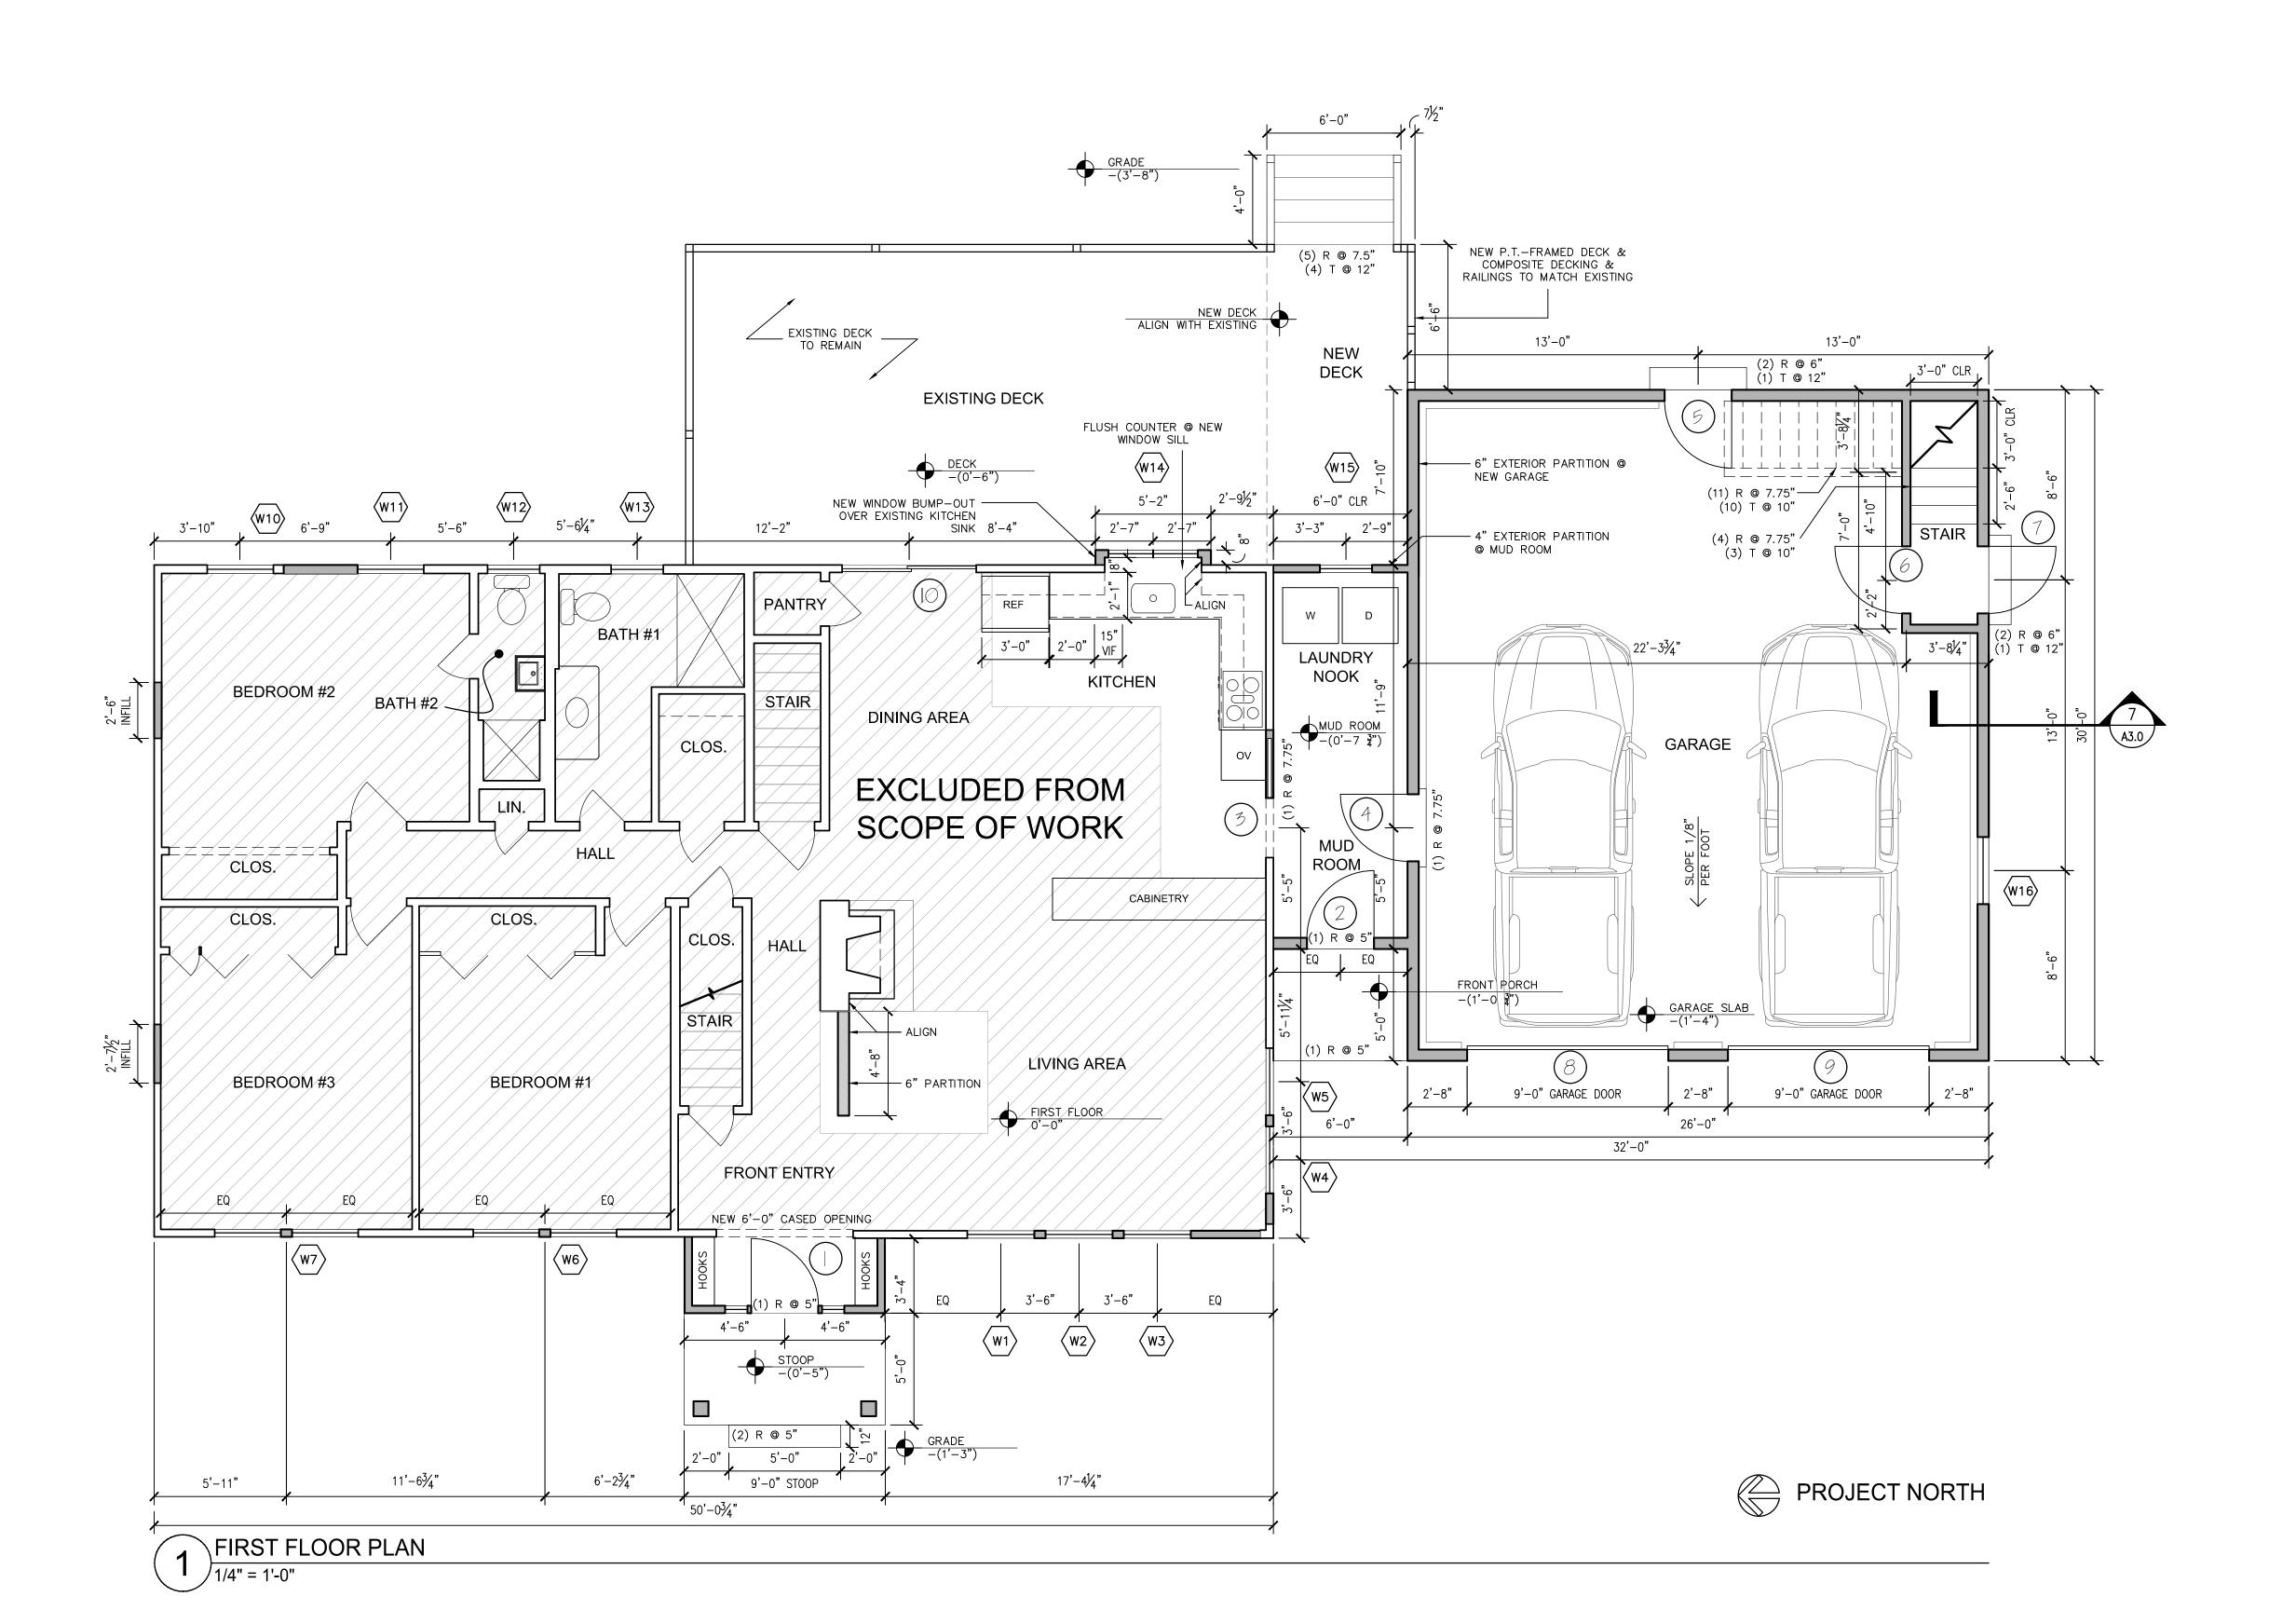
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Drawing Name:

Exterior Elevations

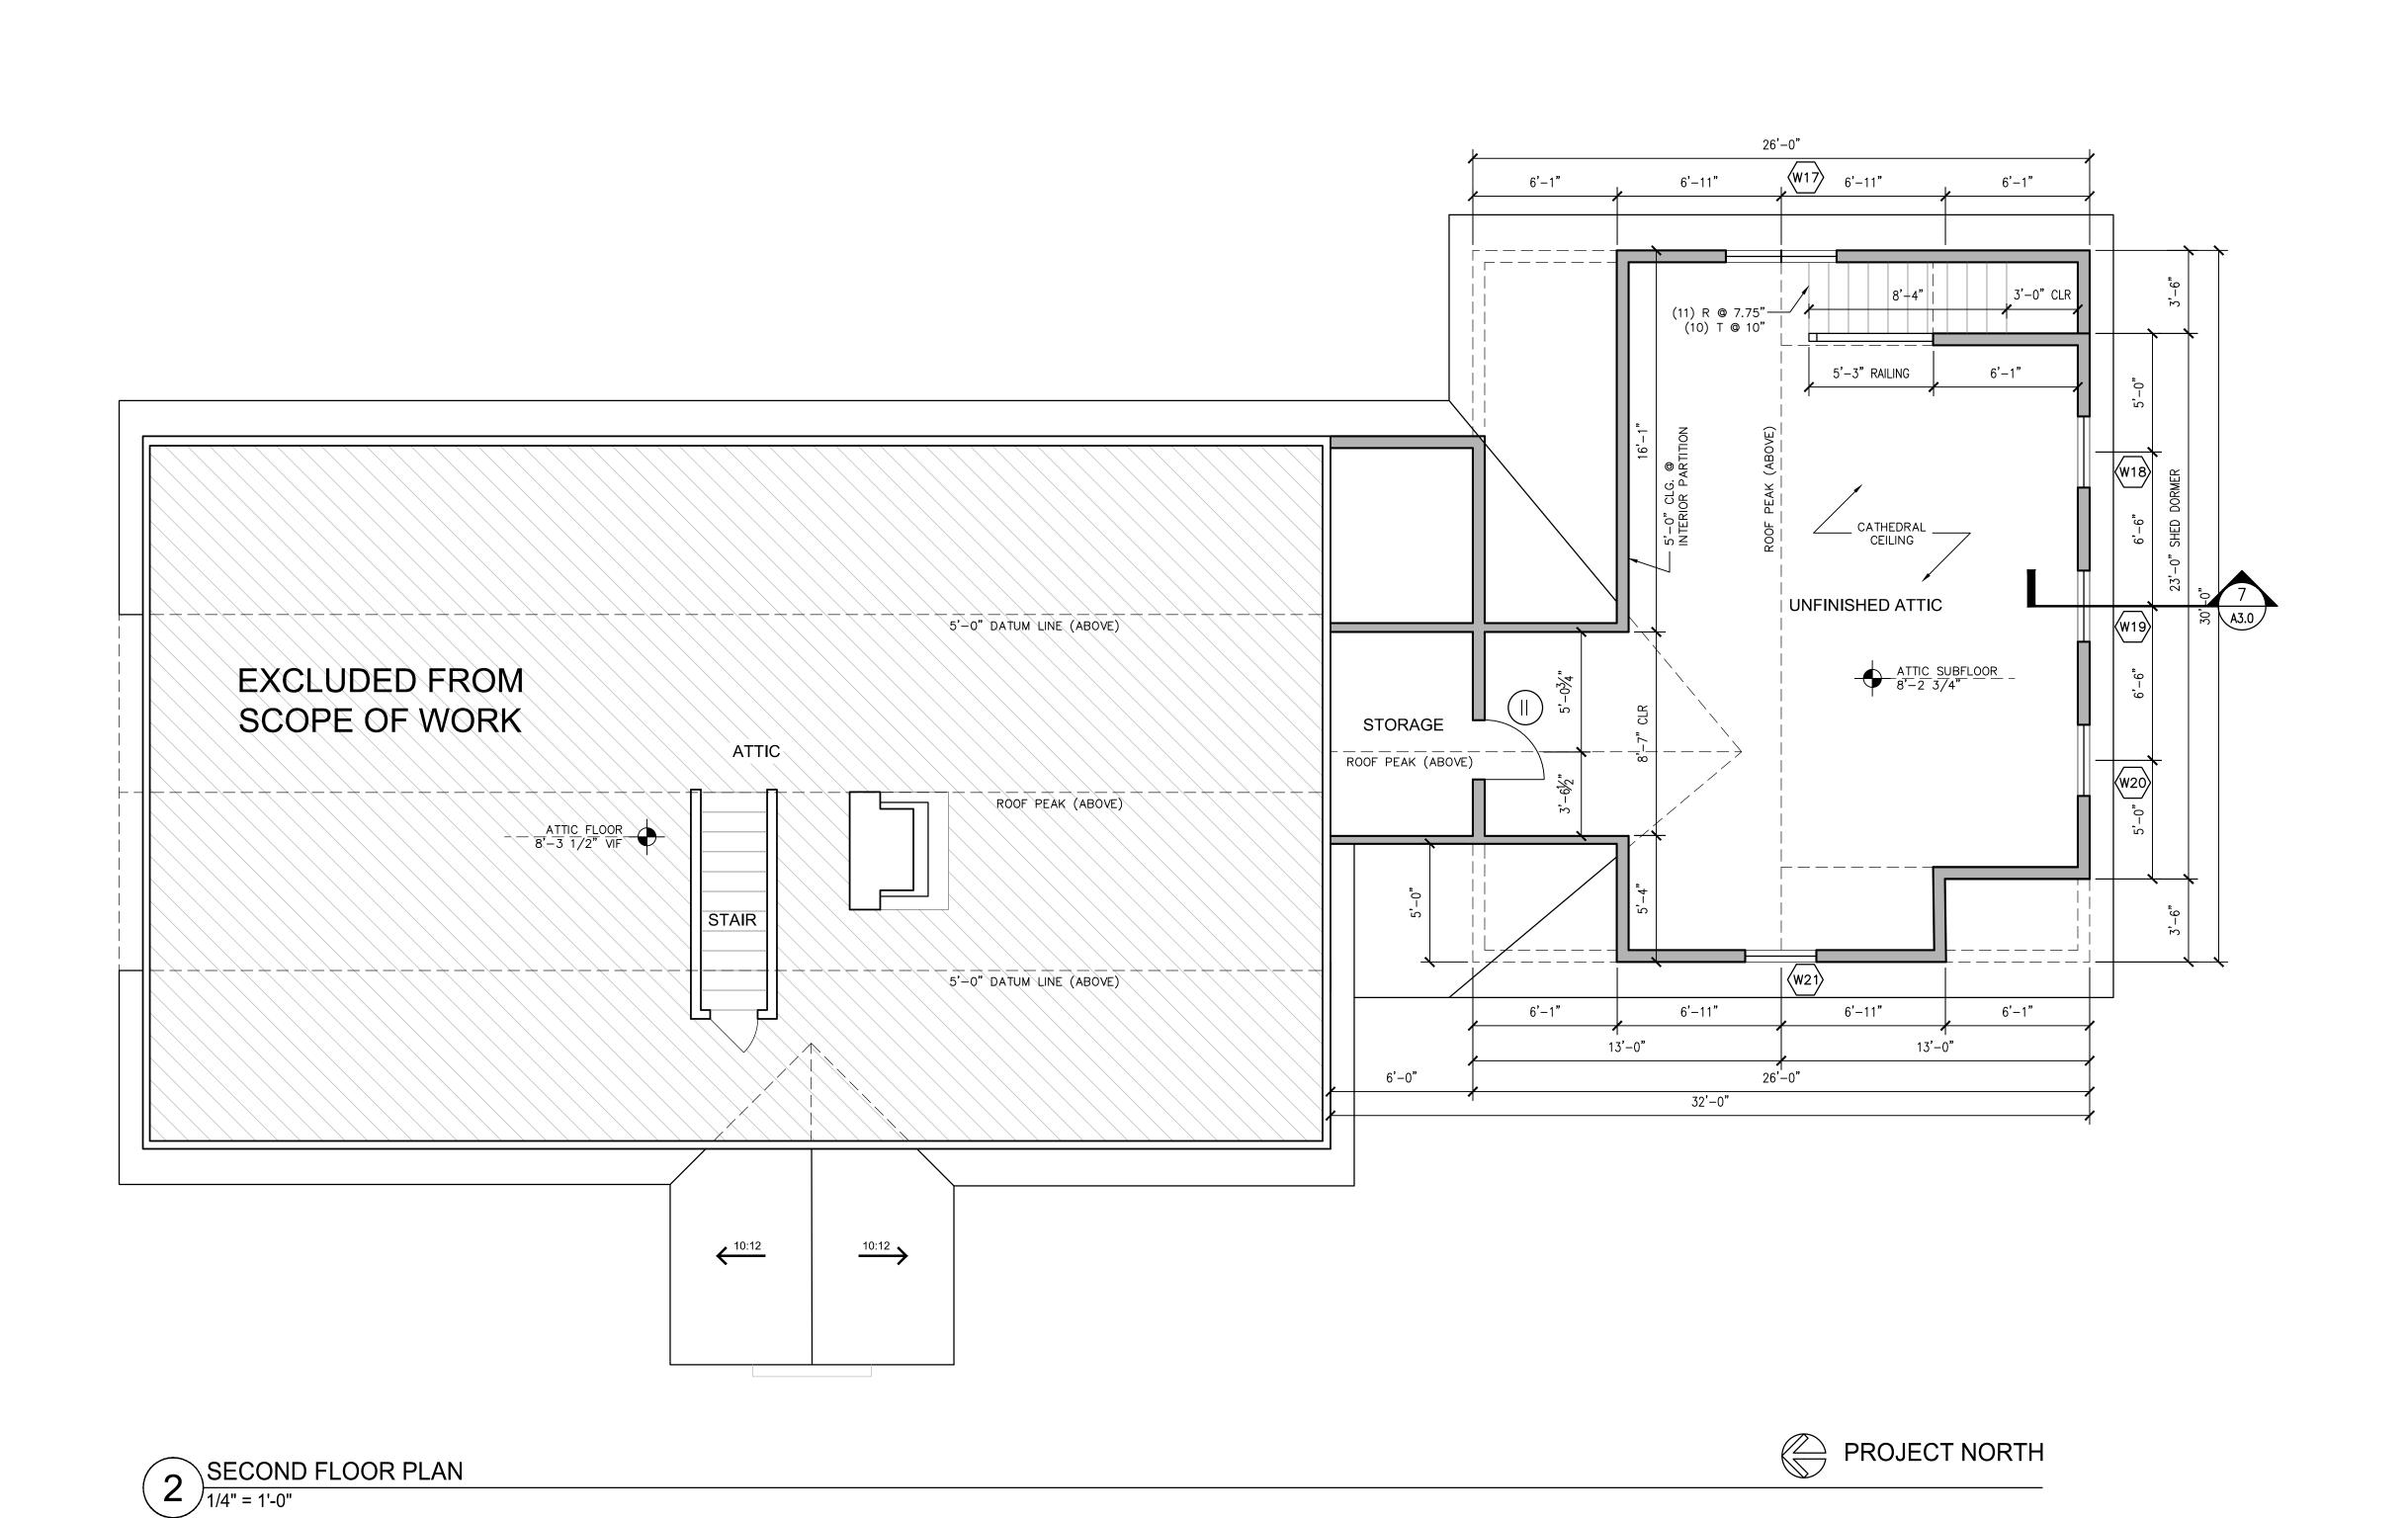
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Stree, CT 8 Thompson S Glastonbury, 28 South G

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Drawing Name:


South Exterior Elevation & **Building Section** 

Scale: As Noted

Drawn By: CN / PS

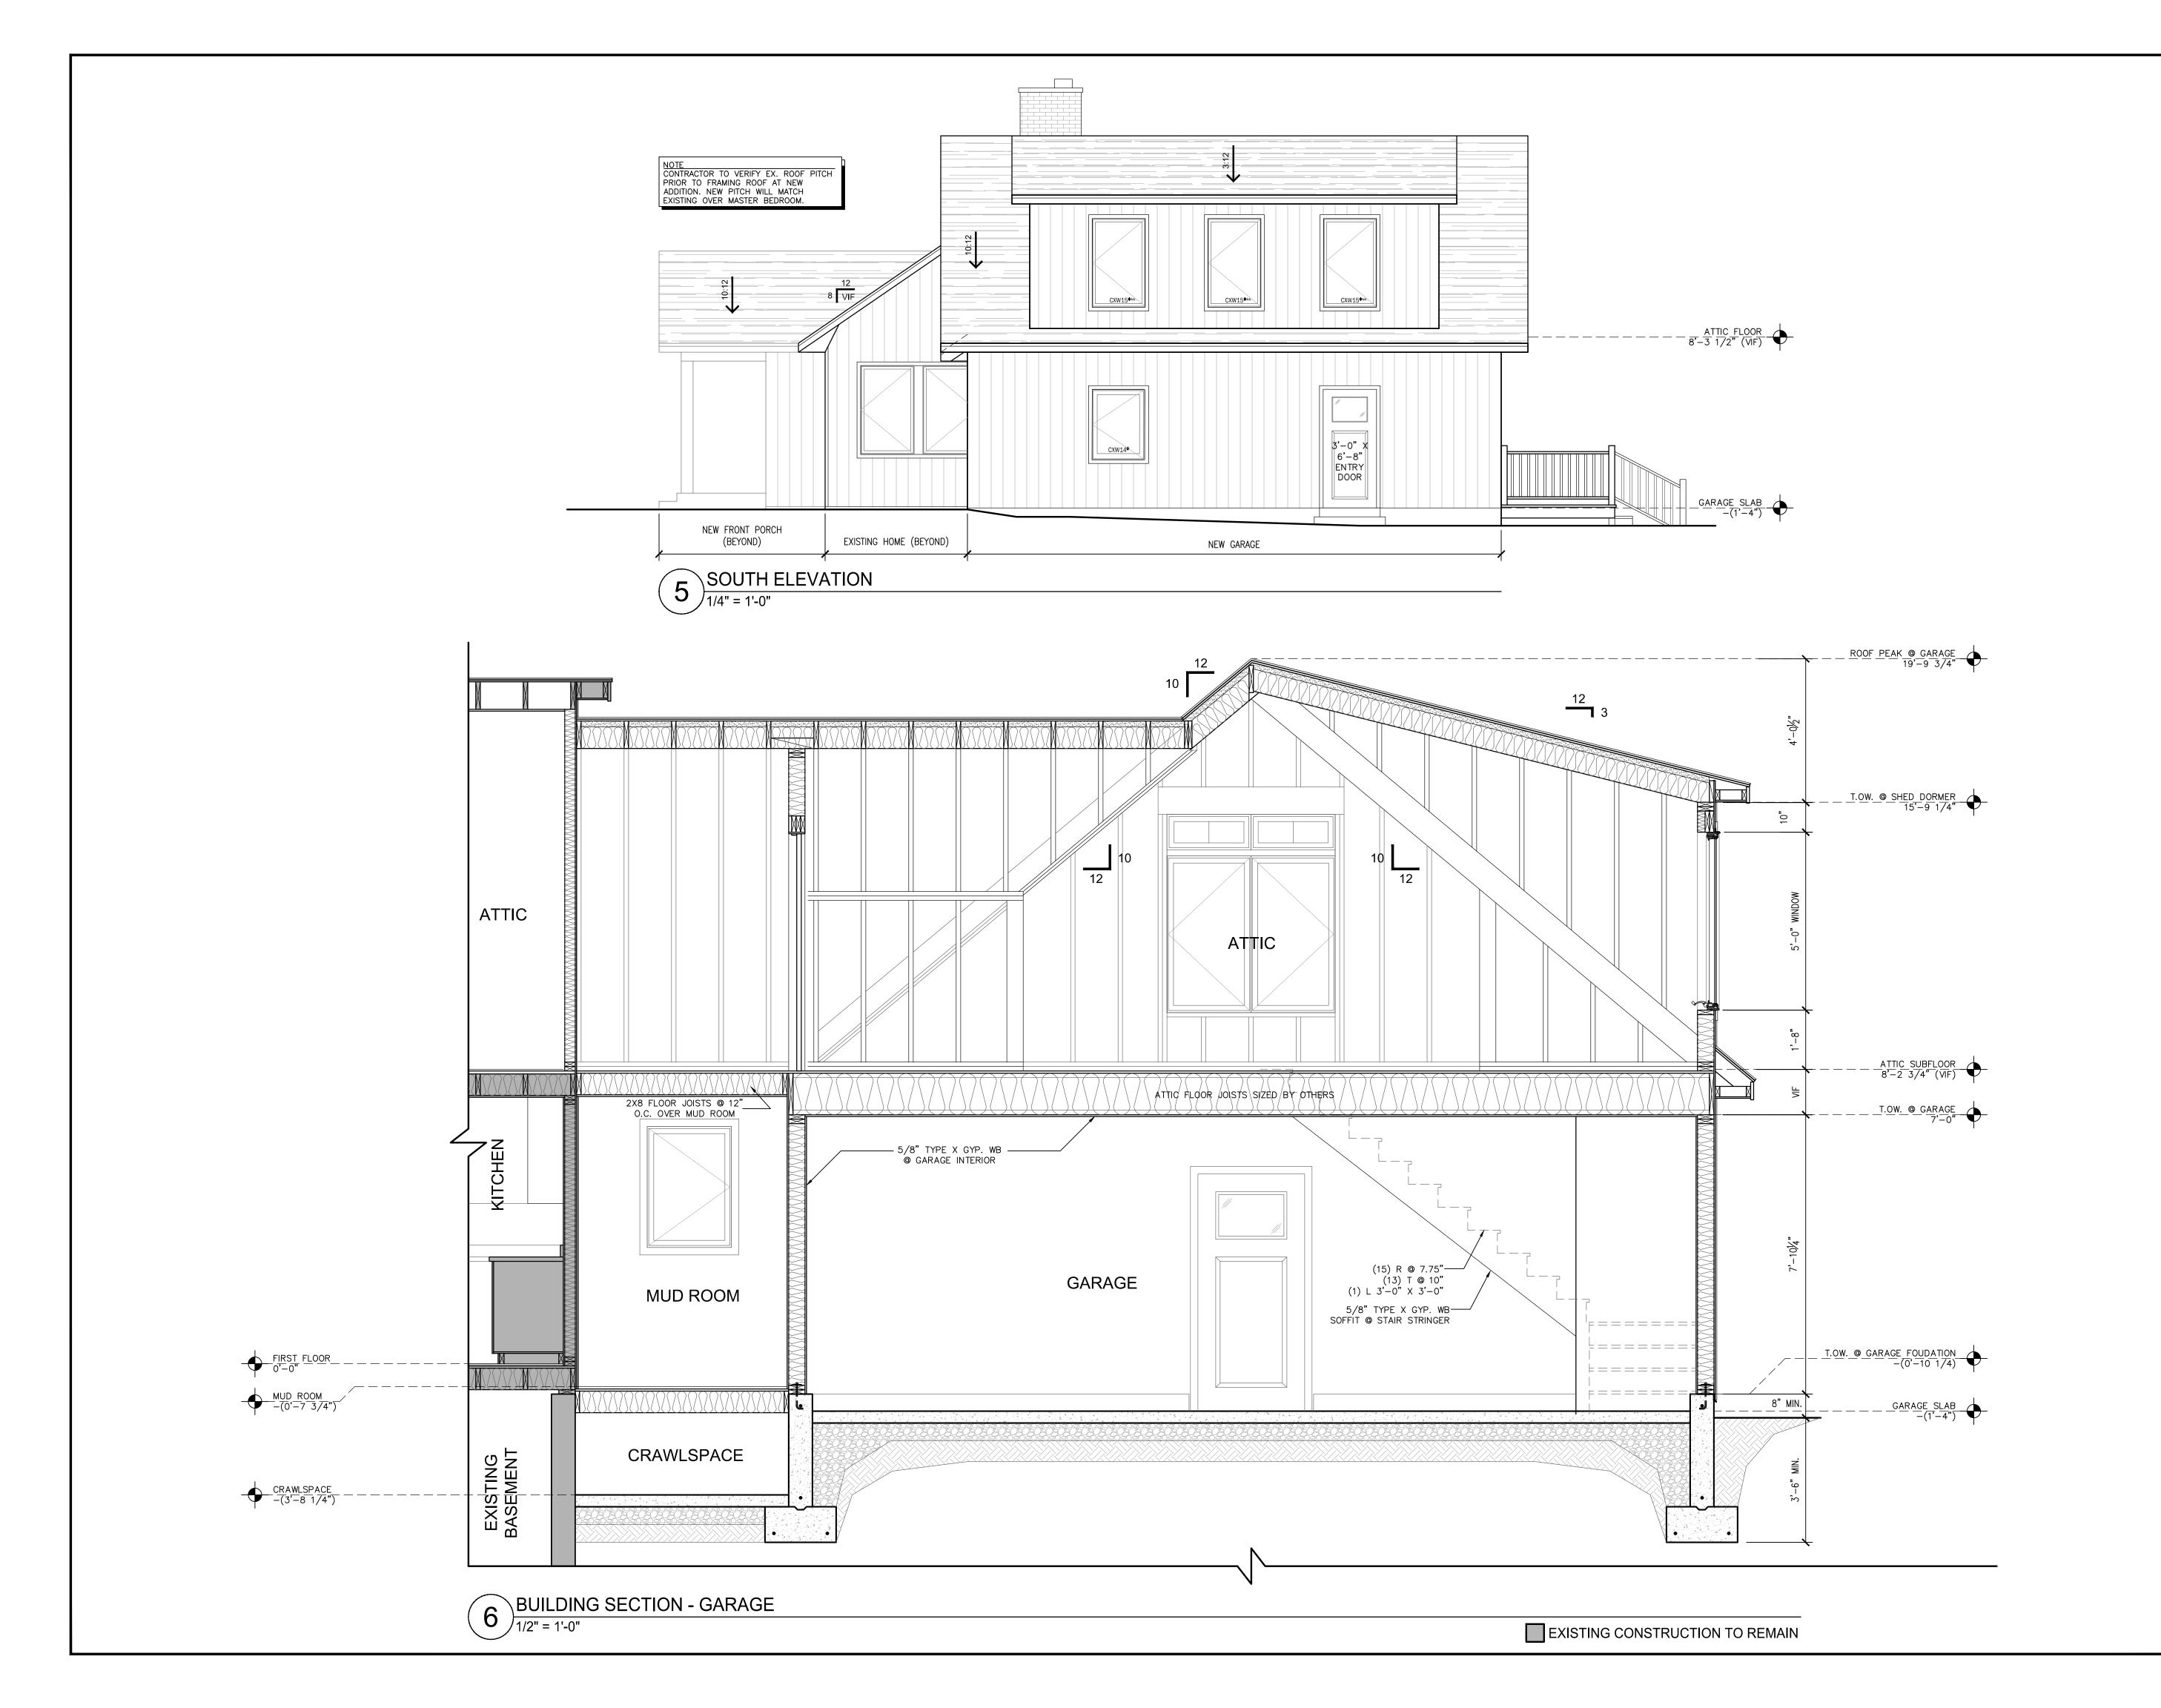Date: February 17, 2022

Drawing Number:

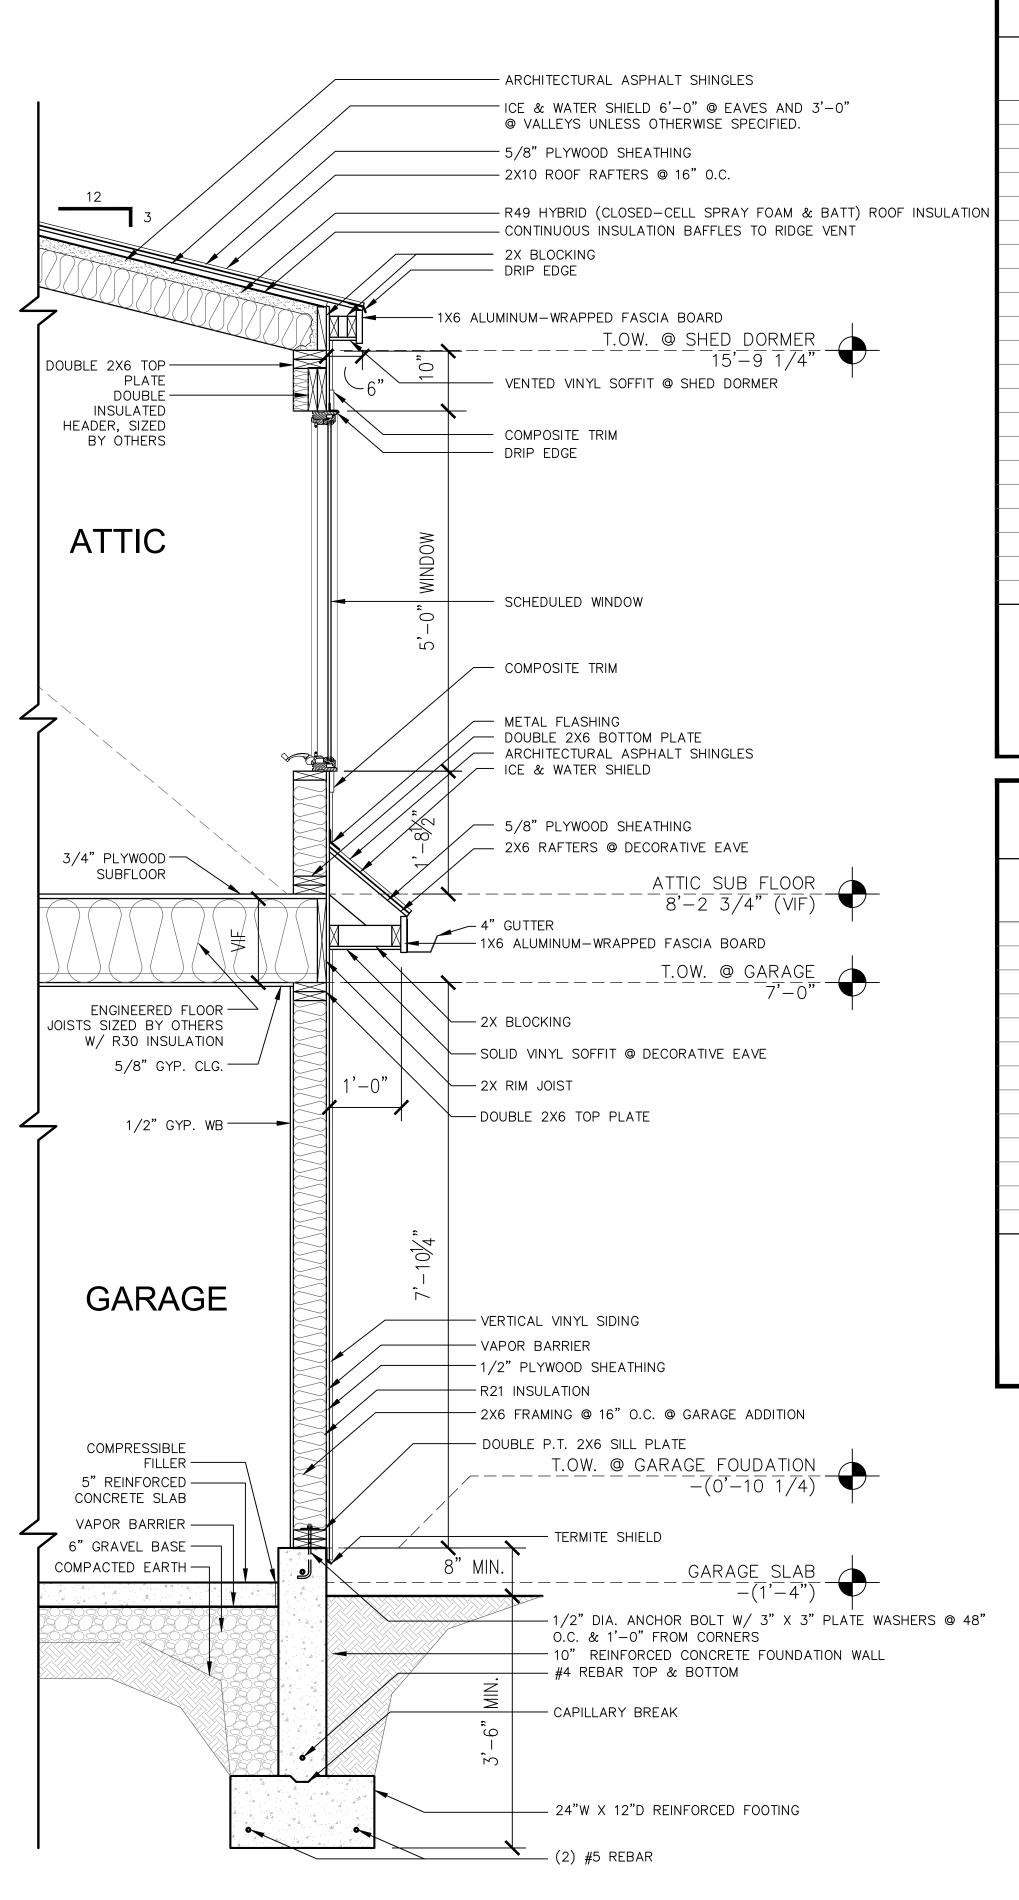

7 TYPICAL WALL SECTION - GARAGE
3/4" = 1'-0"

Kriedel Residence 28 Thompson Street, South Glastonbury, CT 06073 Window Schedule 01 27 22

All Windows to be Andersen 400 Series or approved equal. Contractor is required to coordinate all Call Numbers with Window Manufacturer.

Number	Location	Call Number	Window Sizes	Simonton ProFinish Series Description	Screen(s)	Grille Pattern Note(s)
Window 1	Living Area	CXW15	3'-0" x 5'-0"	Casement Window	Yes	N/A
Window 2	Living Area	CXW15	3'-0" x 5'-0"	Casement Window	Yes	
Window 3	Living Area	CXW15	3'-0" x 5'-0"	Casement Window	Yes	
Window 4	Living Area	CXW15	3'-0" x 5'-0"	Casement Window	Yes	
Window 5	Living Area	CXW15	3'-0" x 5'-0"	Casement Window	Yes	
Window 6	Bedroom #1	CXW15	(2) 3'-0" x 5'-0"	Casement Window Pair	Yes	
Window 7	Bedroom #3	CXW15	(2) 3'-0" x 5'-0"	Casement Window Pair	Yes	
Window 8	DELETED	-	-	-	-	
Window 9	DELETED	-	•	-	-	
Window 10	Bedroom #2	CXW15	3'-0" x 5'-0"	Casement Window	Yes	
Window 11	Bedroom #2	CXW15	3'-0" x 5'-0"	Casement Window	Yes	
Window 12	Bath #2	CW135	2'-4" x 3'-4"	Casement Window	Yes	
Window 13	Bath #1	CW135	2'-4" x 3'-4"	Casement Window	Yes	
Window 14	Kitchen	(2)2'-0" X 3'-8"	(2) 2'-0" x 3'-8"	Casement Window Pair	Yes	
Window 15	Mud Room	CW135	2'-4" x 3'-4"	Casement Window	Yes	
Window 16	Garage	CXW14	3'-0" x 4'-0"	Casement Window		
Window 17	Attic	(2)CW145 +CTCW2	(2)2'-4" x 4'-4"	Casement Window & Specialty	Yes	Casement Window Head Height @ 6'-0" AFF
Window 18	Attic	CXW15	3'-0" x 5'-0"	Casement Window	Yes	
Window 19	Attic	CXW15	3'-0" x 5'-0"	Casement Window	Yes	
Window 20	Attic	CXW15	3'-0" x 5'-0"	Casement Window	Yes	
Window 21	Attic	CXW14	3'-0" x 4'-0"	Casement Window	Yes	

Interior Color: White Exterior Color: White Trim Color: White No Grilles

## ALL EXISTING WINDOWS ARE TO BE REPLACED. CONTRACTOR IS REQUIRED TO FRAME ALL REPLACEMENT WINDOWS AS NEW CONSTRUCTION

Kriedel Residence 28 Thompson Street, South Glastonbury, CT 06073 Door Schedule 01 27 22

All Interior Doors to be Solid Core, unless specified otherwise. Contractor is required to coordinate all Call Numbers with Door Manufacturer

Door Schedule V1 27 22										
						Hardware				
Number	Location	Call Number	Size	Description	Butt Hinge	Handle	Lock	Note(s)		
Door 1	Front Entry	-	3'-0" x 6'-8" + Sidelites	2 Panel Fiberglass Exterior Door	Yes	-	Yes	(2) 12" Sidelites, Entry Hardware & Dead Bolt		
Door 2	Mud Room Entry	-	3'-0" x 6'-8"	2 Panel Fiberglass Exterior Door	Yes	-	Yes	Entry Hardware & Dead Bolt		
Door 3	Kitchen	-	2'-8" x 6'-8"	6 Panel Solid-Core Pocket Door	Pocket	-				
Door 4	Mud Room	-	3'-0" x 6'-8"	Fire-Rated 6 Panel Solid-Core Door	Yes	-	Yes	Key & Dead Bolt		
Door 5	Garage	-	3'-0" x 7'-0"	2 Panel Fiberglass Exterior Door	Yes	-	Yes	Key & Dead Bolt		
Door 6	Garage Stair	-	3'-0" x 7'-0"	Fire-Rated 2 Panel Solid-Core Door	Yes	-				
Door 7	Garage Stair	-	3'-0" x 7'-0"	2 Panel Fiberglass Exterior Door	Yes	-	Yes	Key & Dead Bolt		
Door 8	Garage	-	9'-0" x 8'-0"	Carriage Style Door	N/A	-				
Door 9	Garage	-	9'-0" x 8'-0"	Carriage Style Door	N/A	-				
Door 10	Dining Area	-	6'-0" x 6'-8"	Gliding Patio Door	Yes	-	Privacy			
Door 11	Attic	-	2'-6" x 6'-8"	6 Panel Solid-Core Door	Yes	-				
Door 12	DELETED	-	-	-	-	-				
Door 13	DELETED	-	-	-	-	-				

- Interior Color: White
- Exterior Color: White (Confirm with Home Owner)
- Hardware Finish: Polished Brass (Confirm with Home Owner)

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28 Thompson Street South Glastonbury, CT 060

Drawing Name:

Typ. Wall Section, Window & Door Schedules

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Drawn By: CN / PS

Date: February 17, 2022

Drawing Number:

A3.0