1. THE CONTRACTOR SHALL FURNISH ALL LABOR AND MATERIALS AS REQUIRED TO COMPLETE THE DEMOLITION AND REMOVAL OF ALL ITEMS AS SHOWN OR NOTED ON

THE ARCHITECT'S AND ENGINEER'S DRAWINGS. 2. COORDINATE PROPOSED METHODS AND OPERATIONS WITH PROJECT MANAGER AND BUILDING MANAGEMENT PRIOR TO THE START OF DEMOLITION WORK INCLUDING

COORDINATION FOR SHUT-OFF, CAPPING AND CONTINUATION OF UTILITY SERVICES

- 3. VERIFY AND COORDINATE ALL DIMENSIONS PRIOR TO BEGINNING WORK.
- 4. ALL DEMOLITION TO BE COORDINATED AND PERFORMED BY THE APPROPRIATE TRADE. COORDINATE WORK WITH ALL PLANS, INCLUDING ELECTRICAL, HVAC, PLUMBING AND FIRE PROTECTION.
- 5. UPON COMPLETION OF THE DEMOLITION WORK, THE CONTRACTOR SHALL LEAVE ALL AREAS BROOM CLEAN.
- 6. COORDINATE ACCESS POINTS AND STAGING AREAS WITH OWNER.
- ADJACENT AREAS FROM CONSTRUCTION DUST. 8. PORTIONS OF THE EXISTING BUILDING INCLUDING FINISHES, MECHANICAL AND ELECTRICAL WORK DISTURBED BY DEMOLITION OR NEW CONSTRUCTION SHALL BE

7. PROVIDE TEMPORARY CONSTRUCTION BARRIERS AS REQUIRED TO PROTECT


9. THE CONTRACTOR SHALL COORDINATE ALL TEMPORARY POWER REQUIREMENTS DURING RENOVATIONS. REFER TO ELECTRICAL DRAWINGS.


CONSTRUCTION PLAN NOTES

- A. REMOVE: DETACH ITEMS FROM EXISTING CONSTRUCTION AND LEGALLY DISPOSE OF THEM OFF-SITE, UNLESS INDICATED TO BE REMOVED AND SALVAGED OR REMOVED AND REINSTALLED.
- B. <u>REMOVE AND SALVAGE</u>: DETACH ITEMS FROM EXISTING CONSTRUCTION AND DELIVER THEM TO OWNER READY FOR REUSE.
- C. <u>REMOVE AND REINSTALL</u>: DETACH ITEMS FROM EXISTING CONSTRUCTION, PREPARE THEM FOR REUSE, STORE, OR REINSTALL THEM WHERE INDICATED. D. EXISTING TO REMAIN: EXISTING ITEMS OF CONSTRUCTION THAT ARE NOT TO BE
- REMOVED AND THAT ARE NOT OTHERWISE INDICATED TO BE REMOVED, REMOVED AND SALVAGED, OR REMOVED AND REINSTALLED. 11. CONTRACTOR SHALL CONTACT OWNER OR ARCHITECT TO CONFIRM ANY ITEM NOT

SPECIFICALLY NOTED ON PLAN. IF DISCREPANCY EXISTS; REMOVE AND SALVAGE


- ITEM FOR OWNER. 12. SEE SPEC SECTION "CUTTING & PATCHING" FOR PROTOCOL REQUIREMENTS IF HAZARDOUS MATERIALS SHOULD BE DISCOVERED DURING DEMOLITION.
- 13. PROTECT OR SAVE EXISTING FIRE EXTINGUISHER CABINETS, FIRE PULL STATIONS AND EXIT SIGNS FOR RE-USE AS APPLICABLE FOR TURN OVER TO OWNER. REPAIRED AS REQUIRED AND RETURNED TO ITS ORIGINAL CONDITION OR BETTER,
 - 14. FIREPROOF HOLES LEFT BY DEMOLITION TO MATCH FIRE RESISTANCE RATING OF WALL AND FLOOR.

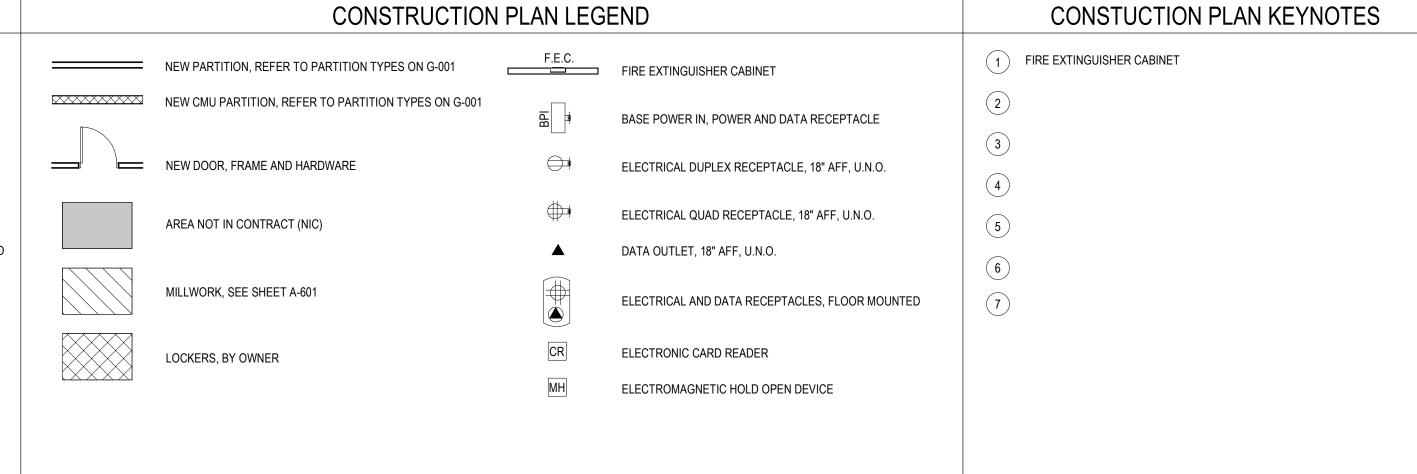

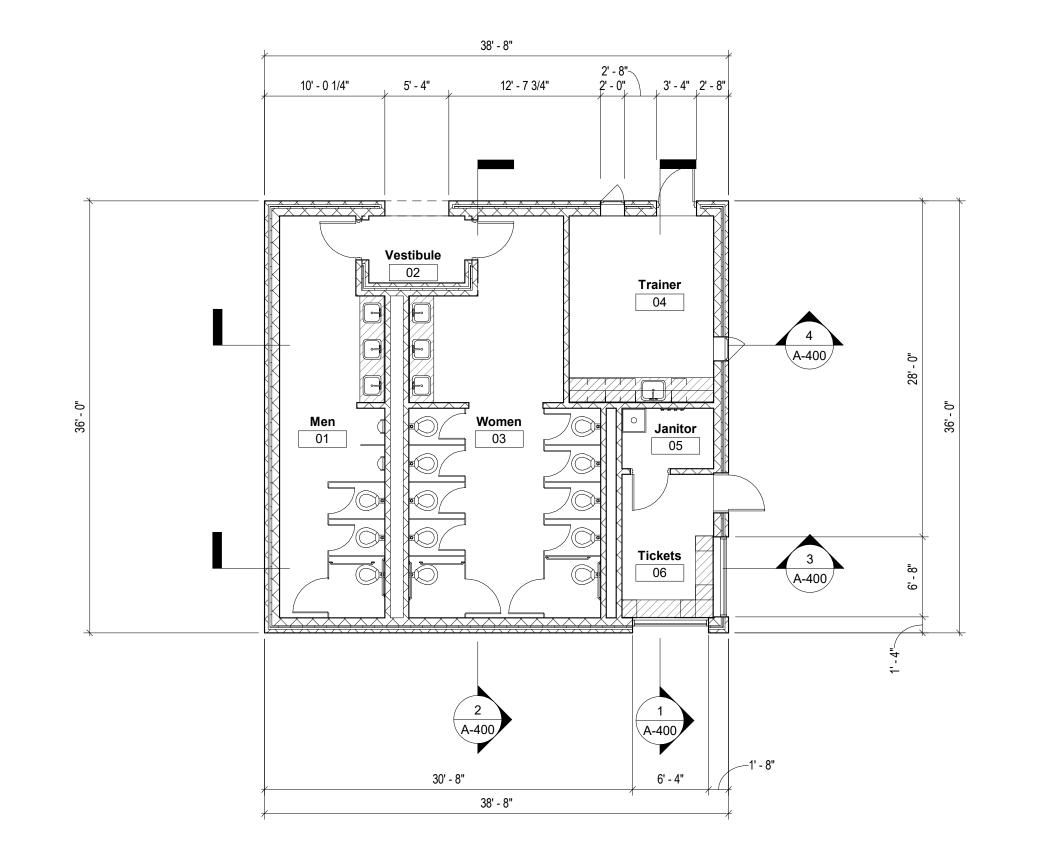

PUBLIC BATHROOM BUILDING - FLOOR PLAN

1/8" = 1'-0"

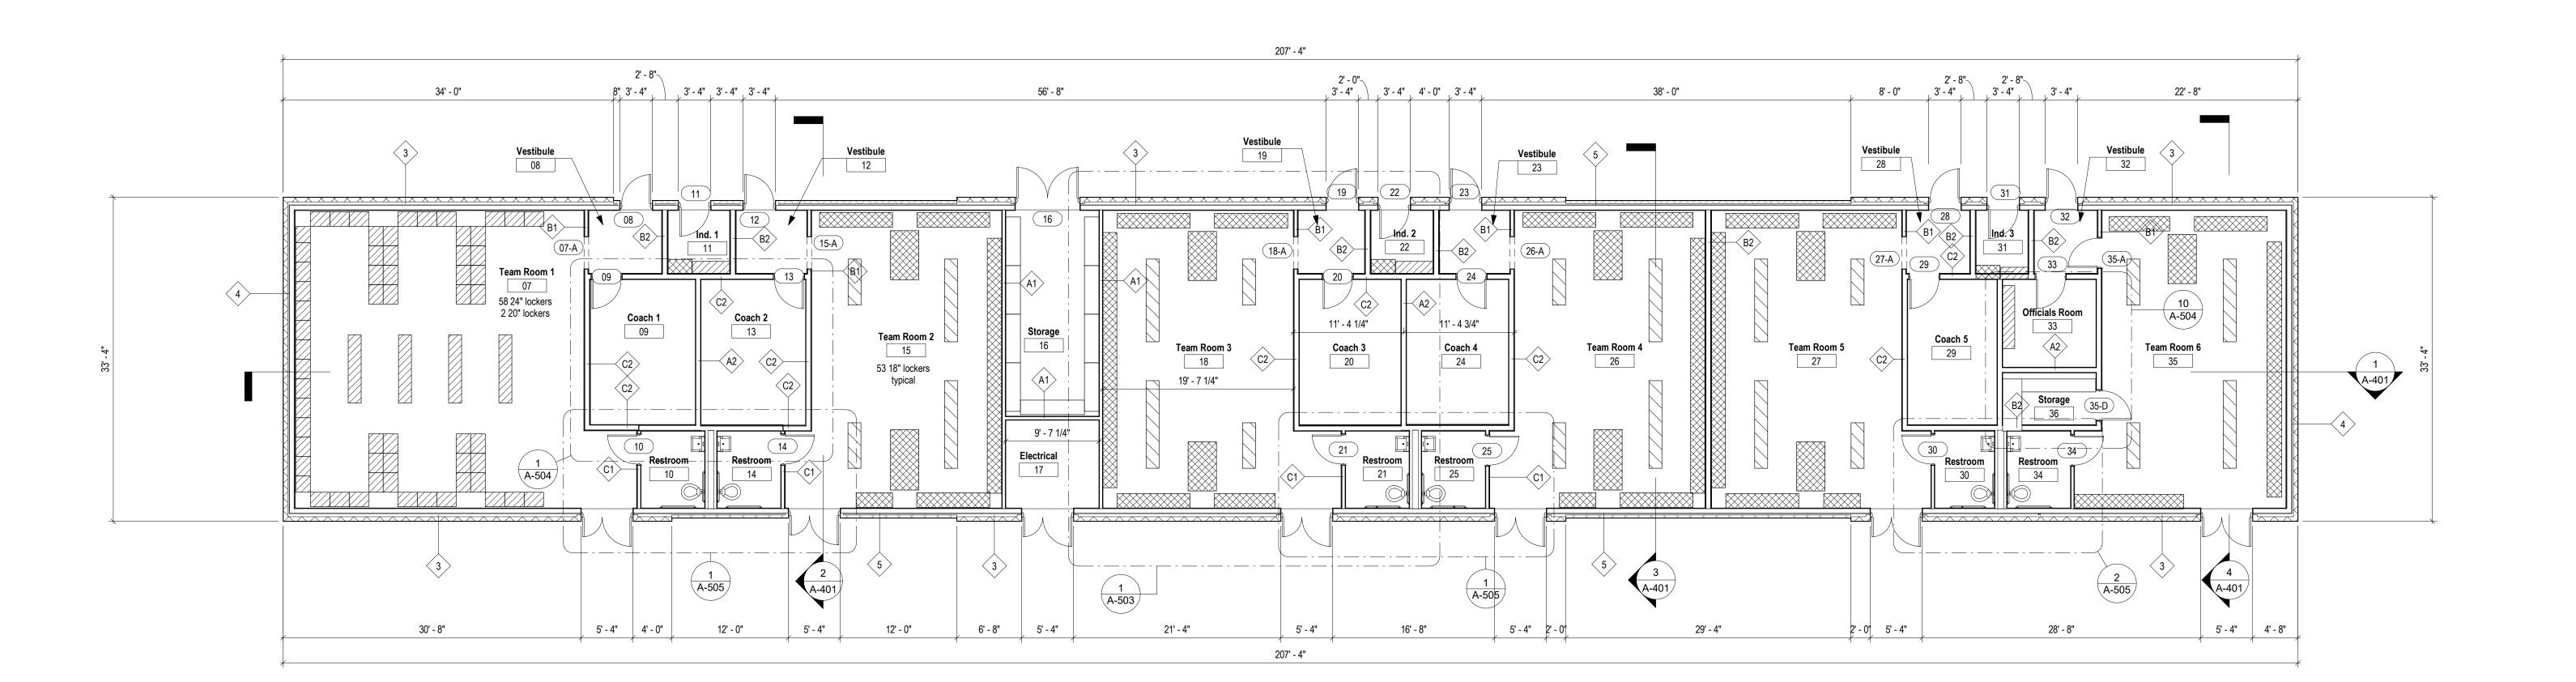

f: 860.657.0757 **Glastonbury High School**

655 Winding Brook Dr. Glastonbury, CT 06033

t: 860.657.2500

Civil Engineer

Athletics Building 75% Construction Documents

> 330 Hubbard Street Glastonbury, CT 06033 GL-2021-05 Project Team

300 Winding Brook Drive Glastonbury, CT 06033 860-652-8227

> MEP Engineer BEMIS | ASSOCIATES, LLC Consulting Engineers

Structural Engineer Morrissey Engineering, LLC 58 Essex Street, Deep River, CT06417 phone 860-532-0312

Revisions

Issue Record 75% Construction Documents 8/5/20

progress print NOT FOR CONSTRUCTION 11/2/2020 5:32:38 PM

Drawing Information 07/22/02 Job Number GL-2021-051/8" = 1'-0" Author Drawn Drawing Name

FIRST FLOOR PLANS

Drawing Number

A-101

1 LOCKER ROOM BUILDING - FLOOR PLAN

1/8" = 1'-0"

Copyright © 2018 id3A



655 Winding Brook Dr. Glastonbury, CT 06033 t: 860.657.2500 f: 860.657.0757

Glastonbury High School Athletics Building

Bid Documents

330 Hubbard Street
Glastonbury, CT 06033

GL-2021-05

Project Team

Civil Engineer

BSC GROU
300 Winding Brook Drive
Glastonbury, CT 06033
860-652-8227

MEP Engineer

BEMIS | ASSOCIATES, LLC

Consulting Engineers

Farmington, Ct 06032 (860) 667-3233 Fax: (860) 321-7070 www.bemisassociates.com





Issue Record
75% Construction Documents 8/5/20

progress print
NOT FOR CONSTRUCTION

11/3/2020 12:19:09 PM


Drawing Information
09/28/18

	Drawing Information
Date	09/28/18
Job Number	GL-2021-05
Scale	1/8" = 1'-0"
Drawn	Author
Checked	Checker
	Drawing Name

EXTERIOR ELEVATIONS

Drawing Number

A-300

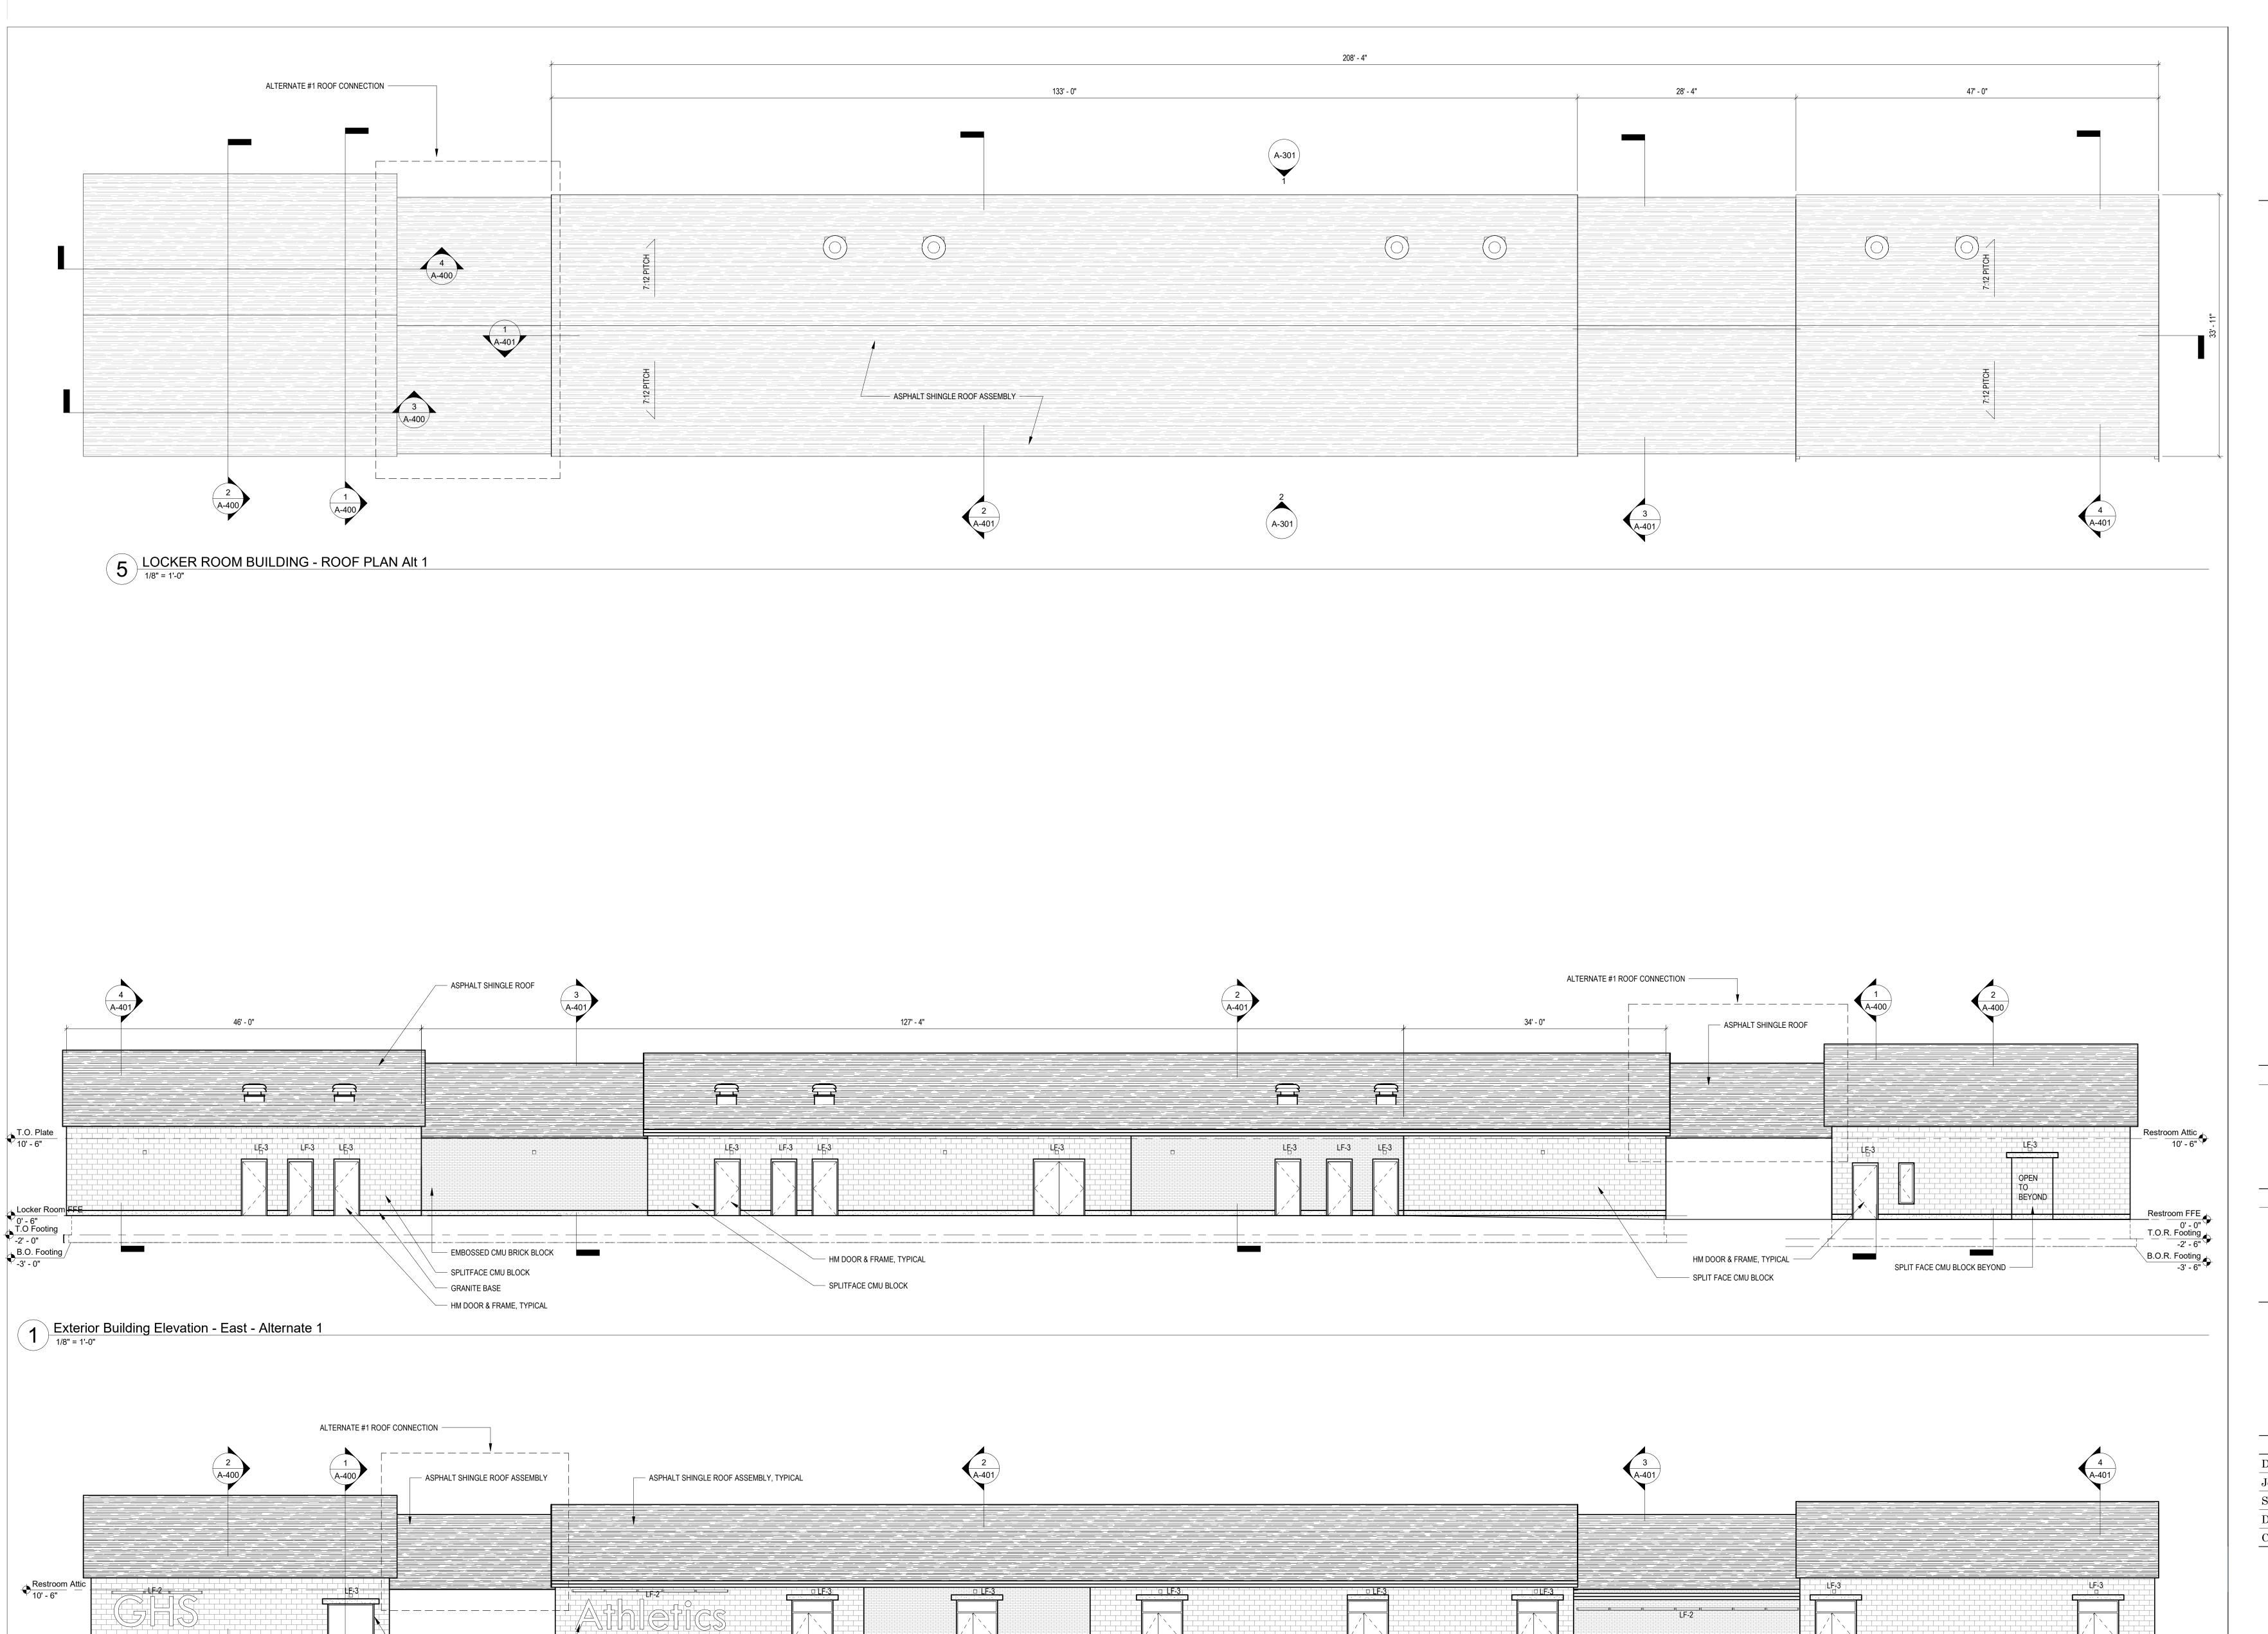

EMBOSSED BRICK BLOCK

- SPLIT FACE CMU BLOCK -

- HM DOOR & FRAME, TYPICAL

Restroom FFE
0' - 0"
T.O.R. Footing
-2' - 6"

B.O.R. Footing / -3' - 6"

SPLIT FACE CMU BLOCK

2 Exterior Building Elevation - West - Alternate 1

1/8" = 1'-0"

ALUMINUM STOREFRONT

BOOTH

- METAL PANEL

SECURITY WINDOW FOR TICKET

3D PIN MOUNTED LETTERS BY OWNER, TYP. AT ALL SIGNAGE



655 Winding Brook Dr. Glastonbury, CT 06033 t: 860.657.2500 f: 860.657.0757

Glastonbury High School Athletics Building

Bid Documents

330 Hubbard Street
Glastonbury, CT 06033

GL-2021-05

Project Team

Civil Engineer

300 Winding Brook Drive Glastonbury, CT 06033 860-652-8227

MEP Engineer

BEMIS | ASSOCIATES, LLC

Consulting Engineers

(860) 667–3233
Fax: (860) 321–7070
www.bemisassociates.com

Structural Engineer

Morrissey Engineering, LLC
58 Essex Street, Deep River, CT06417
phone 860-532-0312

Revision

Issue Record
75% Construction Documents 8/5/20

\$

progress print NOT FOR CONSTRUCTION 11/3/2020 12:15:21 PM

	Drawing Information
Date	11/02/20
Job Number	GL-2021-05
Scale	1/8" = 1'-0"
Drawn	Author
Checked	Checker
	Drawing Name

ALTERNATE #1 ROOF CONNECTOR

Drawing Number

A-301

Use the Room FFE O' - 6"
T.O Footing B.O. Footing B.O. Footing -3' - 0"

- EMBOSSED BRICK BLOCK

SPLIT FACE CMU BLOCK —