# TOWN OF GLASTONBURY HEBRON AVENUE PAVEMENT REHABILITATION LOTCIP #L053-0001

located between

# MAIN STREET & SYCAMORE STREET GLASTONBURY, CONNECTICUT

PW-1308

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C		

ALL UTILITY INFORMATION AND DATA SHOWN O

INDICATED IN THE CONTRACT DOCUMENTS ARE COMPLIED FROM MAPS AND DATA FURNISHED BY

THERS, ANY SUCH INFORMATION SHOULD NOT

BE CONSTRUED AS ACCURATE OR COMPLETE

AND THE CONTRACTOR SHALL VERIFY ALL

LOCATIONS PRIOR TO CONSTRUCTION.

LOCATION MAP SCALE: 1"=1000'

NOVEMBER 2017

100% CONSTRUCTION SUBMISSION

RICHARD J. JOHNSON **TOWN MANAGER** 

DANIEL A. PENNINGTON MANAGER OF PHYSICAL SERVICES/TOWN ENGINEER

## **GENERAL PROJECT NOTES:**

THESE PLANS HAVE BEEN PREPARED BY THE TOWN OF GLASTONBURY ENGINEERING DIVISION.

ALL WORK UNDER THIS CONTRACT IS TO BE COVERED BY AND IN CONFORMITY WITH THE STATE OF CONNECTICUT DEPARTMENT OF TRANSPORTATION STANDARD SPECIFICATIONS FOR ROADS, BRIDGES, FACILITIES AND INCIDENTAL CONSTRUCTION, FORM 817, 2016 INCLUDING SUPPLEMENT DATED JANUARY 2017 GOVERN.

ALL COORDINATES ON THIS PROJECT ARE BASED ON NAD 83 HORIZONTAL DATUM.

ALL ELEVATIONS ON THIS PROJECT ARE BASED ON NAVD 88 VERTICAL DATUM.

DESIGN CLASSIFICATION FOR HEBRON AVENUE: ARTERIAL

DESIGN SPEED FOR HEBRON AVENUE: 35 MPH


FOR CONSTRUCTION DETAILS AND NOTES NOT FOUND WITHIN THIS SET OF DOCUMENTS FOR THIS PROJECT, THE CONTRACTOR SHALL UTILIZE THE CONSTRUCTION DETAILS AND NOTES INCLUDED WITHIN STATE PROJECT 0053-0193 HEBRON AVENUE ROUNDABOUT: HOUSE STREET.

TOPOGRAPHY DEPICTED ON THESE PLANS WAS DERIVED FROM VARIOUS FIELD SURVEYS, THE LAST WAS PERFORMED IN FALL OF 2016 BY THE TOWN OF GLASTONBURY ENGINEERING DEPARTMENT.


**DESIGNED BY: GLASTONBURY** ENGINEERING DIVISION PER: DANIEL A. PENNINGTON, P.E. CONN. P.E. REGISTRATION: 20101 DATE: DECEMBER 15, 2017

SHEET NO. 1 - 16

DRAWING ISSUE STATUS 100% CONSTRUCTION SUBMISSION 9/12/2017 100% DESIGN SUBMISSION 3/2/2017 FINAL DESIGN SUBMISSION DATE PW-1308 **DESCRIPTION** 

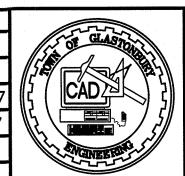

SCALE: AS SHOWN RAWN BY: C.F.S. CHECKED BY: S.M.B. 9/2016 APPROVED BY: D.A.P. DO NOT SCALE THIS DRAWING. USE THE DIMENSIONS GIVEN. IF THERE ARE ANY DISCREPANCIES OR QUESTIONS, CONTACT THE TOWN OF GLASTONBURY, ENGINEERING OFFICE.

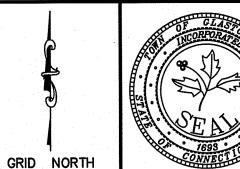



TITLE SHEET PAVEMENT REHABILITATION HEBRON AVENUE MAIN STREET & SYCAMORE STREET

GLASTONBURY, CONNECTICUT

SHEET NO OF <u>17</u>


MANUAL REVISIONS TO THIS DOCUMENT ARE PROHIBITED.


ALL REVISIONS MUST BE PERFORMED ON CADD FILE: H:\DWG\Streets\Hebron Ave\PW-1308 Hebron Ave-Rehab\Hebron Ave-Rehab-CFS-12-2017.dwg


Line	ITEM		ITEM		EST
No.	NUMBER		DESCRIPTION	UNIT	QTY
	0201001	A	Clearing and Grubbing	LS	1
	0202000	A	Earth Excavation	CY	2,587
	0202451	A	Test Pit Excavation	CY	23
	0202529		Cut Bituminous Concrete Pavement	LF	649
	0209001		Formation of Subgrade	SY	4,436
	0212000	Α	Subbase	CY	1,294
	0219011	Α	Sedimentation Control Sack	EA	14
	0303051	Α	Brick Pavers on 8" Concrete Base Slab	SF	845
	0303061	Α	8" Reinforced Concrete Base for Pavers	SF	845
	0404101	Α	Bituminous Concrete Patching - Partial Depth	SY	30
	0406159		PMA S0.5	TN	814
	0406170		HMA S1.0	TN	1,339
	0406171		HMA S0.50	TN	536
	0406173		HMA S0.25	TN	139
	0406236		Material for Tackcoat	Gal	1,088
	0406275	Α	Fine Milling of Bituminous Concrete (0 to 4 Inches)	SY	2,302
	0406999		Asphalt Adjustment Cost	EST	1
		Remove Existing Catch Basin	EA	2	
	0507007	Α	Replace Catch Basin Top	EA	9
	0507012	Α	Type "C" Catch Basin Over Existing Pipe	EA	1
	0507120	Α	Type "C" Catch Basin w/ 3' Sump	EA	1
	0507238	Α	Special Round Type "C-L" Catch Basin	EA	1
	0507781	A	Reset Manhole	EA	5
	0507791	A	Rebuild Catch Basin	VF	8
	0651052	A	15" RC Pipe (Class V)	LF	22
	0811016	A	Precast Concrete Park Curbing	LF	117
	0813012	A	5" x 17" Granite Stone Curbing	LF	1,589
	0813013	A	5" x 17" Granite Curved Stone Curbing	LF	599
	0813015		5" X 14" Granite Stone Curbing	LF	141
	0816019	A	5" X 20" Granite Stone Curbing-Mountable	LF	20
	0816020	A	5" X 20" Granite Curved Stone Curbing-Mountable	LF	6
	0815001		Bituminous Concrete Lip Curbing	LF	252
	0905011	A	Remove and Reset PVC Fence	LF	20
	0908001		Construction Staking	LS	1
	0921001	A	Concrete Sidewalk	SF	3,738
	0921002		Concrete Sidewalk - 8" Thick	SF	1,050
	0921005	A	Concrete Sidewalk - 6 Thick  Concrete Sidewalk Ramp	EA	1,030
	0921003		Bituminous Concrete Sidewalk	SY	290
	0922500	A	Bituminous Concrete Sidewark  Bituminous Concrete Driveway (Commercial)	SY	388

Line	ITEM		ITEM		EST
No.	NUMBER		DESCRIPTION	UNIT	QTY
	0000000			0.5	5.00
	0922999	<u> </u>	Inlaid Thermoplastic Pavement Marking System	SF	5,33
	0944000	A	Furnishing and Placing Topsoil	SY	790
	0950005	A	Turf Establishment	SY	79
	097006A	Α	Trafficperson Municipal Officer	EST	
	097007A	Α	Trafficperson (Uniformed Flagger)	HR	24
	0971001	Α	Maintenance and Protection of Traffic	LS	
	0975002		Mobilization	LS	
	0976002		Barricade Warning Lights - High Intensity	Day	2,70
	0978002		Traffic Drum	EA	2
	0979003		Construction Barricade Type III	EA	1
	0981100		42" Traffic Cone	EA	8
	1001001		Trenching and Backfilling	LF	6
	1002203		Traffic Control Foundation-Pedestal-Type I	EA	
	1008115		2" Rigid Metal Conduit in Trench	LF	6
	1008780	Α	4" PVC Duct Bank	LF	20
	1008908	Α	Clean Existing Conduit	LF	35
	1010021		Concrete Handhole-Type II	EA	
	1010060	Α	Clean Existing Concrete Handhole	EA	
	1107007	Α	Pedestrian Push Button and Sign (Piezo)	EA	
	1111201	Α	Temporary Detection (Site No. 1)	LS	
	1111401	A	Loop Vehicle Detector	EA	
	1111451	A	Loop Detector Sawcut	LF	24
	1113103		7 Conductor No. 14 Cable	LF	47
	1118012	A	Removal and/or Relocation of Traffic Signal Equipment	LS	
	1206023	A	Removal and Relocation of Existing Signs	LS	
	1208932		Sign Face-Sheet Aluminum Type IV Reflective Sheeting	SF	(
	1209005		Painted Pavement Markings 4" White	LF	1,00
	1209007		Painted Pavement Markings 4" Yellow	LF	1,50
	1209050		Painted Pavement Markings (General)	SF	80
	1210101		4" White Epoxy Resin Pavement Markings	LF	3,08
	1210101		4" Yellow Epoxy Resin Pavement Markings	LF	3,0
	1210102		Epoxy Resin Pavement Marking Sym. & Legends	SF	86
	1220013		Construction Signs Bright Flourescent Sheeting	SF	43
	+	^			
	1131001	A	Changeable Message Sign	DAY	22
	1302060	A	Adjust Gate Box (Mater)	EA	
	1302061	A	Adjust Gate Box (Water)	EA	
	1403501	A	Reset Manhole (Sanitary Sewer)	EA	
	1500209		Reset Manhole (Electric)	<u>EA</u>	

[	DRAWING ISSUE STATUS					
I						
	3.	100% CONSTRUCTION SUBMISSION	11/30/2017	((<		
I	2.	100% DESIGN SUBMISSION	9/12/2017	1/2		
	1.	FINAL DESIGN SUBMISSION	3/2/2017	"		
	NO.	DESCRIPTION	DATE			

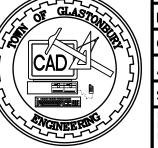

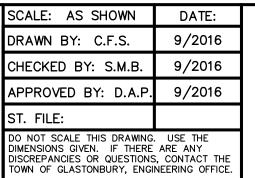


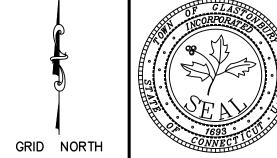



FOR
HEBRON AVENUE
LOCATED BETWEEN
MAIN STREET & SYCAMORE STREET
GLASTONBURY, CONNECTICUT


OF <u>17</u>

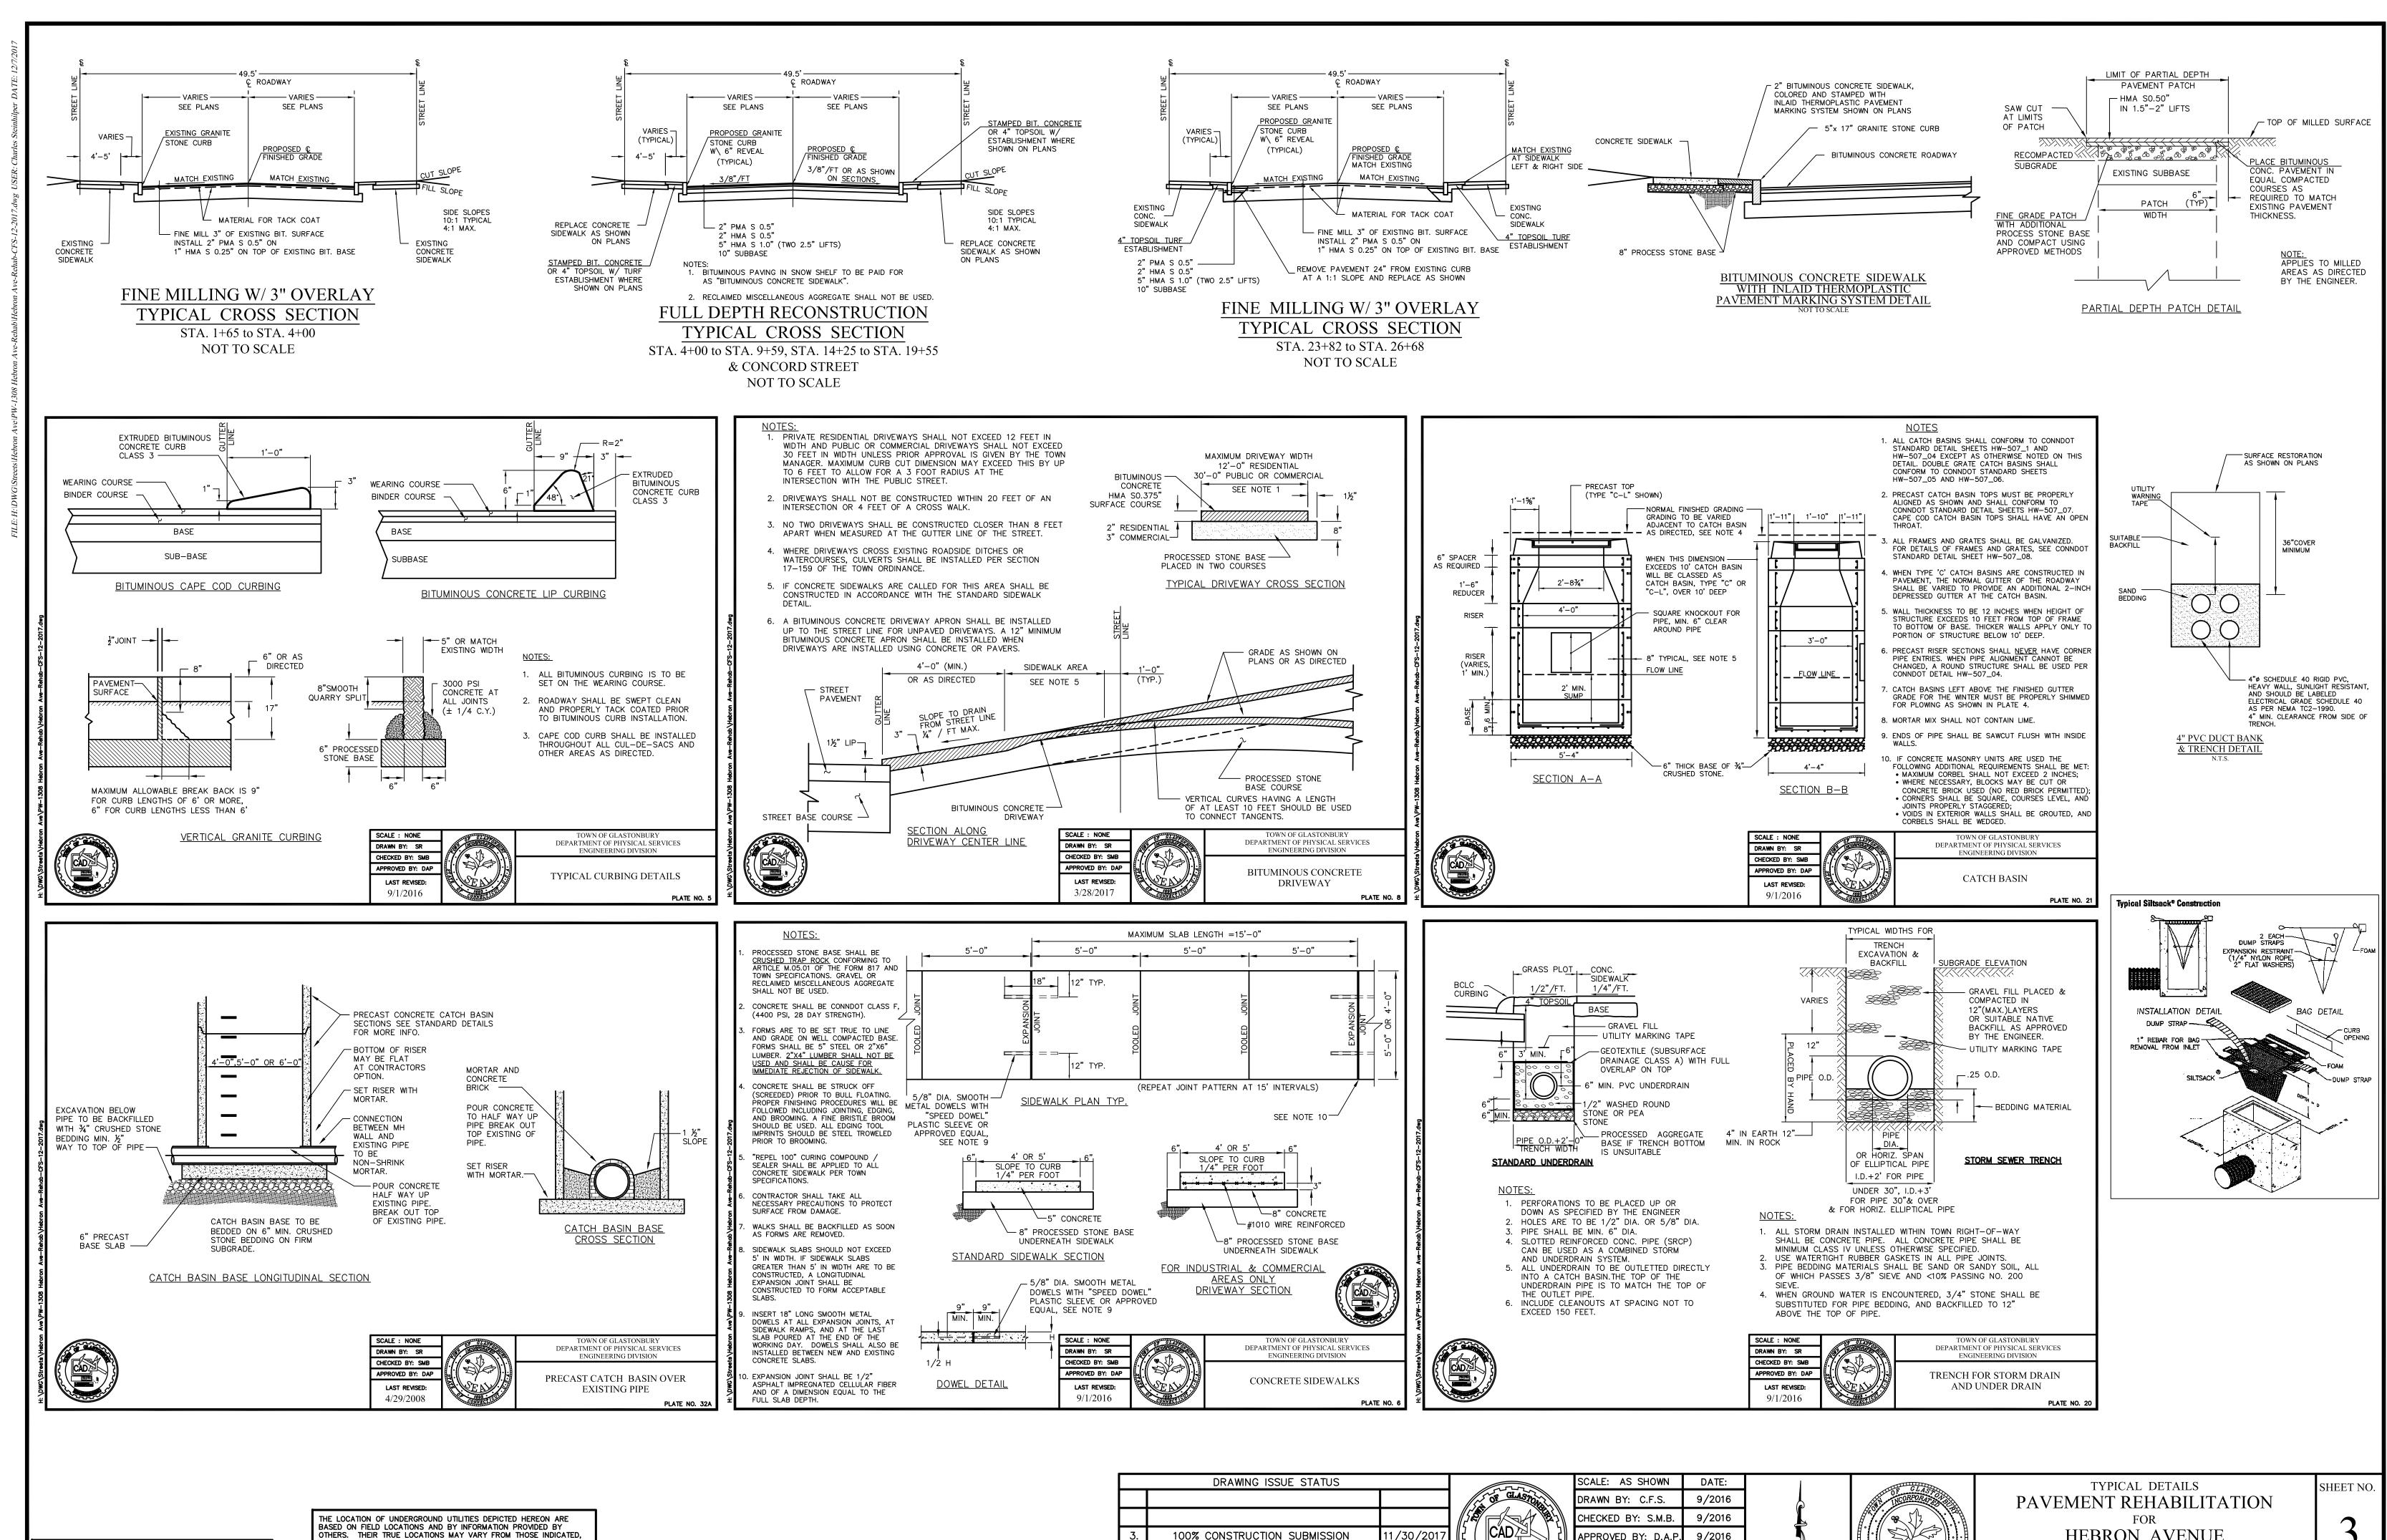


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AND ALL UNDERGROUND UTILITIES MAY NOT BE SHOWN. IF APPLICABLE UTILIZE THE "CALL BEFORE YOU DIG" NUMBER (1-800-922-4455). TO VERIFY THE LOCATION OF ALL UNDERGROUND UTILITIES, AND RESÓLVE CONFLICTS PRIOR TO STARTING CONSTRUCTION, REPAIR OR DESIGN.


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				//5/£		
	3.	100% CONSTRUCTION SUBMISSION	11/30/2017			
	2.	100% DESIGN SUBMISSION	9/12/2017	1/2		
	1.	FINAL DESIGN SUBMISSION	3/2/2017			
PW-1308	NO.	DESCRIPTION	DATE			

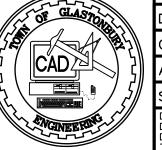


SCALE: AS SHOWN	DATE:				
DRAWN BY: C.F.S.	9/2016				
CHECKED BY: S.M.B.	9/2016				
APPROVED BY: D.A.P.	9/2016				
ST. FILE:					
DO NOT SCALE THIS DRAWING. USE THE DIMENSIONS GIVEN. IF THERE ARE ANY DISCREPANCIES OR QUESTIONS, CONTACT THE TOWN OF GLASTONBURY, ENGINEERING OFFICE.					

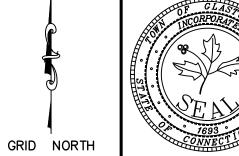


HEBRON AVENUE LOCATED BETWEEN MAIN STREET & SYCAMORE STREET GLASTONBURY, CONNECTICUT OF <u>17</u>

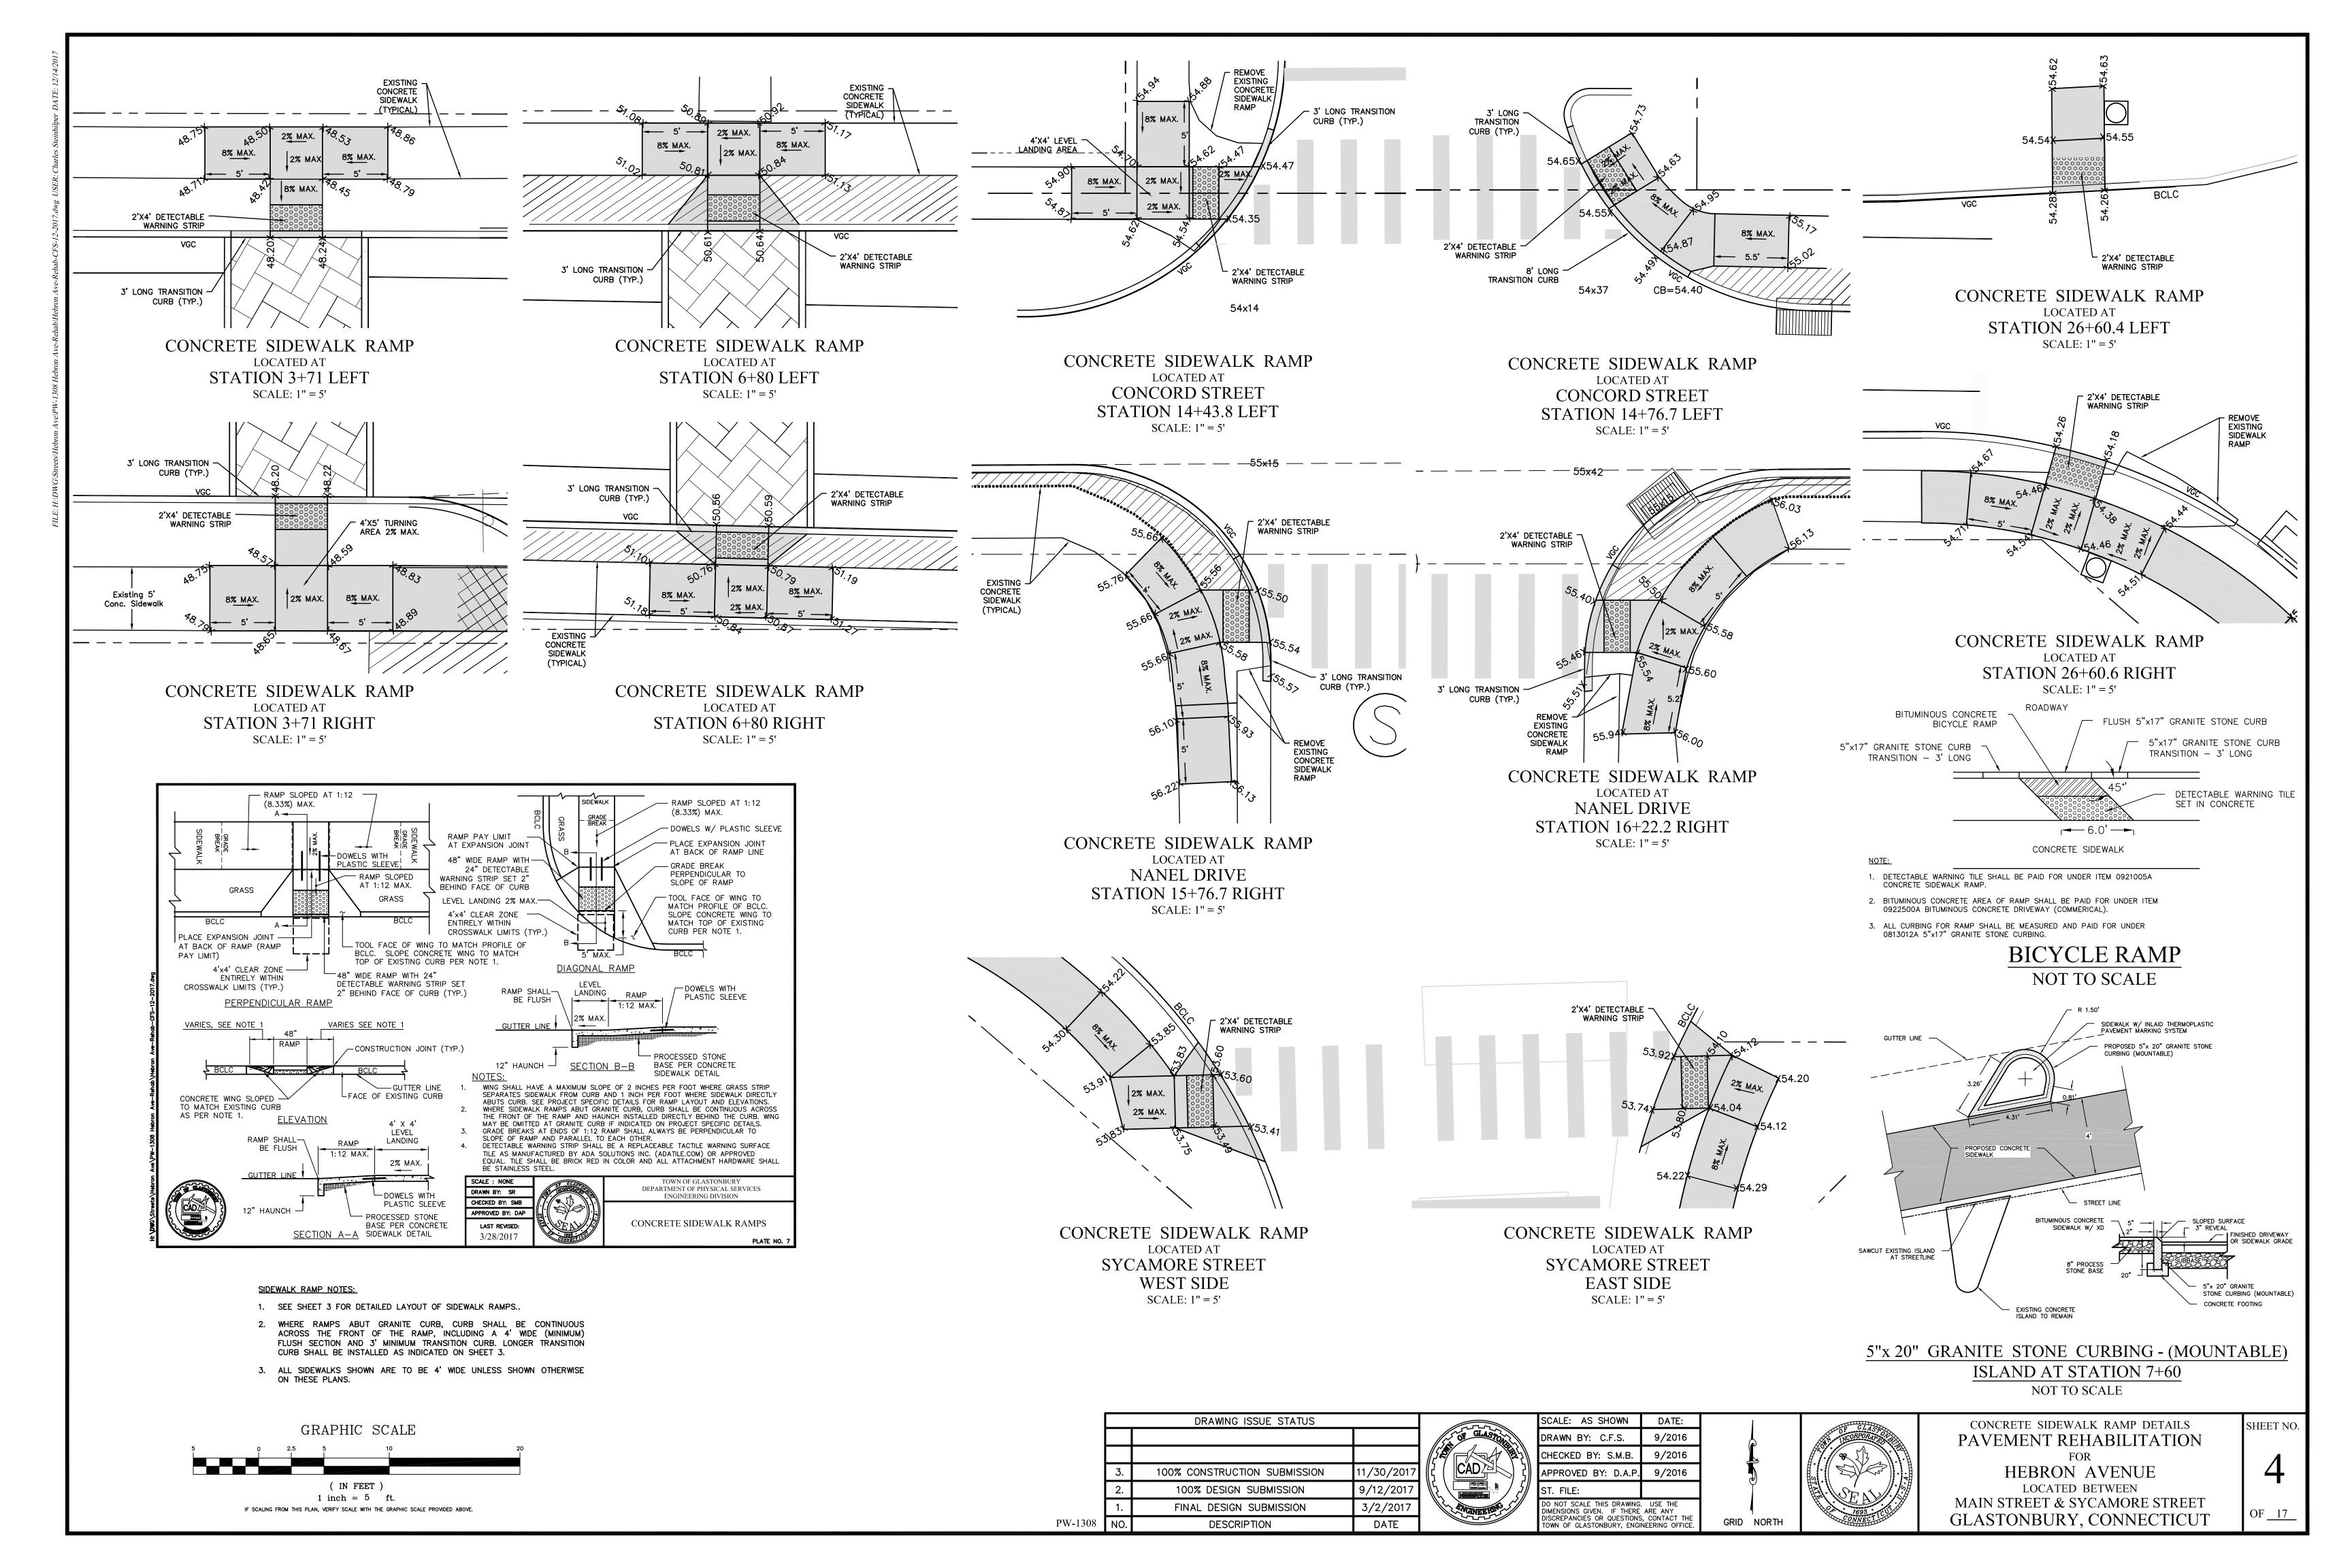

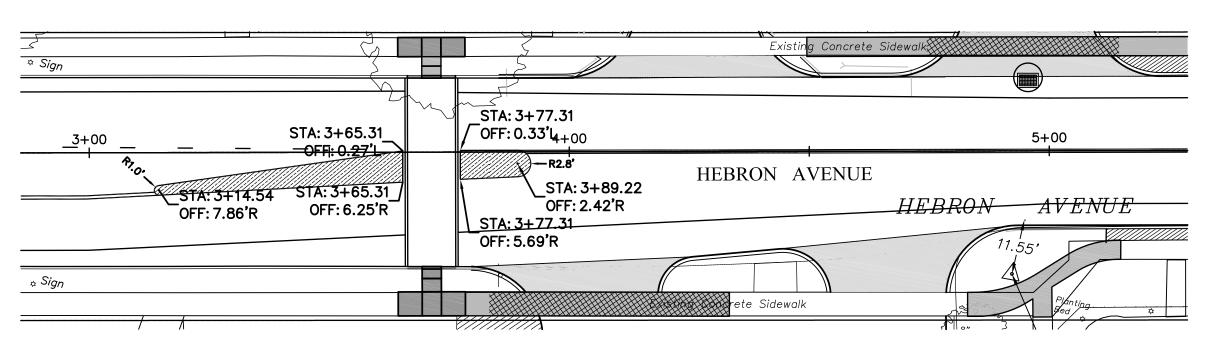



## INLAID THERMOPLASTIC PAVEMENT MARKING SYSTEM STAMPED/COLORED BIT. PAVEMENT LOCATED AT


STATION 3+14 TO STATION 3+92 SCALE: 1'' = 20'

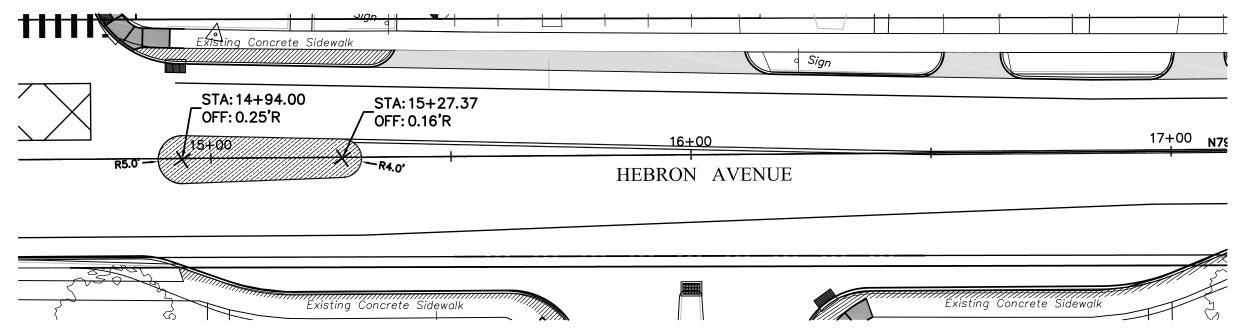

## INLAID THERMOPLASTIC PAVEMENT MARKING SYSTEM STAMPED/COLORED BIT. PAVEMENT LOCATED AT STATION 14+90 TO STATION 15+31 SCALE: 1'' = 20'

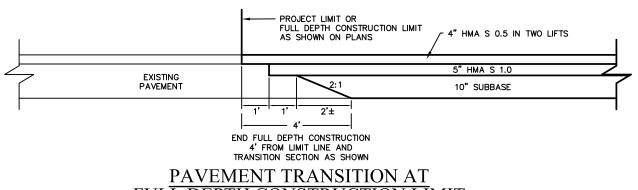

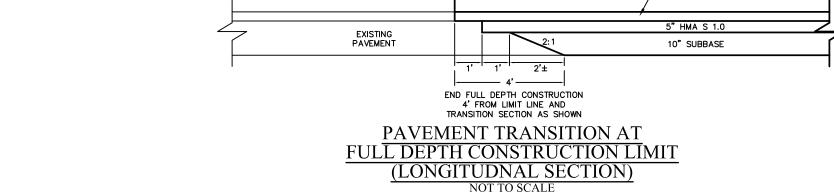

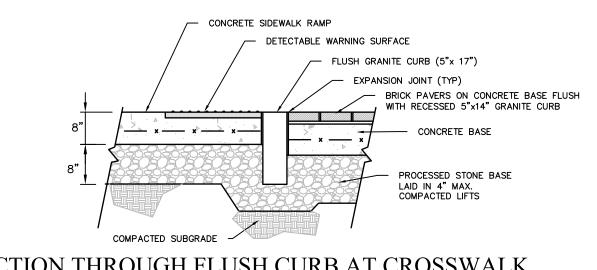



## SECTION THROUGH FLUSH CURB AT CROSSWALK AND PEDESTRIAN RAMP


NOT TO SCALE PROVIDE 2"Ø VERTICAL WEEPHOLES, 24" O.C. AT LOW POINTS, FILL WEEPHOLES WITH {\* TO 1} STONE, COVER EACH WEEPHOLE WITH 6"x6" HIGH POROSITY WOVEN FILTER 34" BITUMINOUS CONCRETE SETTING BED WITH NEOPRENE ADHESIVE FABRIC (SAMPLE TO BE APPROVED BY ENGINEER) CLAY BRICKS (HERRINGBONE PATTERN)  $\underline{\sharp}^n$  expansion joint, see "Doweled transverse expansion joint in SLAB", this sheet POLYMERIC SAND JOINTS 6X6 #10 GAGE WWM ASTM A-185-02 8" PROCESSED STONE BASE

> COMPACTED SUBGRADE NOTE:
>
> 1. SAW CUT BRICKS TO MATCH FLUSH AGAINST FIXED OBJECTS, CONCRETE PAVEMENT, EXPOSED UTILITY STRUCTURES AND OTHER SURFACE FEATURES AND INSTALL EXPANSION JOINT AS SHOWN IN DETAIL. INSTALL EXPANSION JOINT AS SHOWN IN DETAIL.
>
> 2. THE CONTRACTOR SHALL ADHERE TO TYPICAL/MAXIMUM GRADES INDICATED, EXCEPT WHERE NOTED OTHERWISE AND AS DIRECTED BY ENGINEER.
>
> 3. FOR BRICK PAVEMENT LIMITS SEE CONSTRUCTION PLAN SHEETS.
>
> 4. DETAILED INFORMATION REGARDING THE COLOR AND MATERIAL TYPE OF THE BRICK PAVERS CAN BE FOUND IN THE SPECIFICATION, DETAILED INFORMATION REGARDING THE PAVING PATTERN CAN BE FOUND ON THE DETAIL SHEETS.
>
> 5. EXPANSION JOINTS 12"± O.C. MAXIMUM.


BRICK PAVERS ON CONCRETE BASE NOT TO SCALE

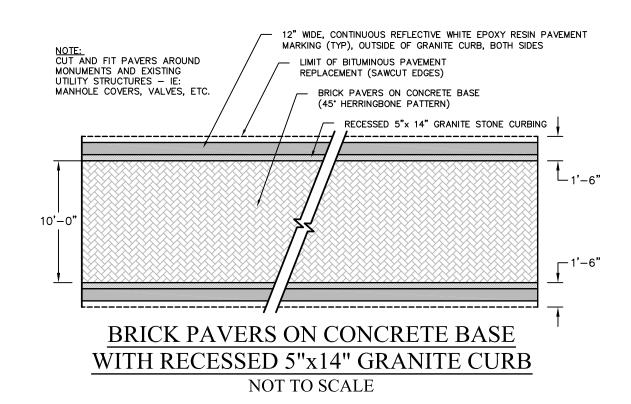

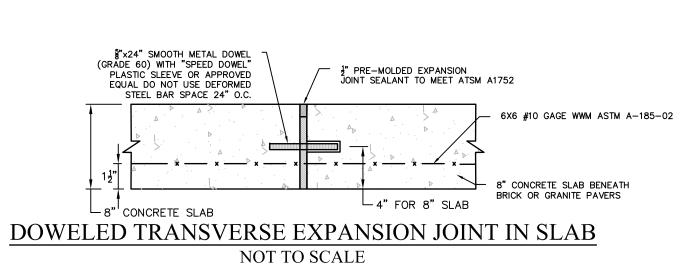

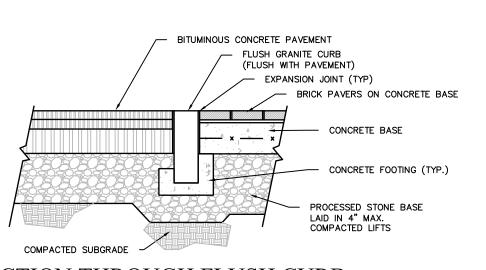

SECTION THROUGH FLUSH CURB AT CROSSWALK IN TRAVELWAY NOT TO SCALE

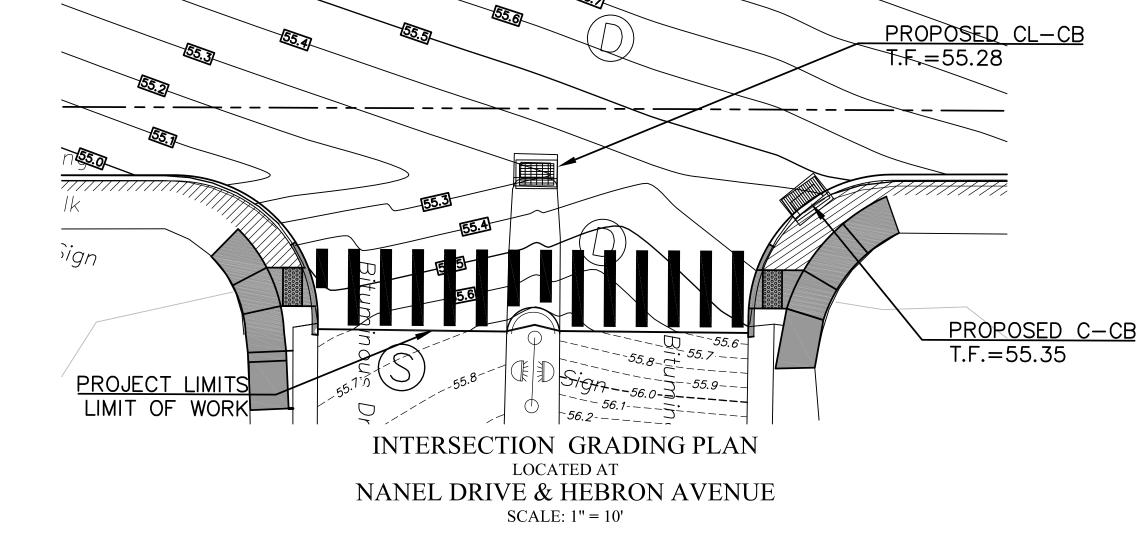


INTERSECTION GRADING PLAN


LOCATED AT

CONCORD STREET & HEBRON AVENUE

SCALE: 1'' = 10'


DRAWING ISSUE STATUS				
3.	100% CONSTRUCTION SUBMISSION	11/30/2017	((i	
2.	100% DESIGN SUBMISSION	9/12/2017	$\ $	
1.	FINAL DESIGN SUBMISSION	3/2/2017		
NO.	DESCRIPTION	DATE		

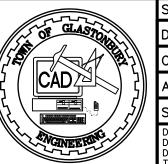

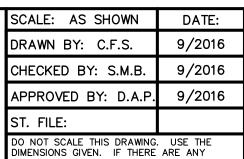

PROJECT LIMITS \

LIMIT OF WORK

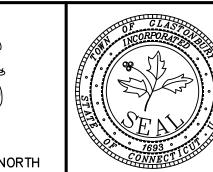

MISCELLANEOUS DETAILS PAVEMENT REHABILITATION

PROPOSED C-CB

Existing Concrete Sidewall

AVENUE

T.F. = 54.40


HEBRON AVENUE LOCATED BETWEEN MAIN STREET & SYCAMORE STREET GLASTONBURY, CONNECTICUT


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THE LOCATION OF UNDERGROUND UTILITIES DEPICTED HEREON ARE BASED ON FIELD LOCATIONS AND BY INFORMATION PROVIDED BY OTHERS. THEIR TRUE LOCATIONS MAY VARY FROM THOSE INDICATED, AND ALL UNDERGROUND UTILITIES MAY NOT BE SHOWN. IF APPLICABLE UTILIZE THE "CALL BEFORE YOU DIG" NUMBER (1-800-922-4455). TO VERIFY THE LOCATION OF ALL UNDERGROUND UTILITIES. AND RESOLVE CONFLICTS PRIOR TO STARTING CONSTRUCTION, REPAIR OR DESIGN.

PW-1308

DISCREPANCIES OR QUESTIONS, CONTACT THE OWN OF GLASTONBURY, ENGINEERING OFFICE. GRID NORTH SHEET NO.



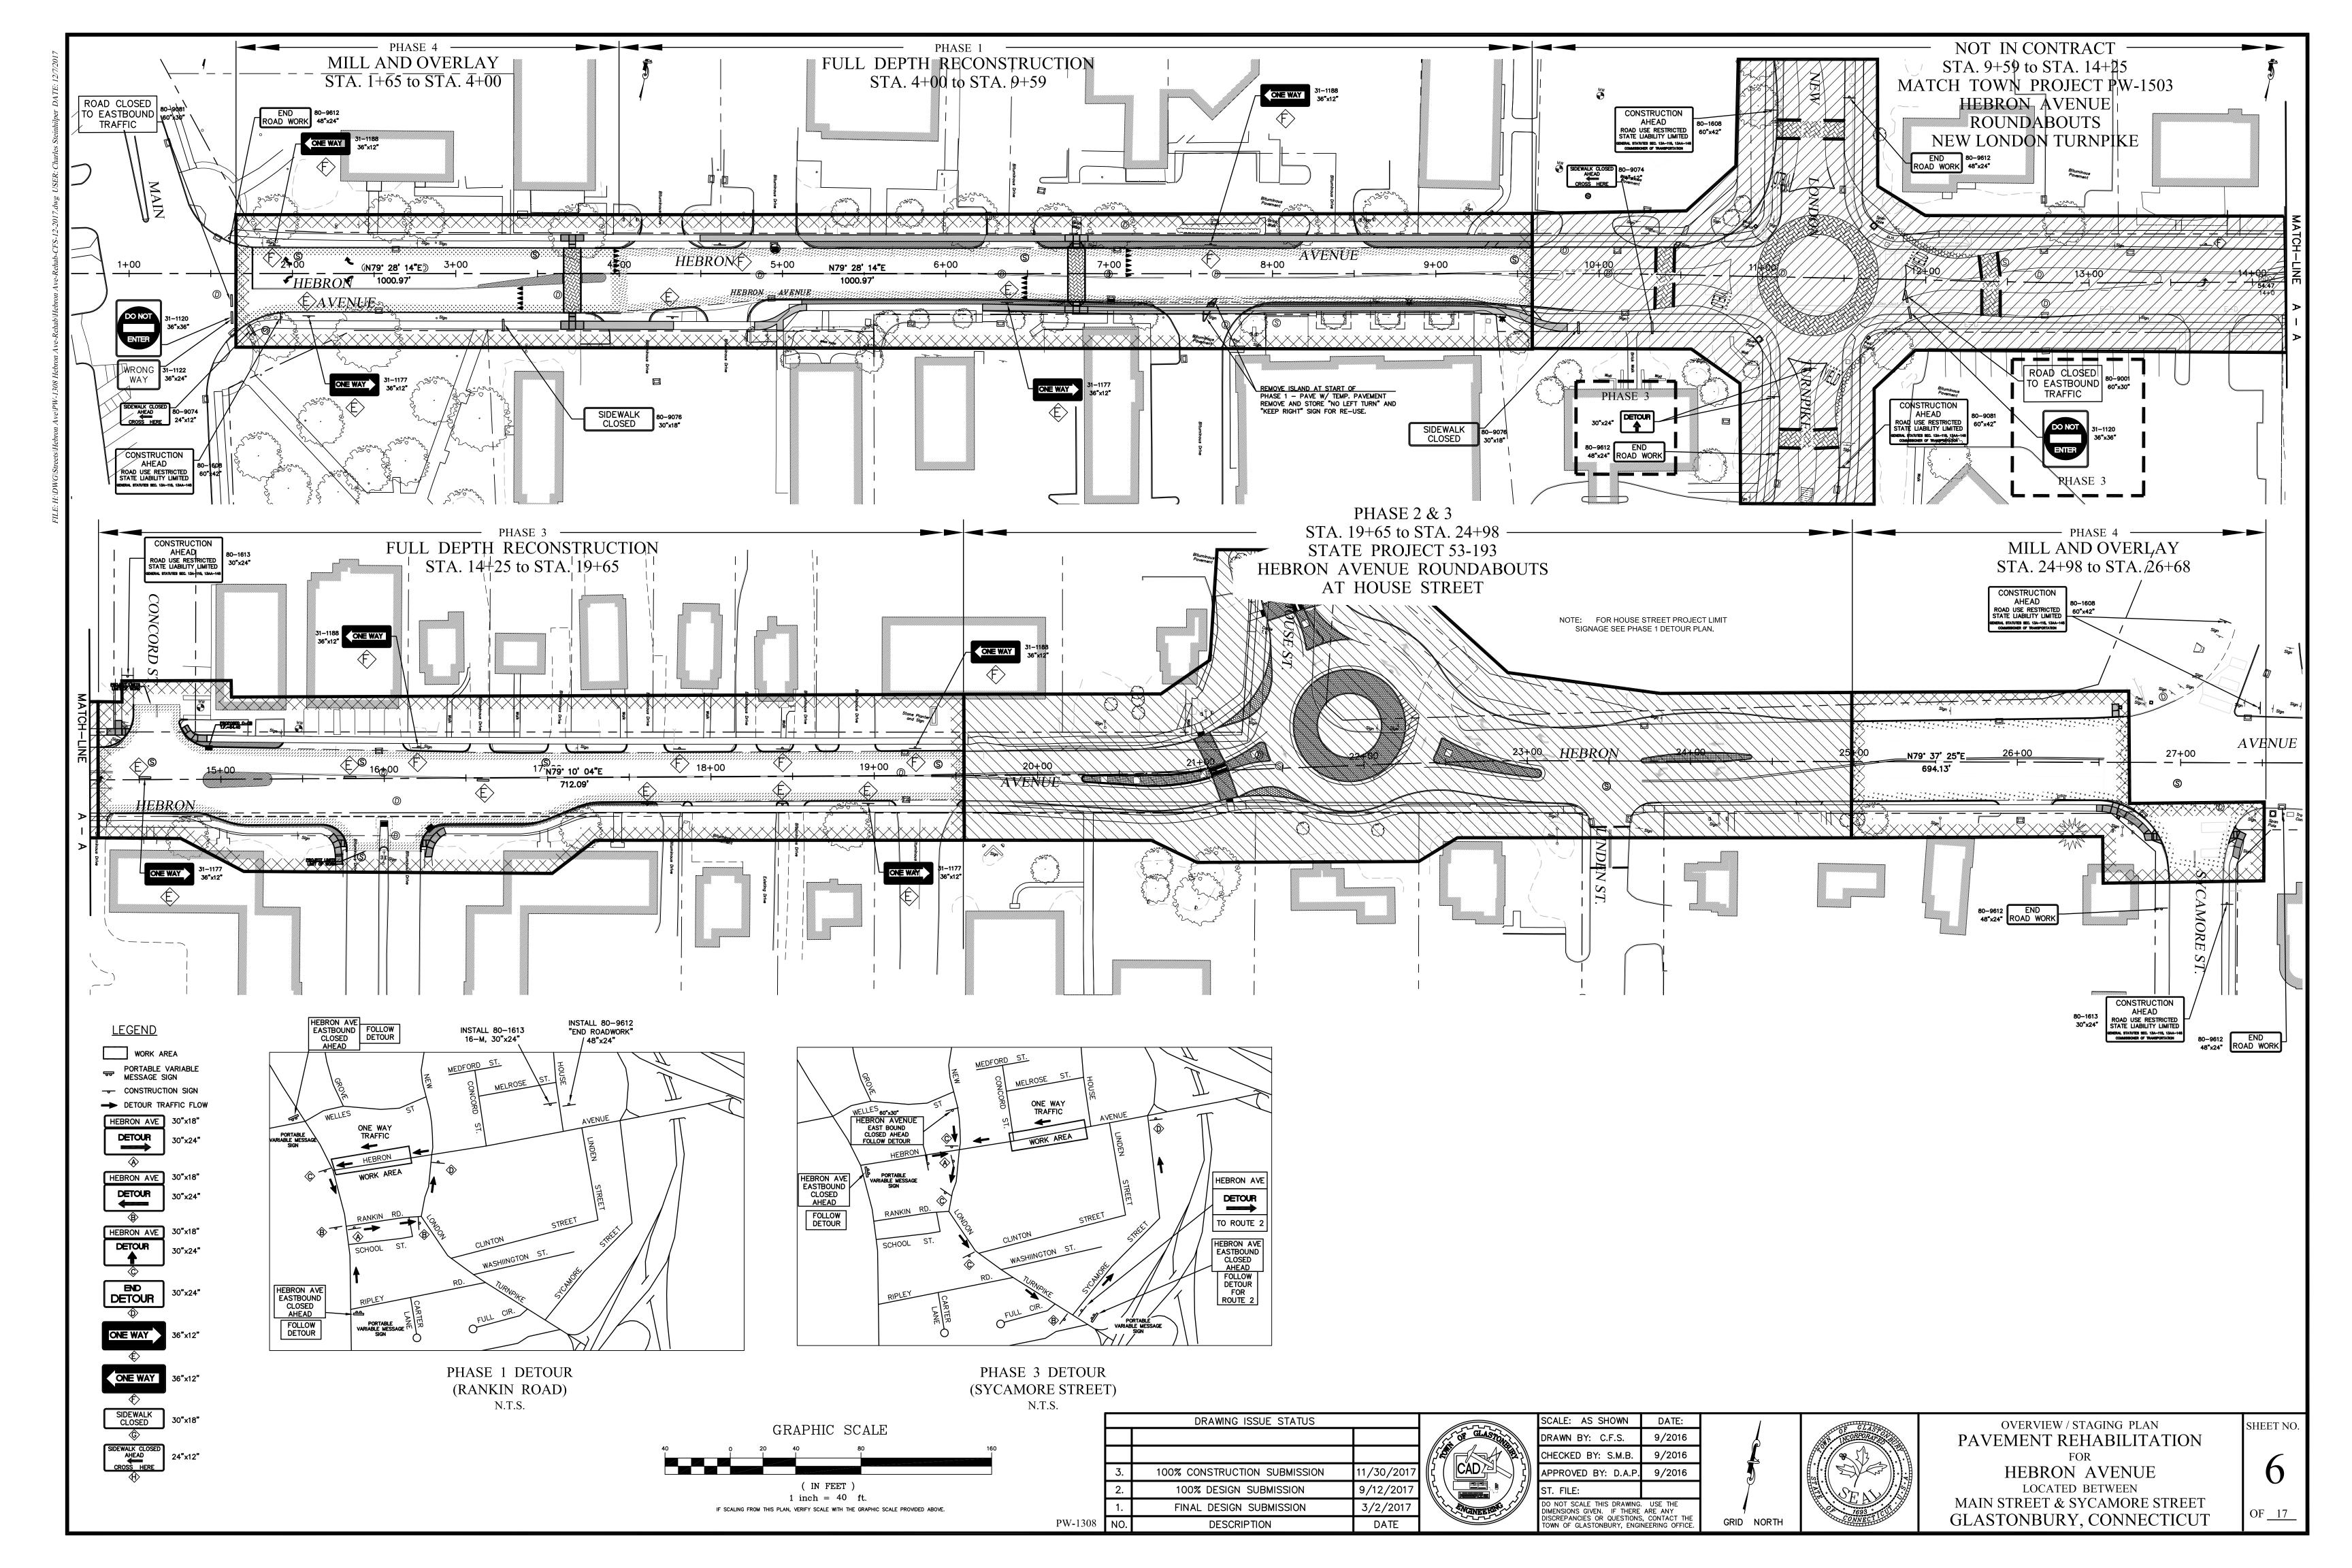

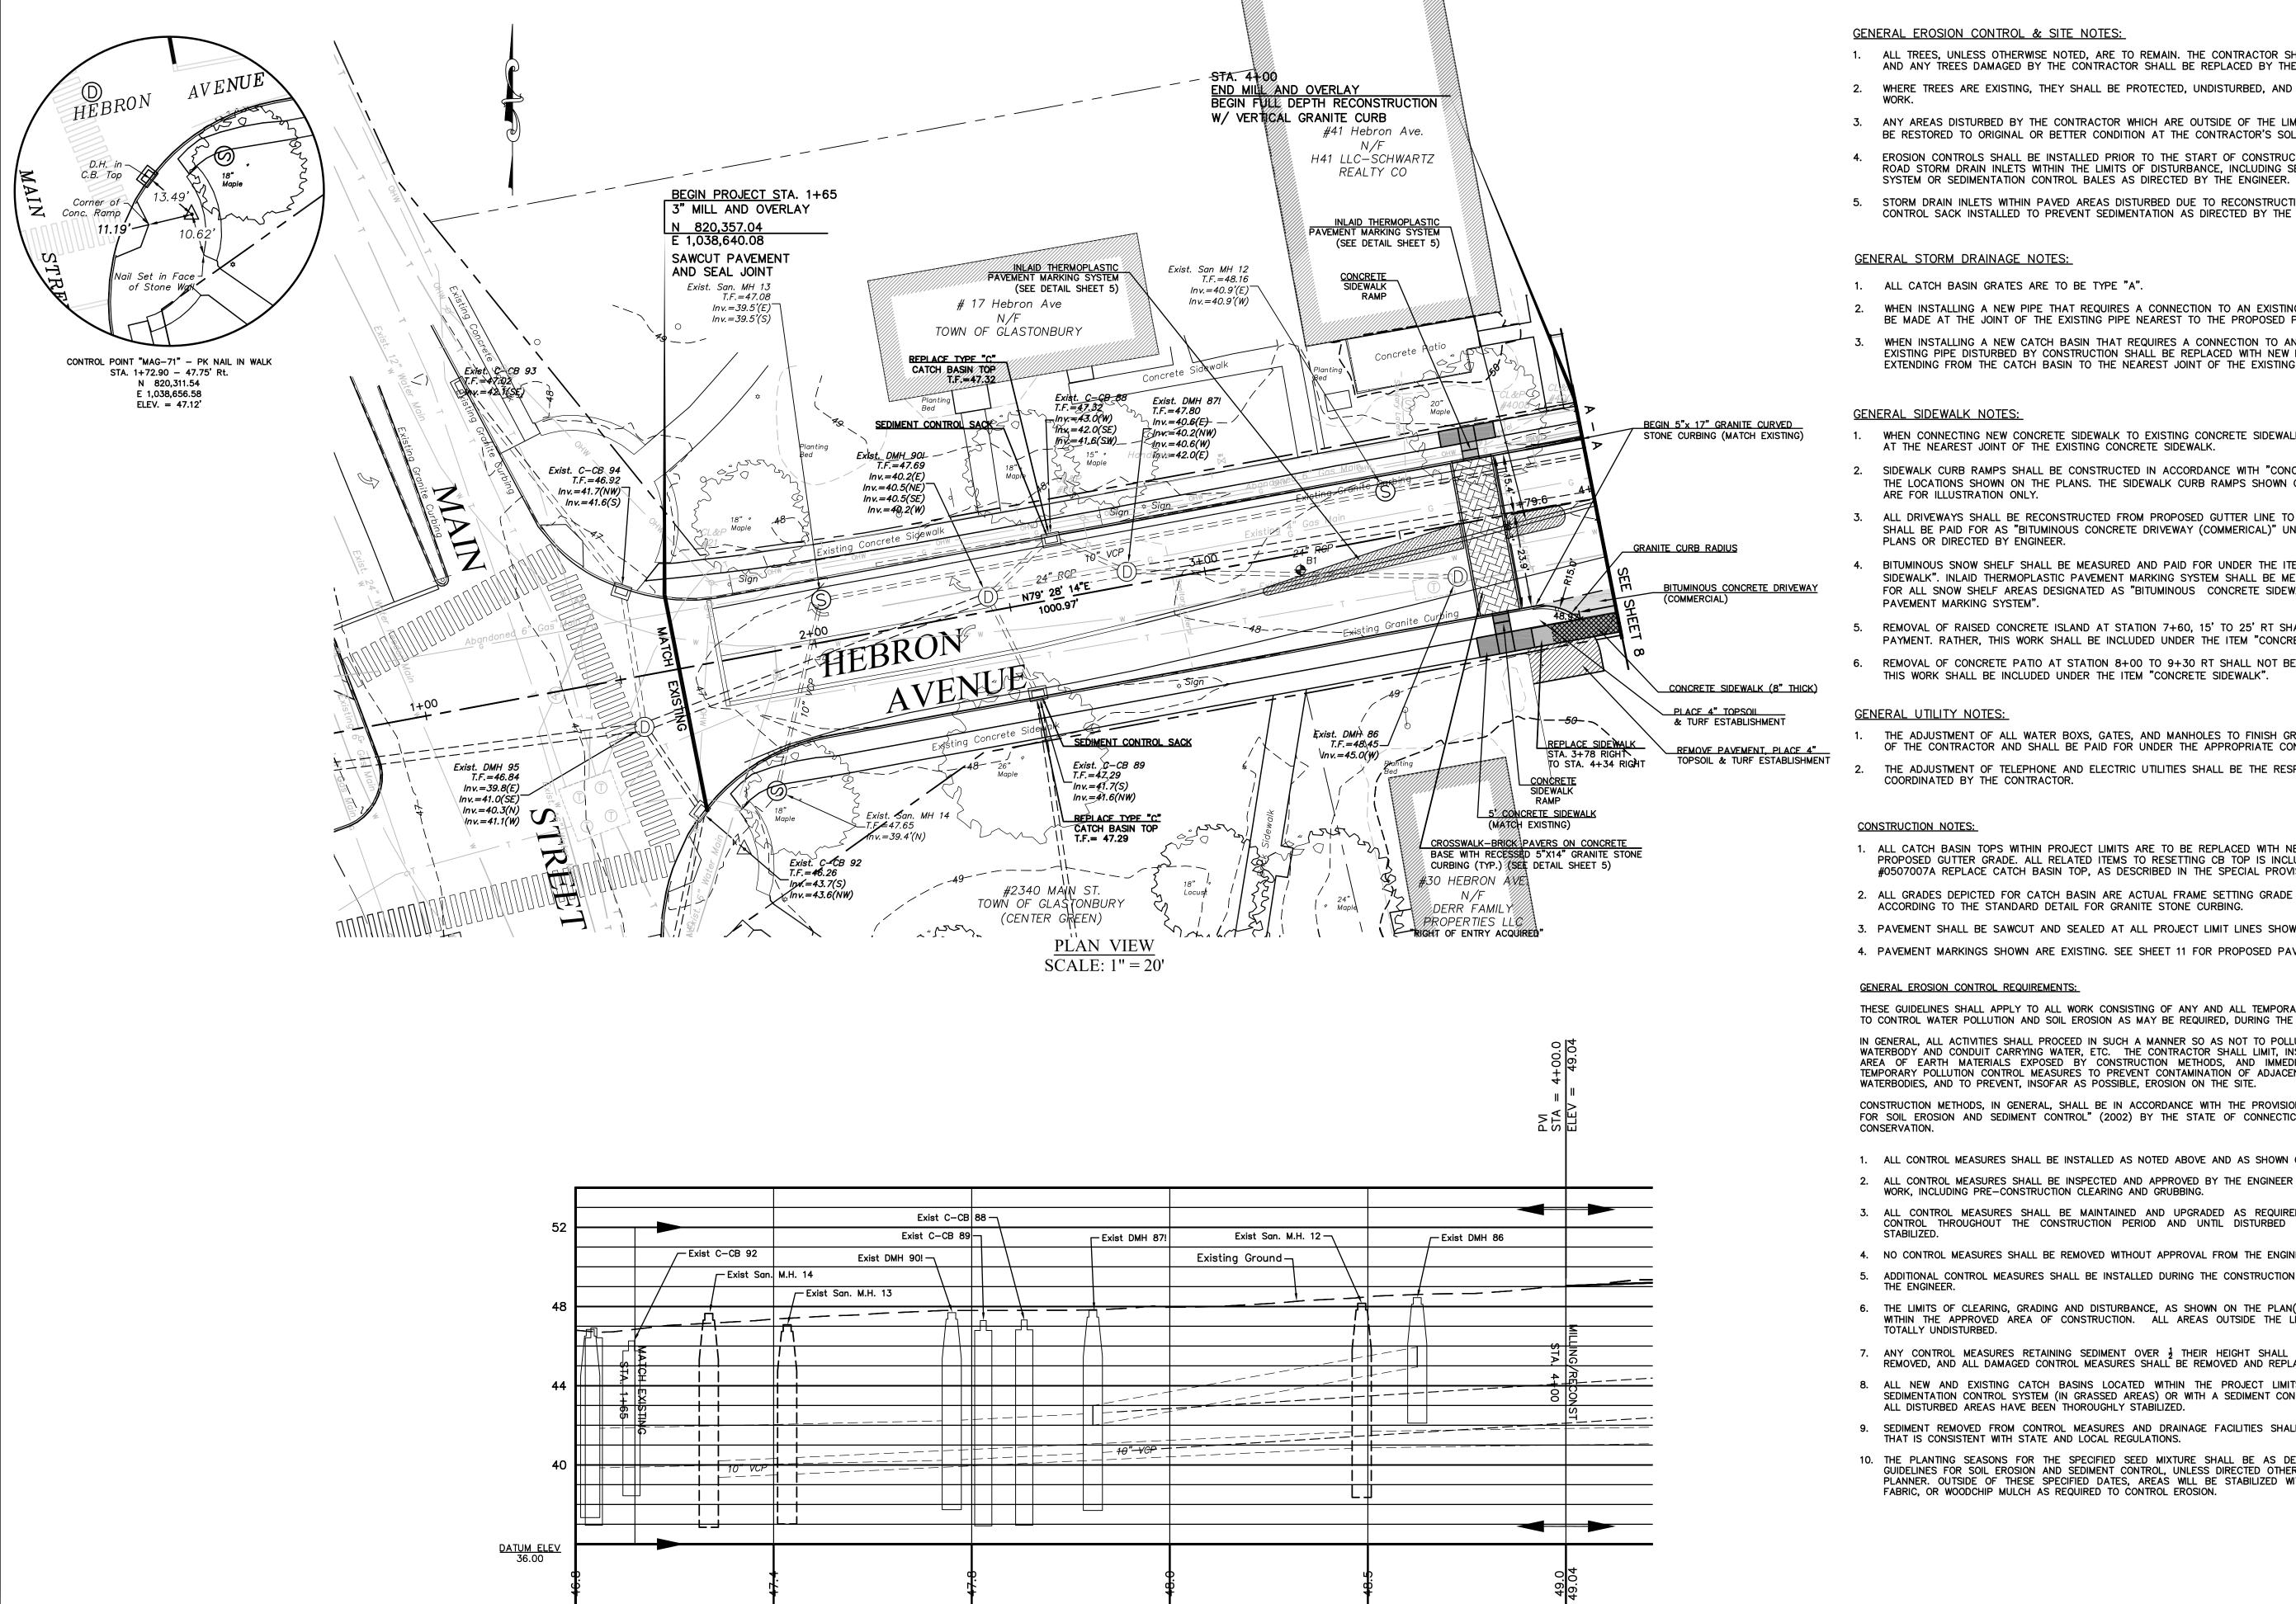2+50

GRAPHIC SCALE

( IN FEET )

1 inch = 20 ft.

IF SCALING FROM THIS PLAN, VERIFY SCALE WITH THE GRAPHIC SCALE PROVIDED ABOVE.

1+50

PROFILE

SCALE: 1'' = 20' HORZ.

SCALE: 1'' = 4' VERT.

2+00

3+00

PW-1308

### GENERAL EROSION CONTROL & SITE NOTES:

- 1. ALL TREES, UNLESS OTHERWISE NOTED, ARE TO REMAIN. THE CONTRACTOR SHALL PROTECT ALL TREES, AND ANY TREES DAMAGED BY THE CONTRACTOR SHALL BE REPLACED BY THE CONTRACTOR, AT NO COST.
- WHERE TREES ARE EXISTING, THEY SHALL BE PROTECTED, UNDISTURBED, AND INCORPORATED IN THE
- 3. ANY AREAS DISTURBED BY THE CONTRACTOR WHICH ARE OUTSIDE OF THE LIMITS OF CONSTRUCTION SHALL BE RESTORED TO ORIGINAL OR BETTER CONDITION AT THE CONTRACTOR'S SOLE EXPENSE.
- 4. EROSION CONTROLS SHALL BE INSTALLED PRIOR TO THE START OF CONSTRUCTION TO PROTECT ALL OFF ROAD STORM DRAIN INLETS WITHIN THE LIMITS OF DISTURBANCE, INCLUDING SEDIMENTATION CONTROL
- 5. STORM DRAIN INLETS WITHIN PAVED AREAS DISTURBED DUE TO RECONSTRUCTION SHALL HAVE A SEDIMENT CONTROL SACK INSTALLED TO PREVENT SEDIMENTATION AS DIRECTED BY THE ENGINEER.

- 1. ALL CATCH BASIN GRATES ARE TO BE TYPE "A".
- 2. WHEN INSTALLING A NEW PIPE THAT REQUIRES A CONNECTION TO AN EXISTING PIPE, THE NEW CONNECTION SHALL BE MADE AT THE JOINT OF THE EXISTING PIPE NEAREST TO THE PROPOSED PIPE.
- 3. WHEN INSTALLING A NEW CATCH BASIN THAT REQUIRES A CONNECTION TO AN EXISTING PIPE, THE SECTION OF EXISTING PIPE DISTURBED BY CONSTRUCTION SHALL BE REPLACED WITH NEW PIPE OF SIMILAR SIZE AND TYPE EXTENDING FROM THE CATCH BASIN TO THE NEAREST JOINT OF THE EXISTING PIPE.

- WHEN CONNECTING NEW CONCRETE SIDEWALK TO EXISTING CONCRETE SIDEWALK, THE CONNECTION SHALL BE MADE AT THE NEAREST JOINT OF THE EXISTING CONCRETE SIDEWALK.
- 2. SIDEWALK CURB RAMPS SHALL BE CONSTRUCTED IN ACCORDANCE WITH "CONCRETE SIDEWALK RAMP DETAILS" AT THE LOCATIONS SHOWN ON THE PLANS. THE SIDEWALK CURB RAMPS SHOWN ON "PAVEMENT MARKING PLAN" PLAN
- 3. ALL DRIVEWAYS SHALL BE RECONSTRUCTED FROM PROPOSED GUTTER LINE TO THE FRONT OF THE SIDEWALK, AND SHALL BE PAID FOR AS "BITUMINOUS CONCRETE DRIVEWAY (COMMERICAL)" UNLESS OTHERWISE SPECIFIED ON
- 4. BITUMINOUS SNOW SHELF SHALL BE MEASURED AND PAID FOR UNDER THE ITEM "BITUMINOUS CONCRETE SIDEWALK". INLAID THERMOPLASTIC PAVEMENT MARKING SYSTEM SHALL BE MEASURED AND PAID FOR SEPARATELY FOR ALL SNOW SHELF AREAS DESIGNATED AS "BITUMINOUS CONCRETE SIDEWALK W/ INLAID THERMOPLASTIC PAVEMENT MARKING SYSTEM".
- 5. REMOVAL OF RAISED CONCRETE ISLAND AT STATION 7+60, 15' TO 25' RT SHALL NOT BE MEASURED FOR PAYMENT. RATHER, THIS WORK SHALL BE INCLUDED UNDER THE ITEM "CONCRETE SIDEWALK".
- 6. REMOVAL OF CONCRETE PATIO AT STATION 8+00 TO 9+30 RT SHALL NOT BE MEASURED FOR PAYMENT. RATHER, THIS WORK SHALL BE INCLUDED UNDER THE ITEM "CONCRETE SIDEWALK".

- 1. THE ADJUSTMENT OF ALL WATER BOXS, GATES, AND MANHOLES TO FINISH GRADE SHALL BE THE RESPONSIBILITY OF THE CONTRACTOR AND SHALL BE PAID FOR UNDER THE APPROPRIATE CONTRACT ITEM,.
- THE ADJUSTMENT OF TELEPHONE AND ELECTRIC UTILITIES SHALL BE THE RESPONSIBILITY OF THAT UTILITY; AND COORDINATED BY THE CONTRACTOR.
- 1. ALL CATCH BASIN TOPS WITHIN PROJECT LIMITS ARE TO BE REPLACED WITH NEW TOPS, AND RESET TO MATCH PROPOSED GUTTER GRADE. ALL RELATED ITEMS TO RESETTING CB TOP IS INCLUDED IN THE COST OF ITEM #0507007A REPLACE CATCH BASIN TOP, AS DESCRIBED IN THE SPECIAL PROVISIONS..
- 2. ALL GRADES DEPICTED FOR CATCH BASIN ARE ACTUAL FRAME SETTING GRADE AND INCLUDE THE 1" DEPRESSION ACCORDING TO THE STANDARD DETAIL FOR GRANITE STONE CURBING.
- 3. PAVEMENT SHALL BE SAWCUT AND SEALED AT ALL PROJECT LIMIT LINES SHOWN ON PLANS.
- 4. PAVEMENT MARKINGS SHOWN ARE EXISTING. SEE SHEET 11 FOR PROPOSED PAVEMENT MARKINGS

## GENERAL EROSION CONTROL REQUIREMENTS:

THESE GUIDELINES SHALL APPLY TO ALL WORK CONSISTING OF ANY AND ALL TEMPORARY AND/OR PERMANENT MEASURES TO CONTROL WATER POLLUTION AND SOIL EROSION AS MAY BE REQUIRED, DURING THE CONSTRUCTION OF THE PROJECT.

IN GENERAL, ALL ACTIVITIES SHALL PROCEED IN SUCH A MANNER SO AS NOT TO POLLUTE ANY WETLANDS, WATERCOURSE, WATERBODY AND CONDUIT CARRYING WATER, ETC. THE CONTRACTOR SHALL LIMIT, INSOFAR AS POSSIBLE, THE SURFACE AREA OF EARTH MATERIALS EXPOSED BY CONSTRUCTION METHODS, AND IMMEDIATELY PROVIDE PERMANENT AND TEMPORARY POLLUTION CONTROL MEASURES TO PREVENT CONTAMINATION OF ADJACENT WETLANDS, WATERCOURSES AND WATERBODIES, AND TO PREVENT, INSOFAR AS POSSIBLE, EROSION ON THE SITE.


CONSTRUCTION METHODS, IN GENERAL, SHALL BE IN ACCORDANCE WITH THE PROVISIONS SET FORTH IN THE "GUIDELINES FOR SOIL EROSION AND SEDIMENT CONTROL" (2002) BY THE STATE OF CONNECTICUT COUNCIL ON SOIL AND WATER

- 1. ALL CONTROL MEASURES SHALL BE INSTALLED AS NOTED ABOVE AND AS SHOWN ON THE PLANS.
- 2. ALL CONTROL MEASURES SHALL BE INSPECTED AND APPROVED BY THE ENGINEER PRIOR TO COMMENCEMENT OF ANY WORK, INCLUDING PRE-CONSTRUCTION CLEARING AND GRUBBING.
- 3. ALL CONTROL MEASURES SHALL BE MAINTAINED AND UPGRADED AS REQUIRED TO ACHIEVE PROPER SEDIMENT CONTROL THROUGHOUT THE CONSTRUCTION PERIOD AND UNTIL DISTURBED AREAS HAVE BEEN THOROUGHLY
- 4. NO CONTROL MEASURES SHALL BE REMOVED WITHOUT APPROVAL FROM THE ENGINEER.
- 5. ADDITIONAL CONTROL MEASURES SHALL BE INSTALLED DURING THE CONSTRUCTION PERIOD IF DEEMED NECESSARY BY
- 6. THE LIMITS OF CLEARING, GRADING AND DISTURBANCE, AS SHOWN ON THE PLAN(S), SHALL BE KEPT TO A MINIMUM WITHIN THE APPROVED AREA OF CONSTRUCTION. ALL AREAS OUTSIDE THE LIMITS OF CLEARING SHALL REMAIN TOTALLY UNDISTURBED.
- 7. ANY CONTROL MEASURES RETAINING SEDIMENT OVER ½ THEIR HEIGHT SHALL HAVE THE SEDIMENT IMMEDIATELY REMOVED, AND ALL DAMAGED CONTROL MEASURES SHALL BE REMOVED AND REPLACED.
- 8. ALL NEW AND EXISTING CATCH BASINS LOCATED WITHIN THE PROJECT LIMITS SHALL BE PROTECTED WITH A SEDIMENTATION CONTROL SYSTEM (IN GRASSED AREAS) OR WITH A SEDIMENT CONTROL SACK IN PAVED AREAS UNTIL ALL DISTURBED AREAS HAVE BEEN THOROUGHLY STABILIZED.
- 9. SEDIMENT REMOVED FROM CONTROL MEASURES AND DRAINAGE FACILITIES SHALL BE DISPOSED OF IN A MANNER THAT IS CONSISTENT WITH STATE AND LOCAL REGULATIONS.
- 10. THE PLANTING SEASONS FOR THE SPECIFIED SEED MIXTURE SHALL BE AS DEFINED IN THE 2002 CONNECTICUT GUIDELINES FOR SOIL EROSION AND SEDIMENT CONTROL, UNLESS DIRECTED OTHERWISE BY THE TOWN ENVIROMENTAL PLANNER. OUTSIDE OF THESE SPECIFIED DATES, AREAS WILL BE STABILIZED WITH HAYBALE CHECK DAMS, FILTER


77-7		DRAWING ISSUE STATUS
OF GLASTON		
	11/30/2017	100% CONSTRUCTION SUBMISSION
	9/12/2017	100% DESIGN SUBMISSION
ENGINEERING	3/2/2017	FINAL DESIGN SUBMISSION
	DATE	DESCRIPTION


4+00

3+50

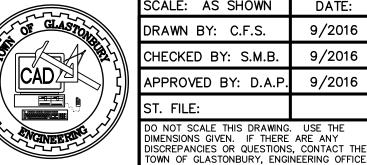

SCALE: AS SHOWN	DATE:					
RAWN BY: C.F.S.	9/2016					
CHECKED BY: S.M.B.	9/2016					
APPROVED BY: D.A.P.	9/2016					
ST. FILE:						
O NOT SCALE THIS DRAWING. USE THE IMENSIONS GIVEN. IF THERE ARE ANY						

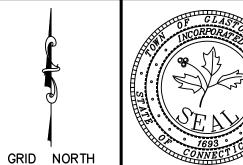


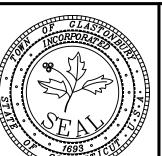



PLAN & PROFILE PAVEMENT REHABILITATION


HEBRON AVENUE LOCATED BETWEEN MAIN STREET & SYCAMORE STREET GLASTONBURY, CONNECTICUT OF <u>17</u>


SHEET NO

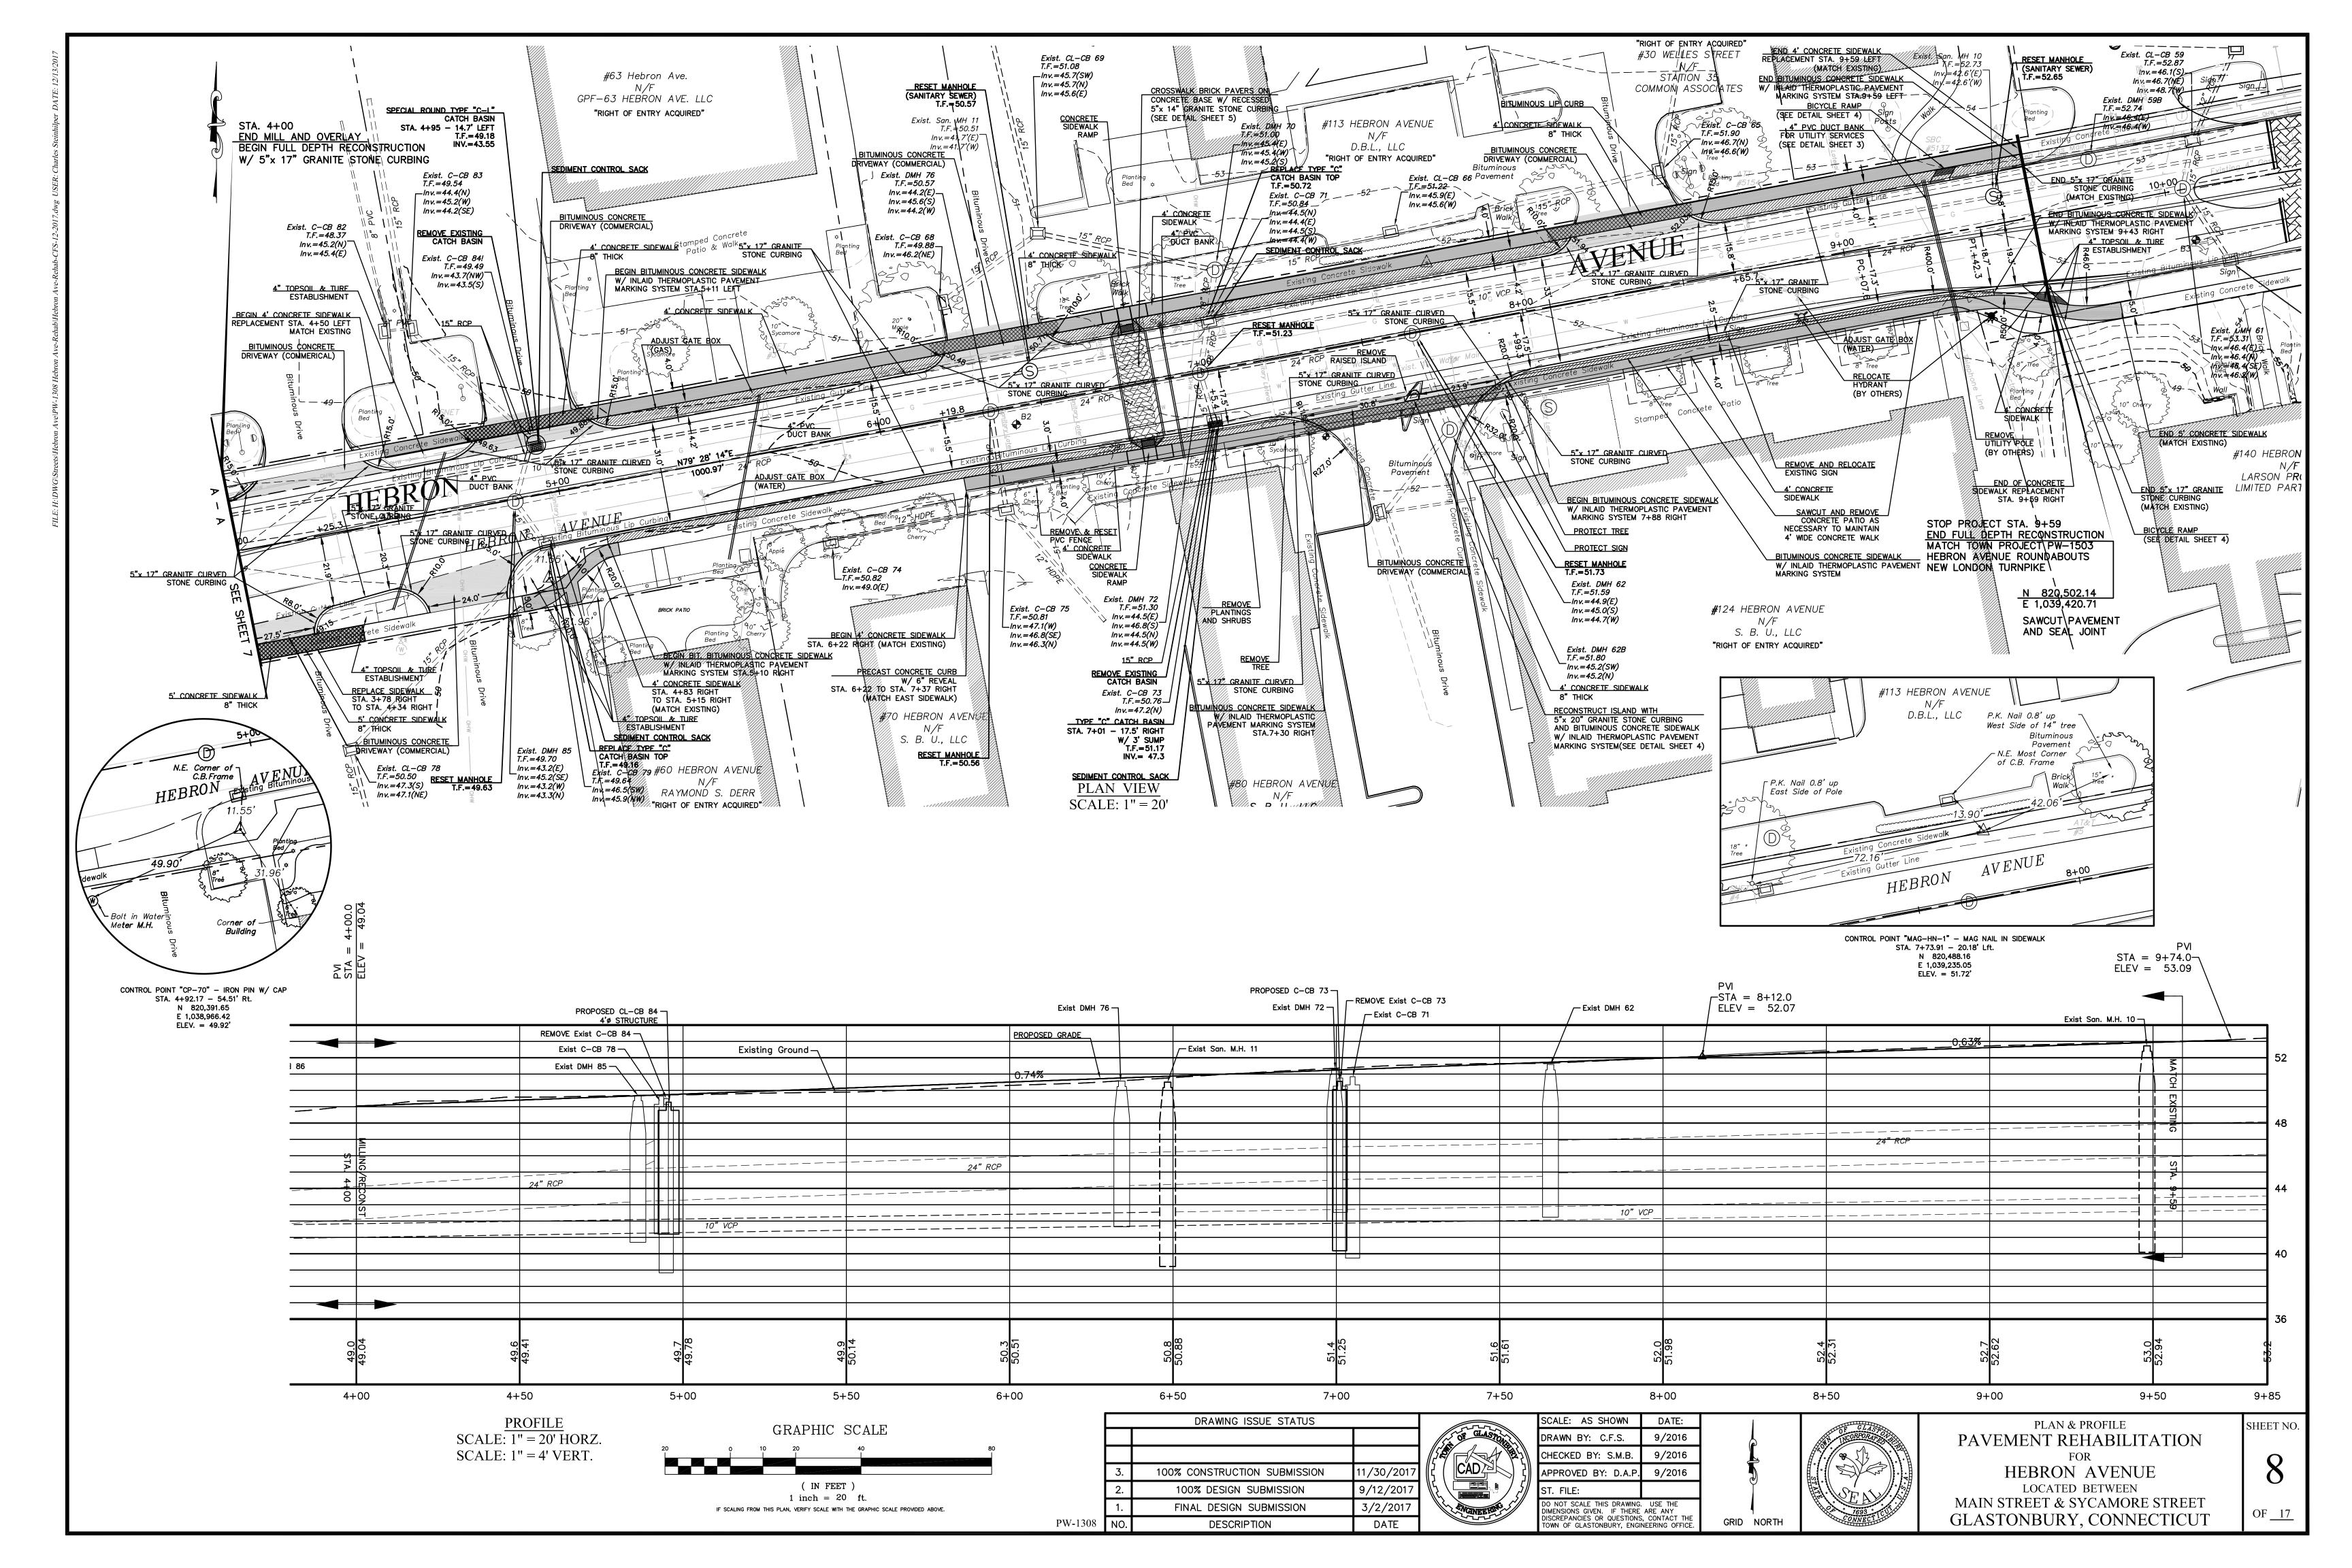


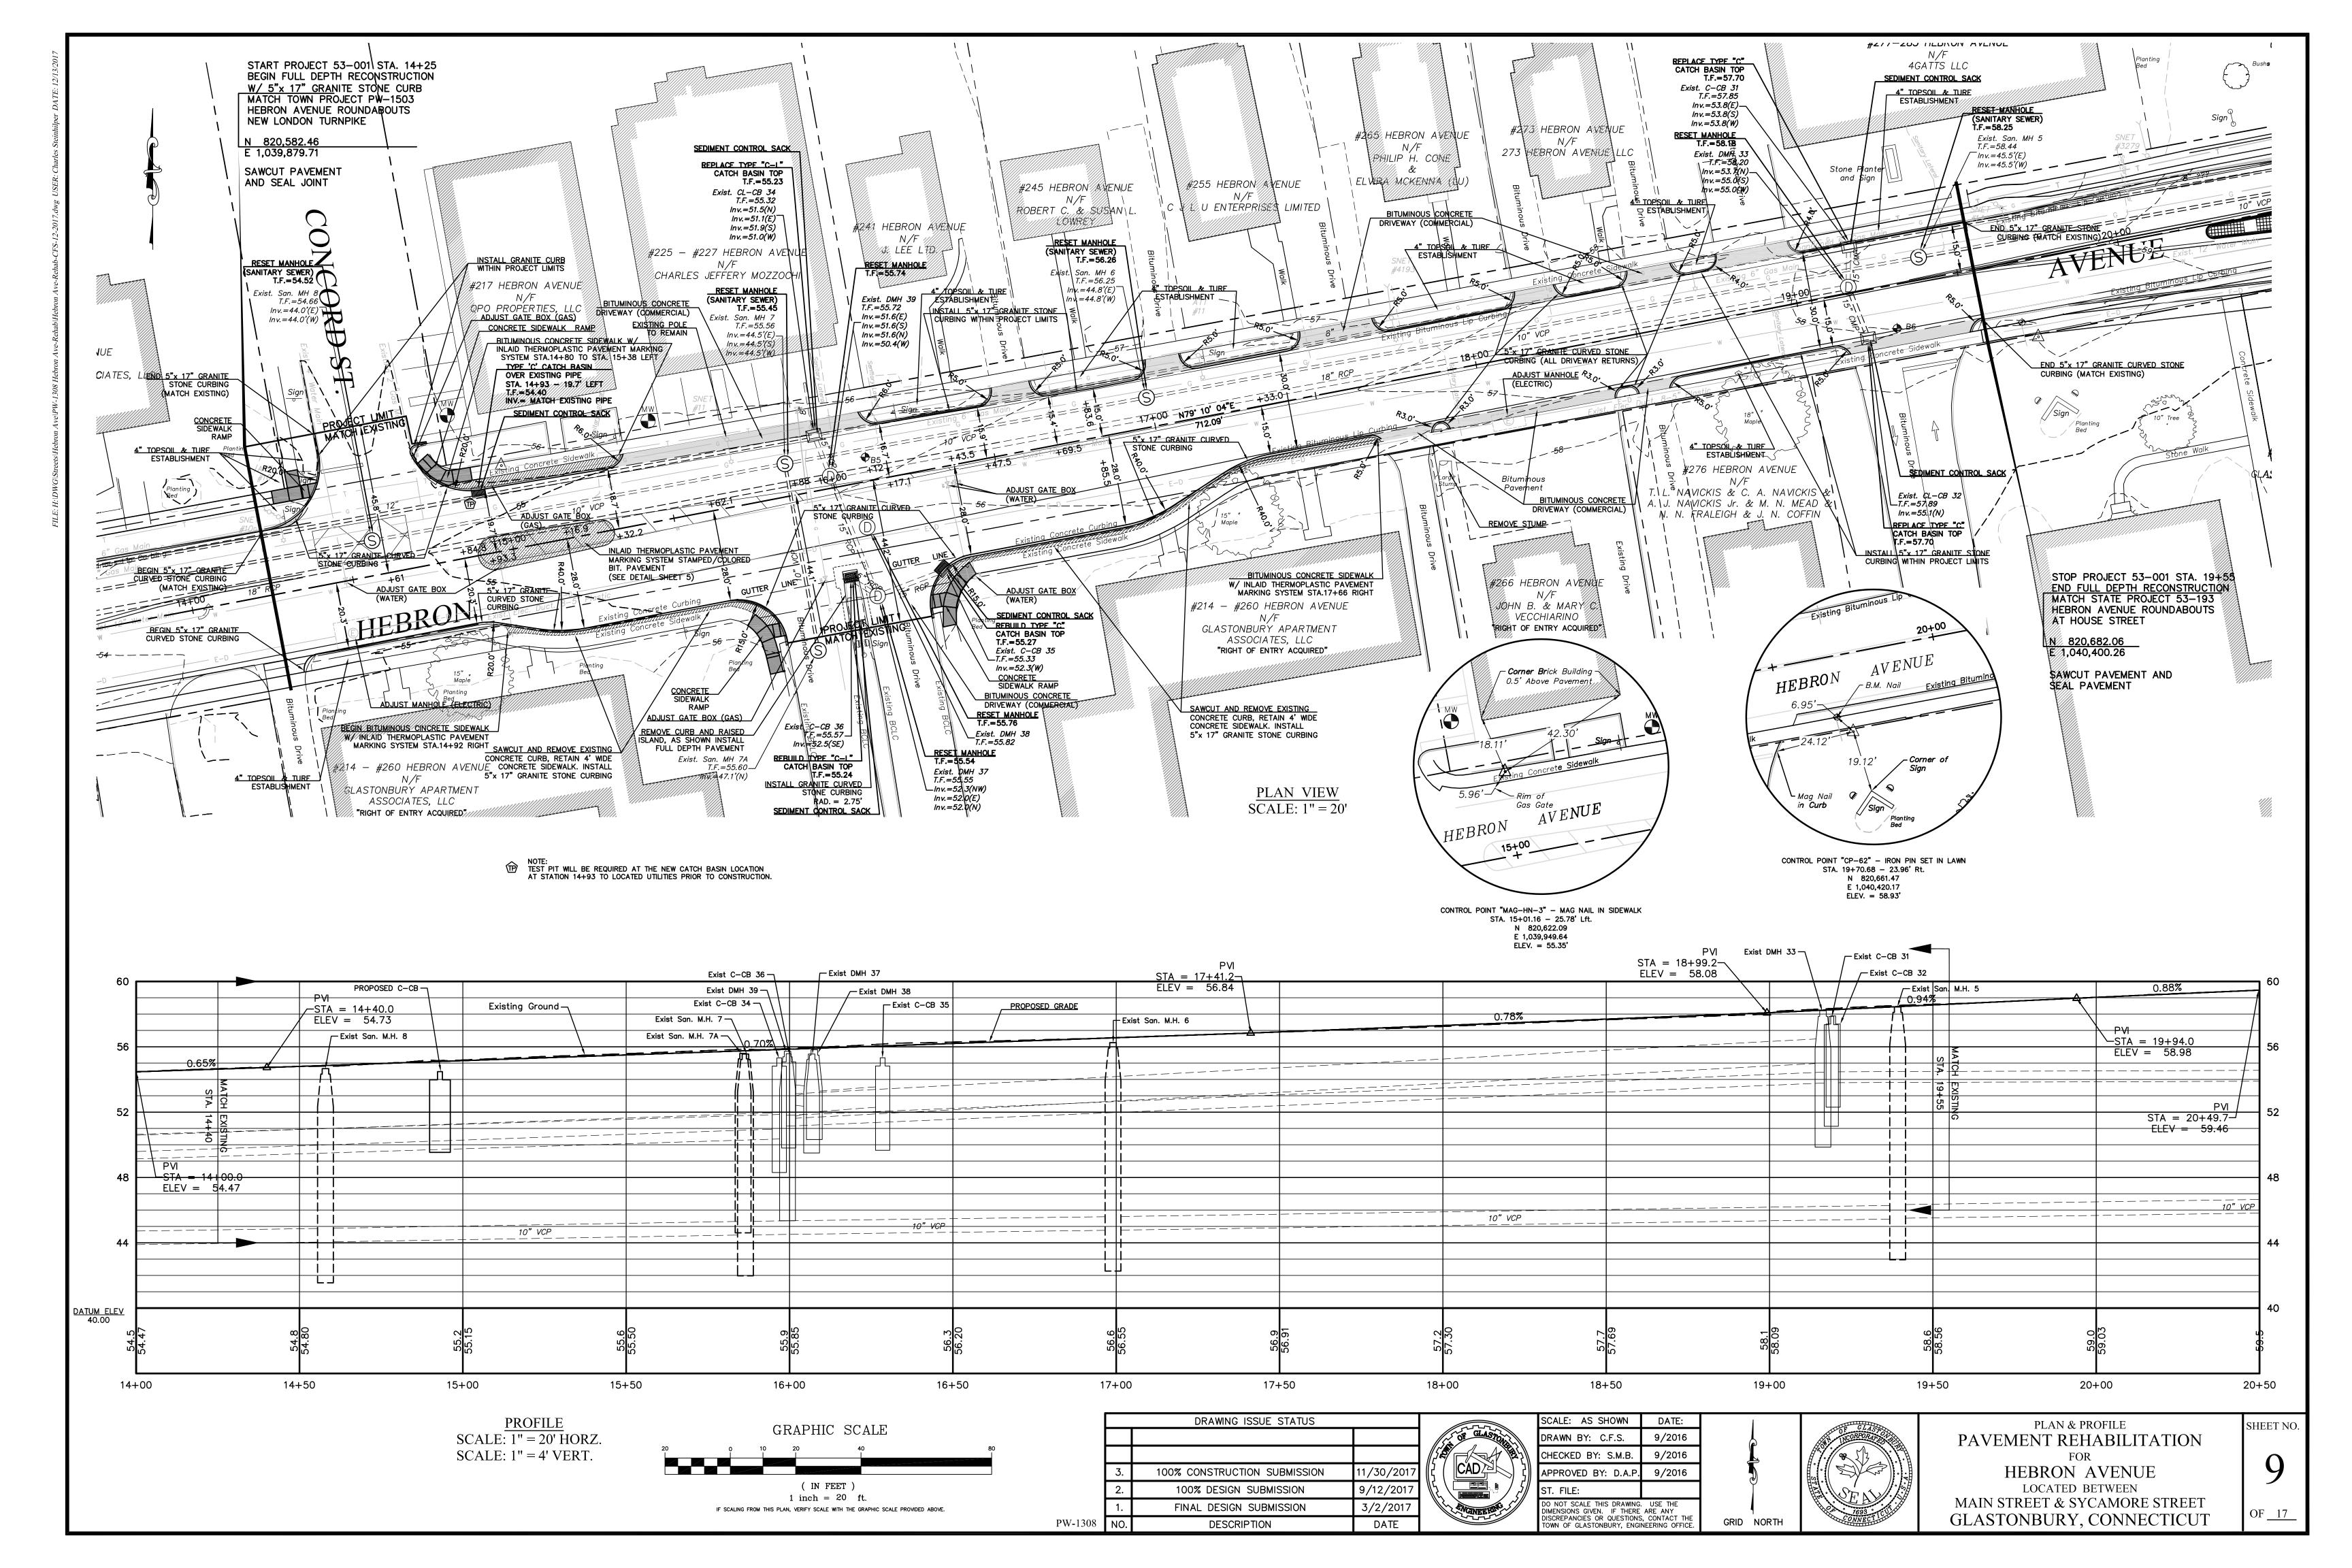


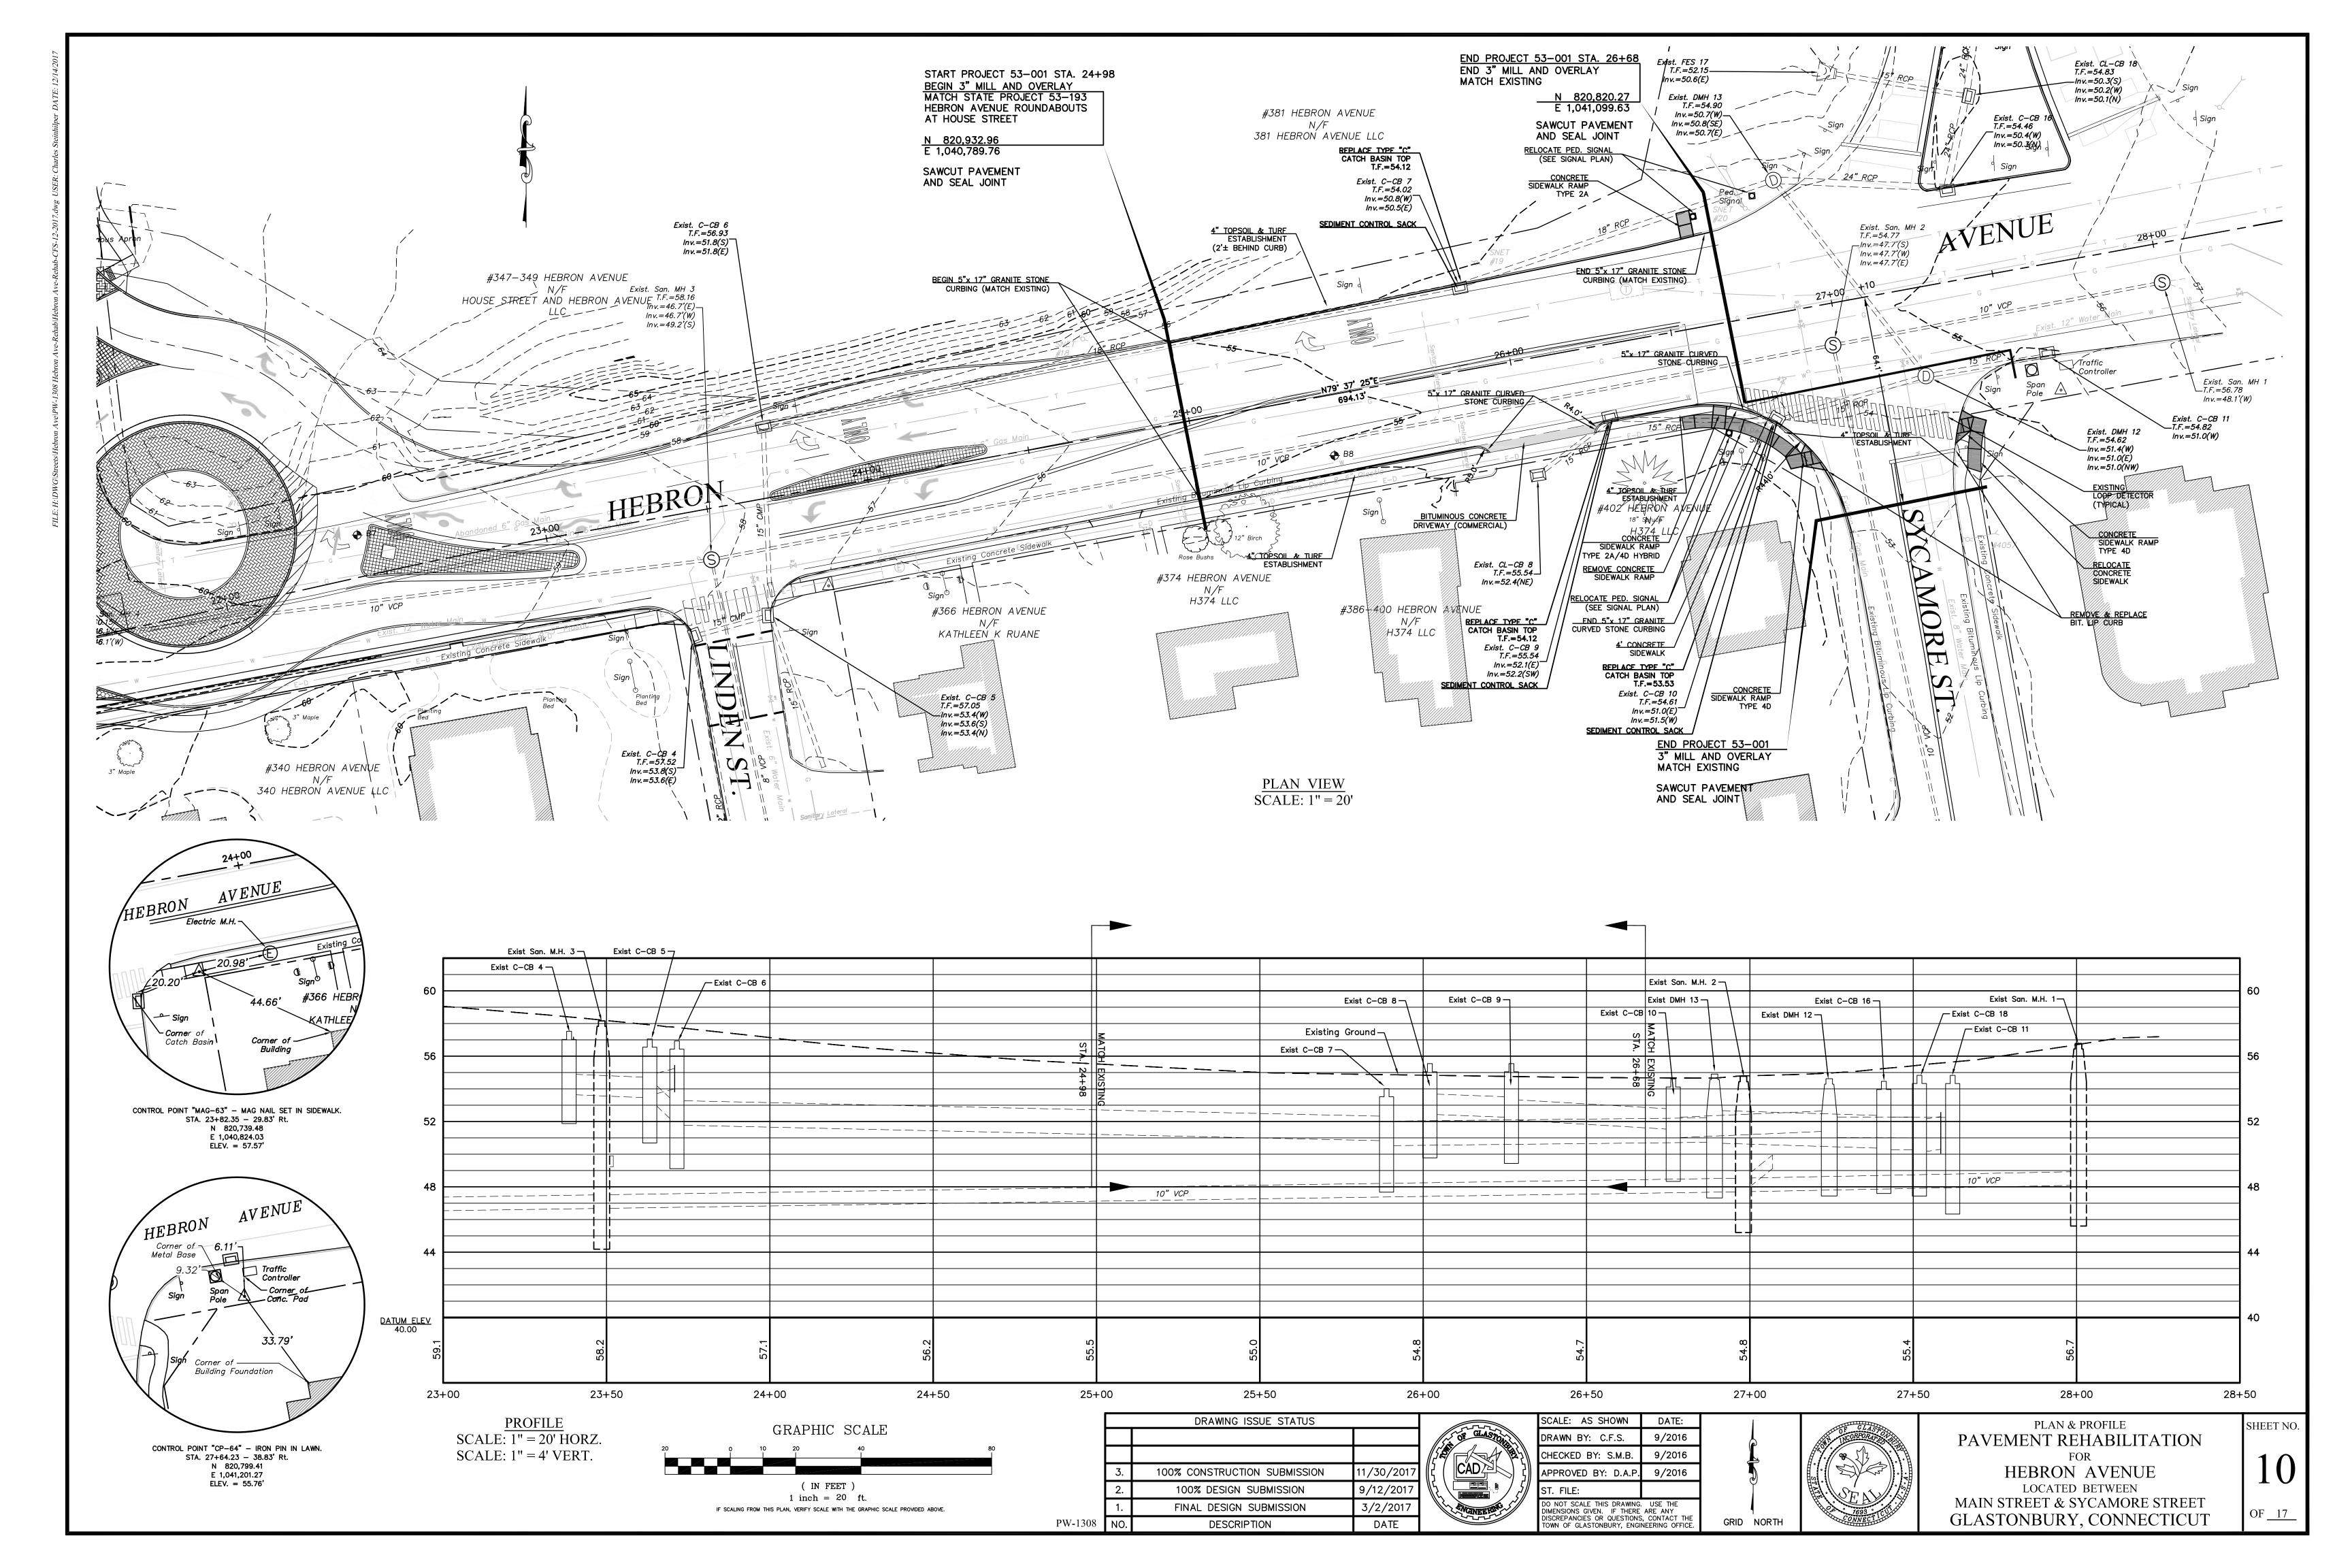


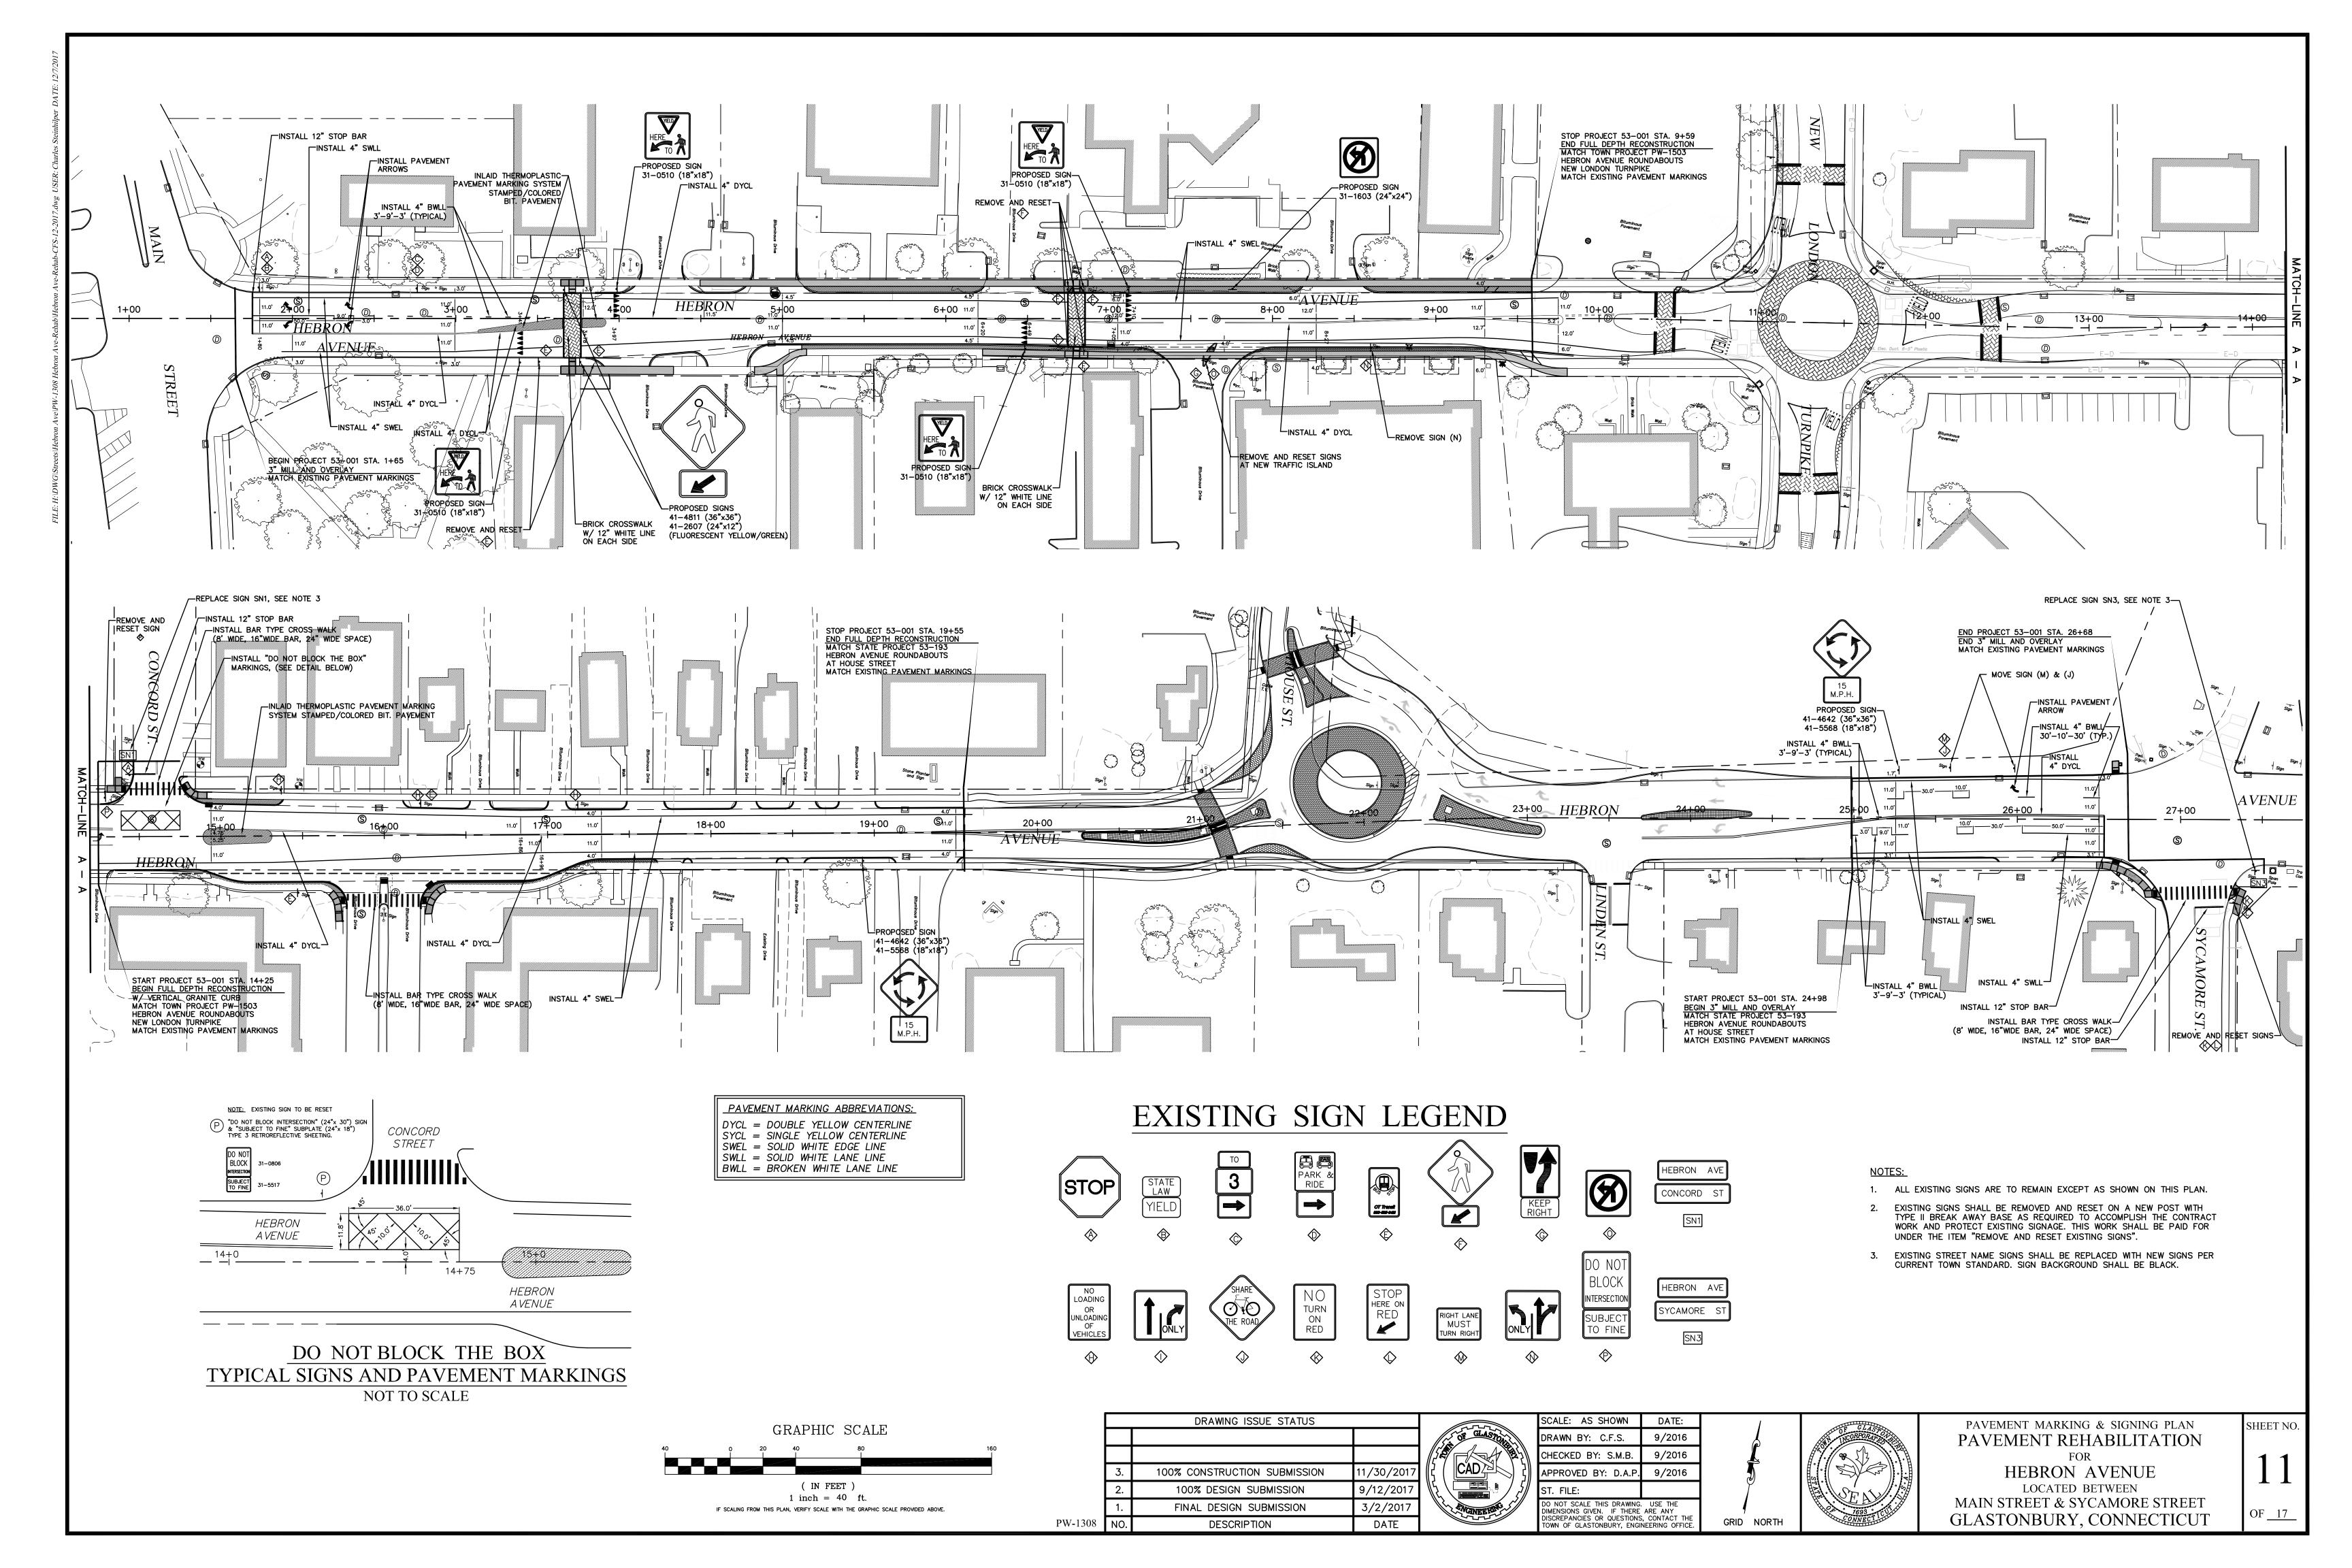


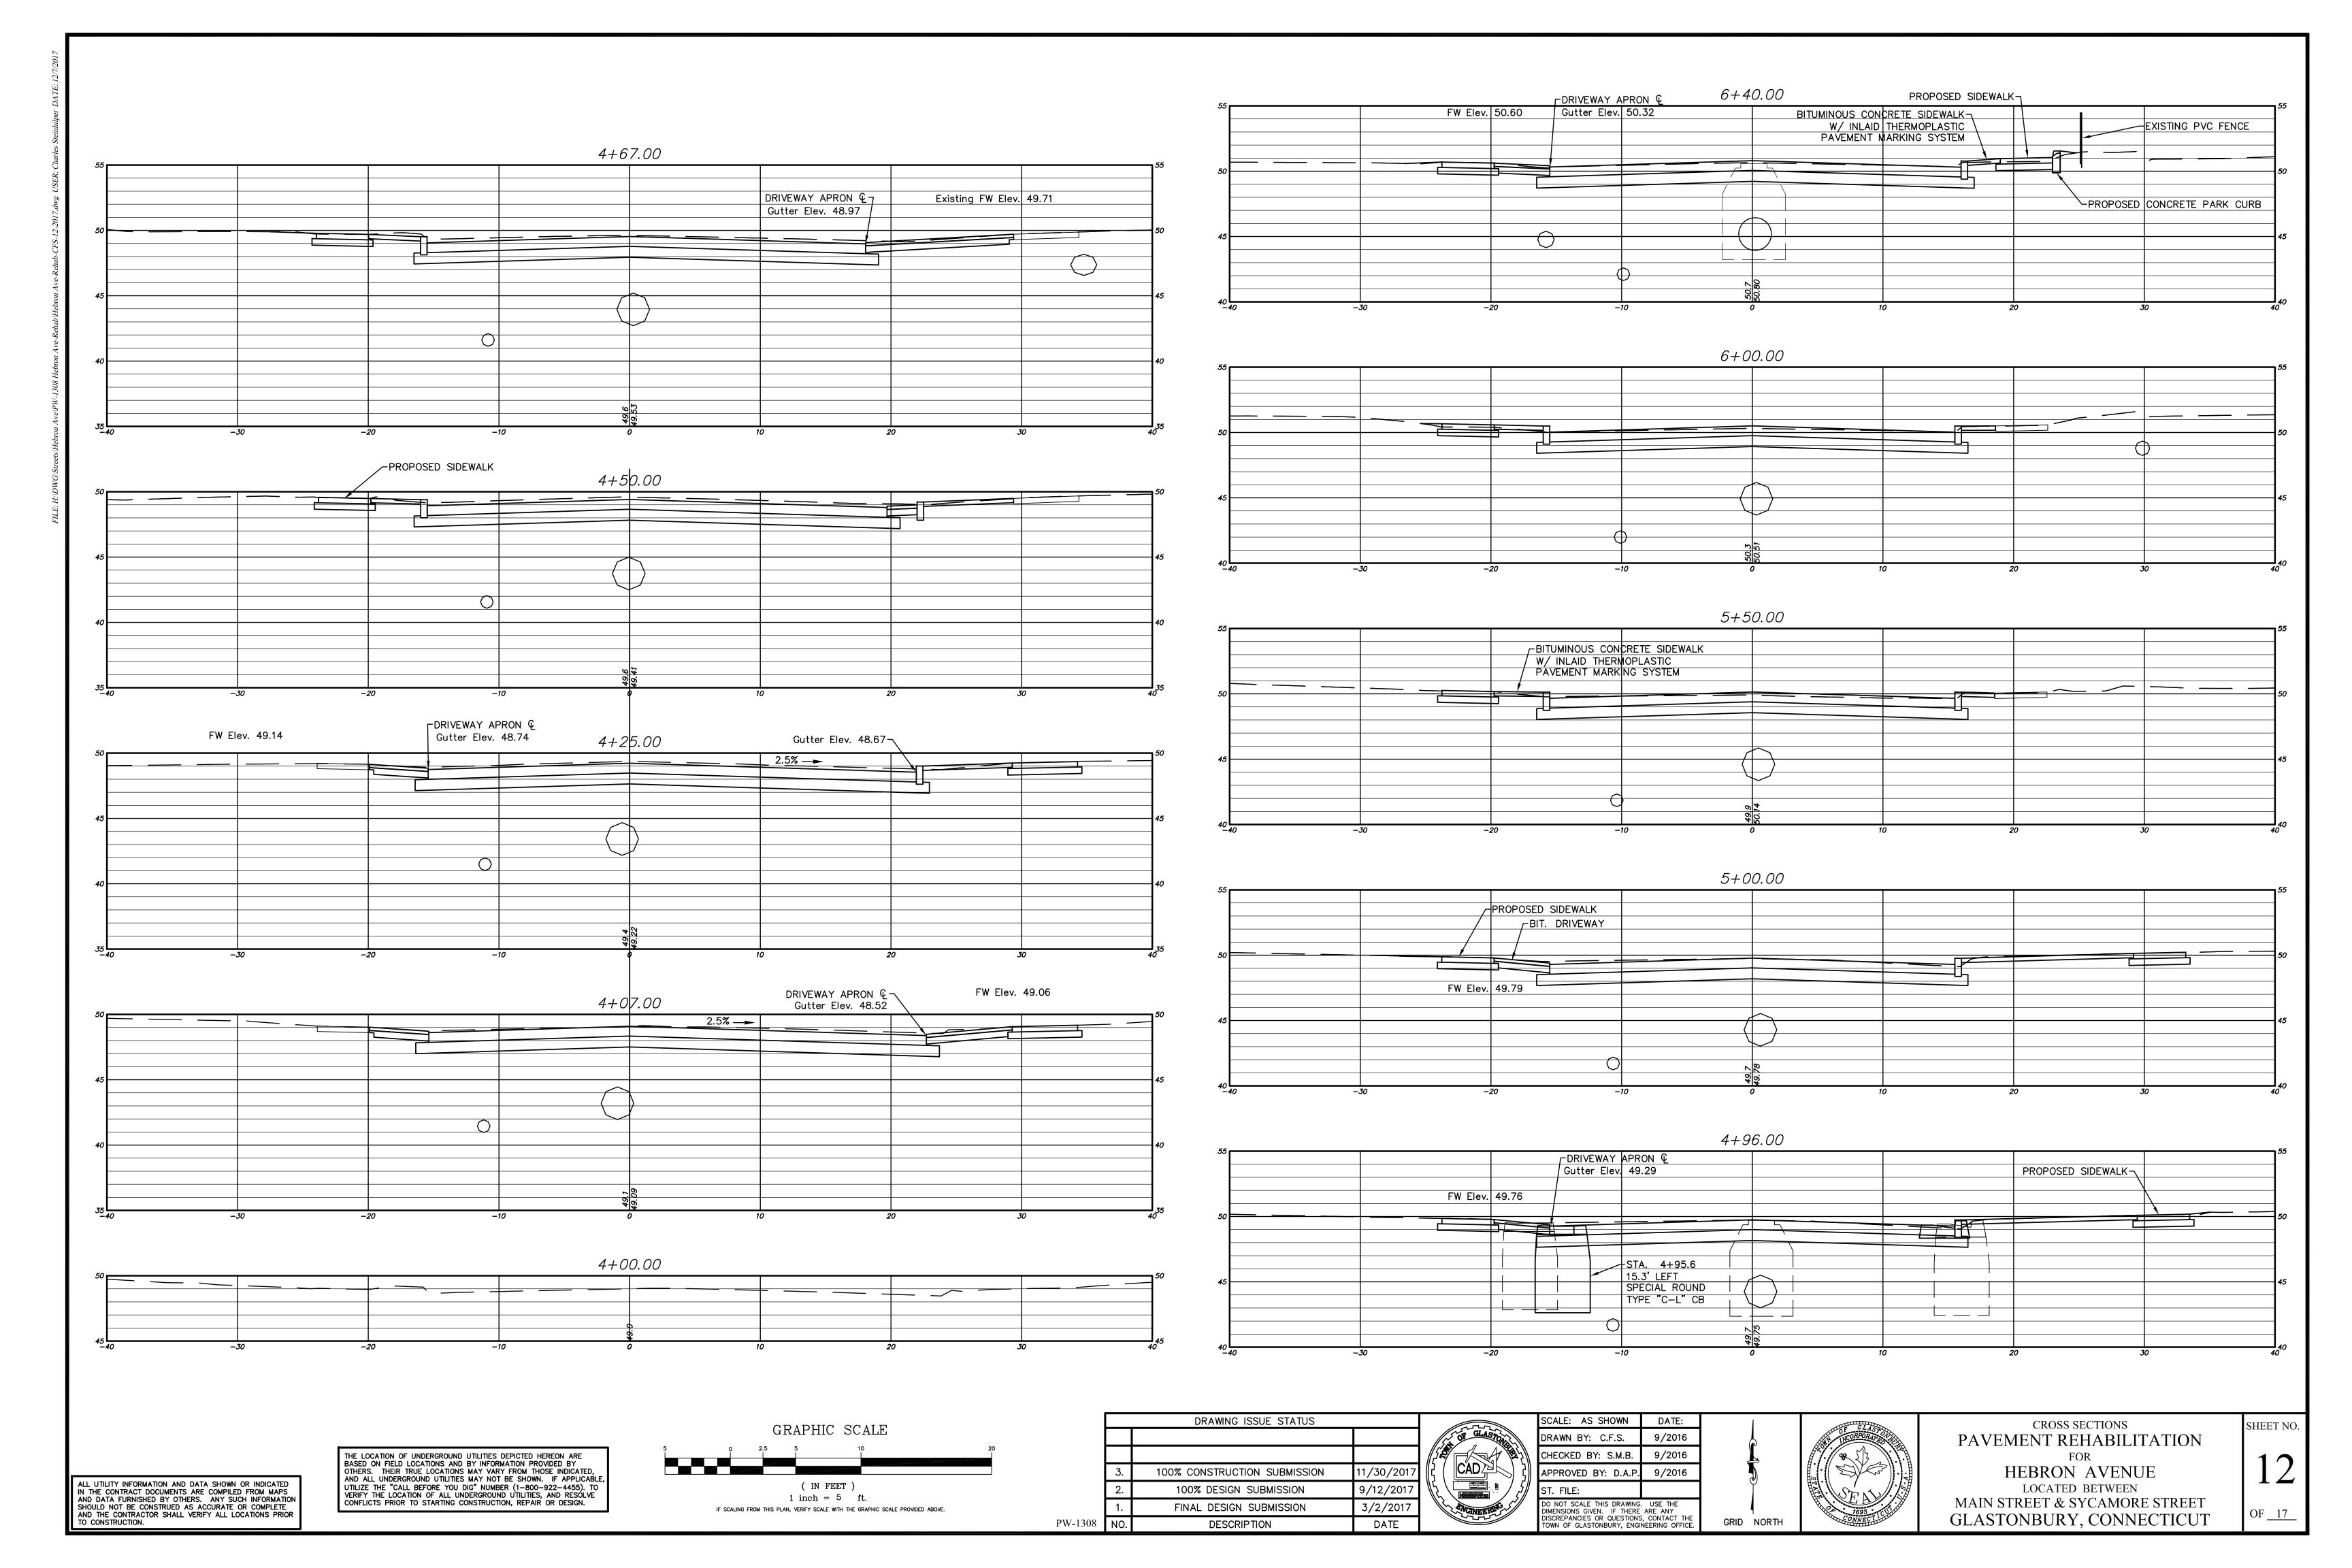


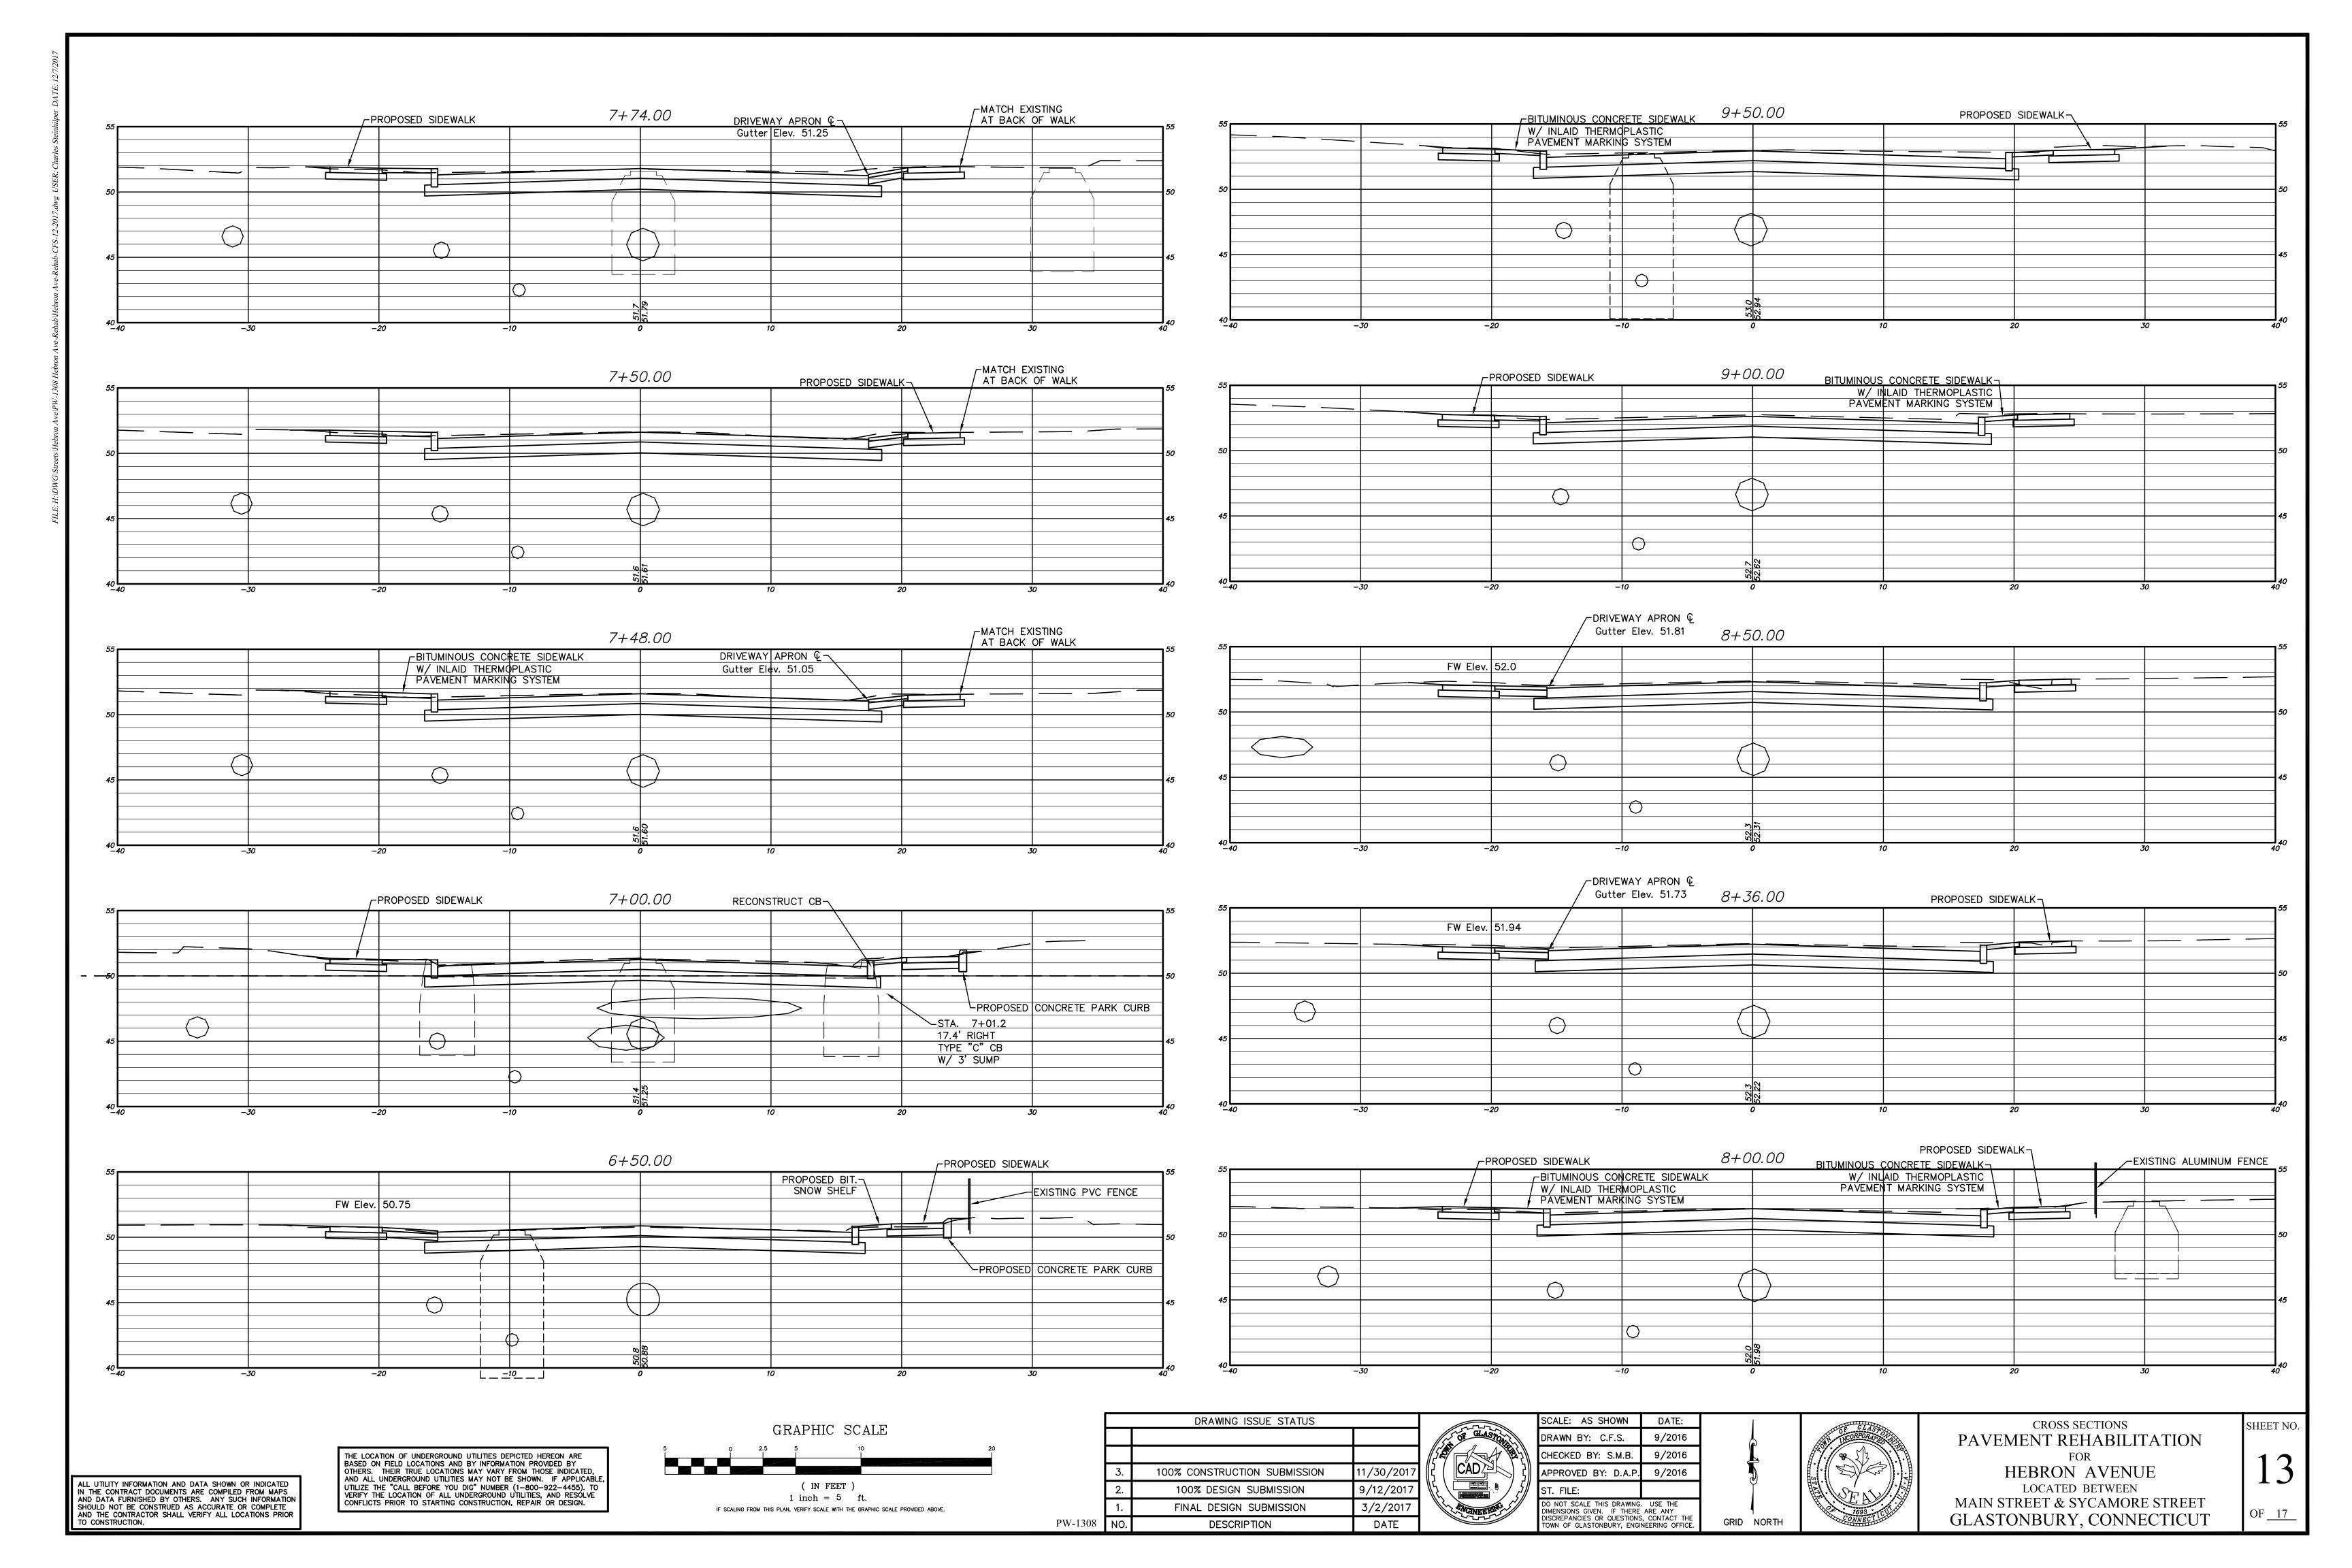

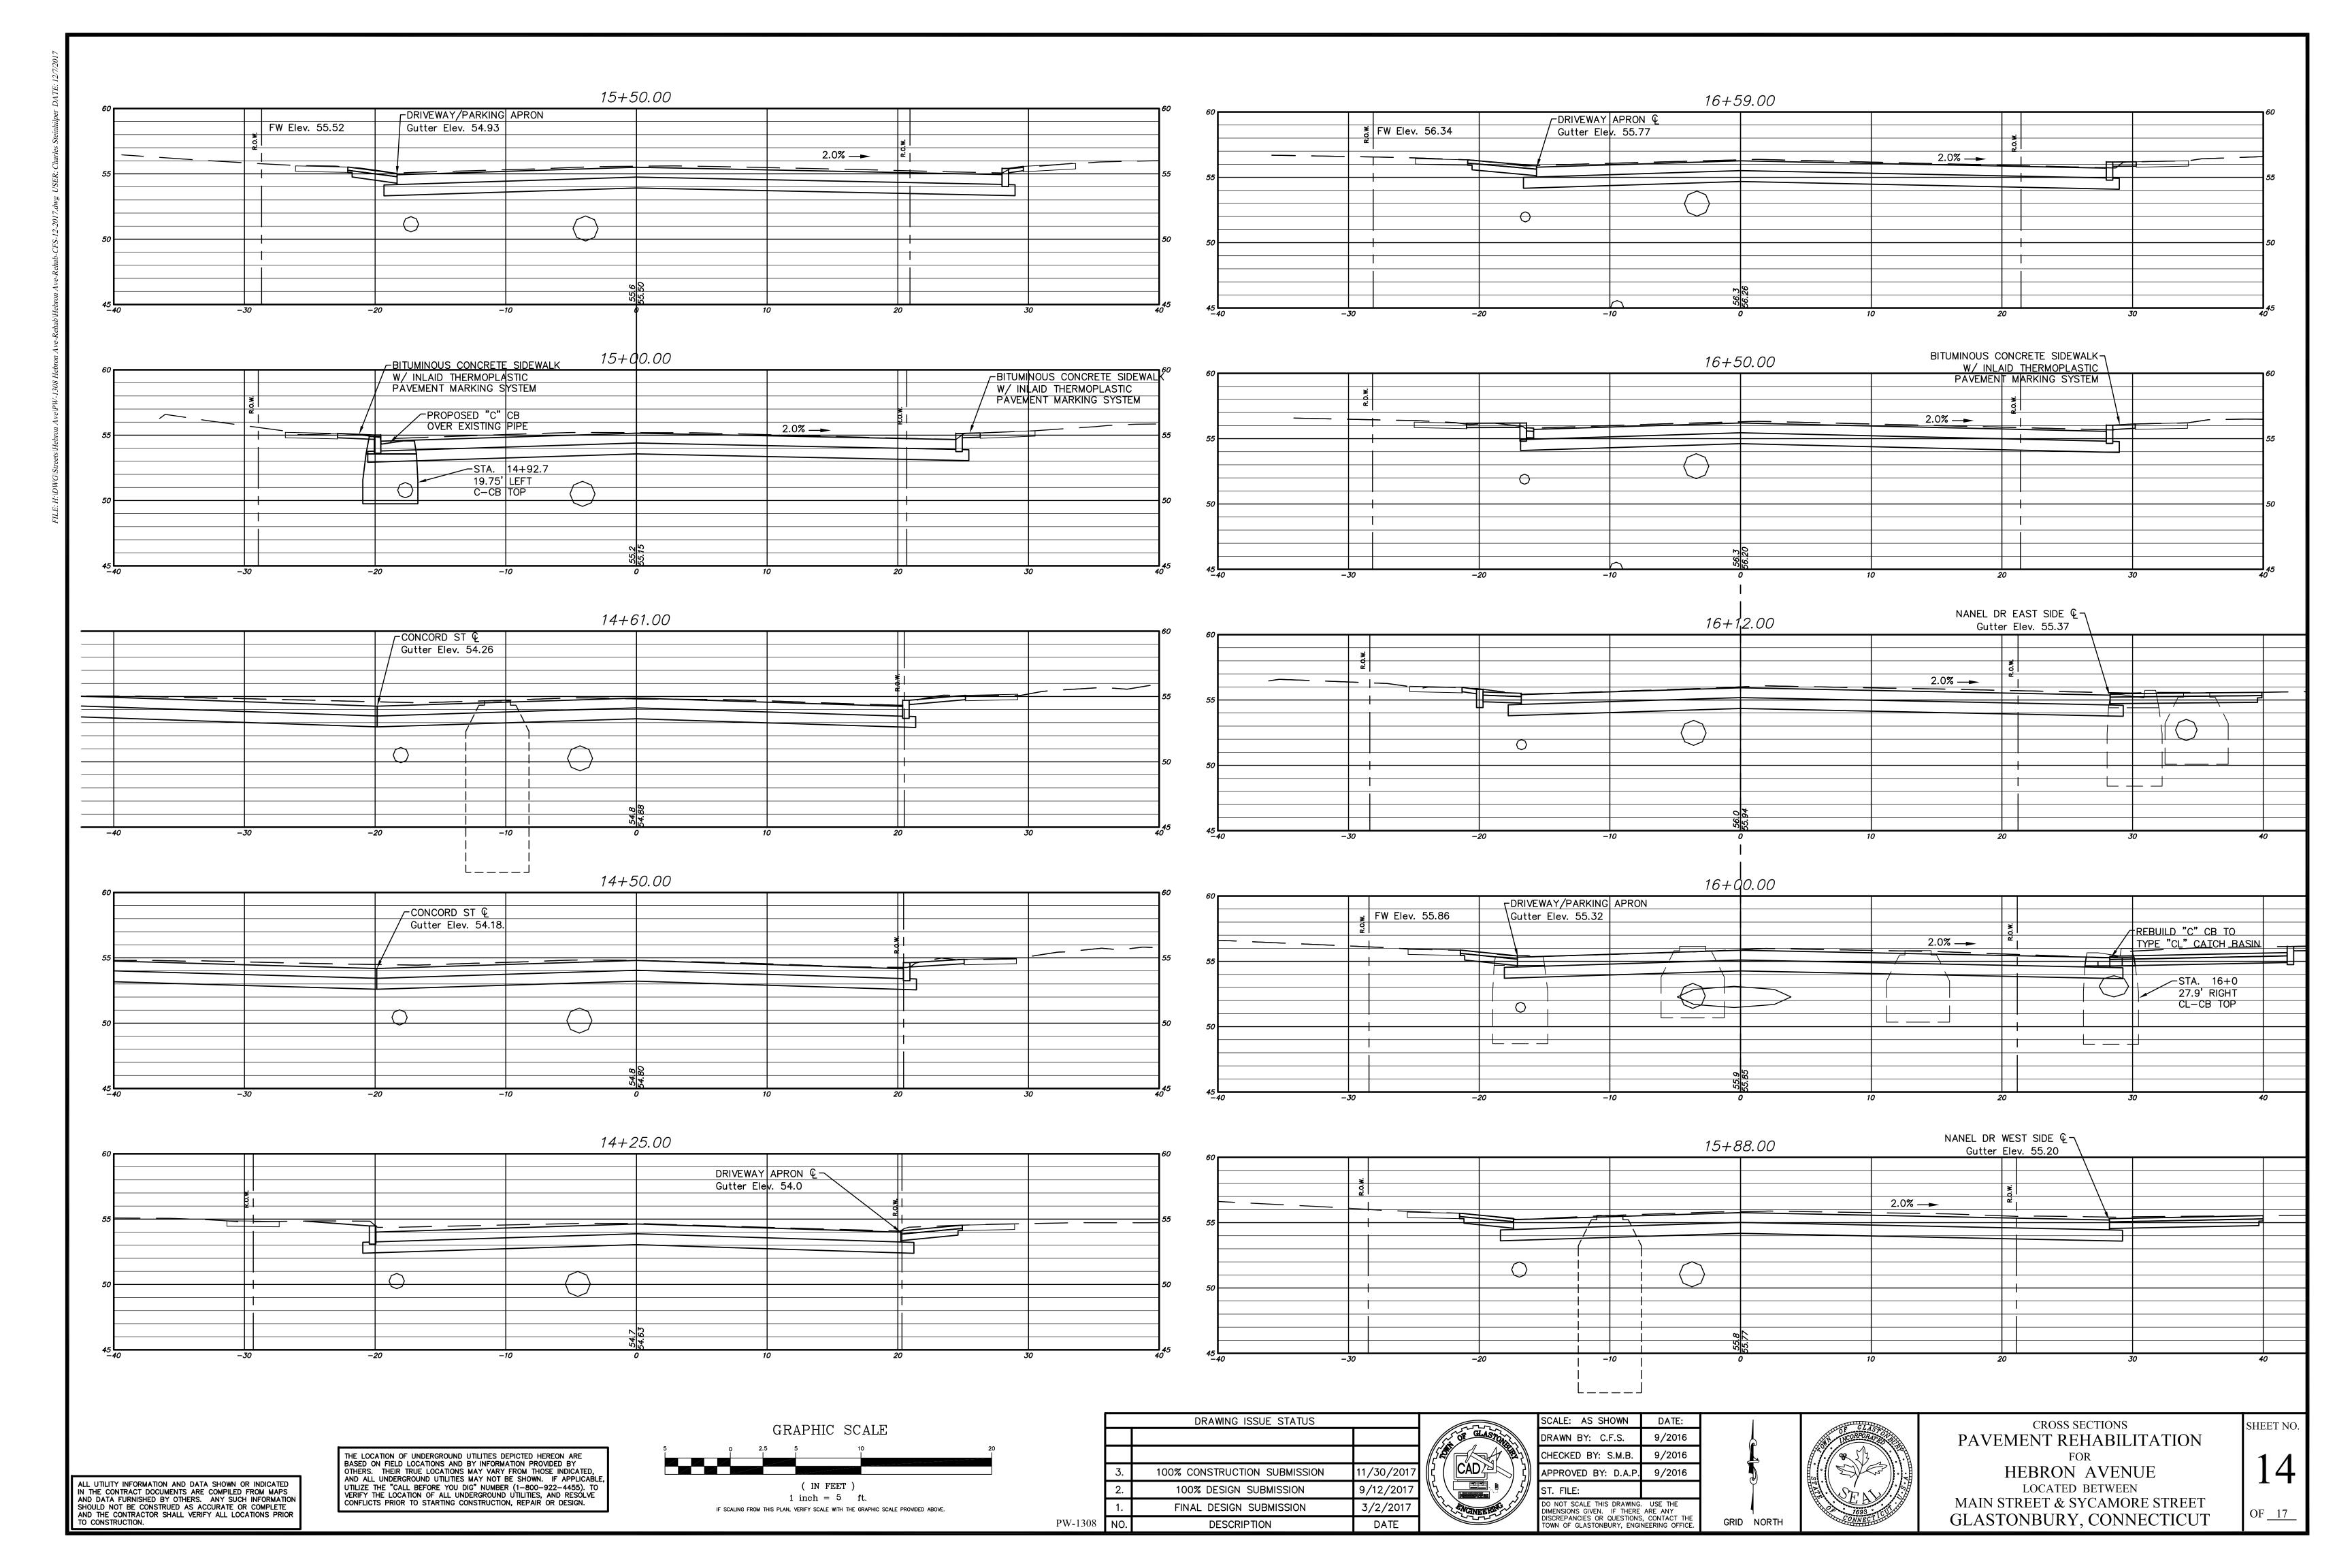

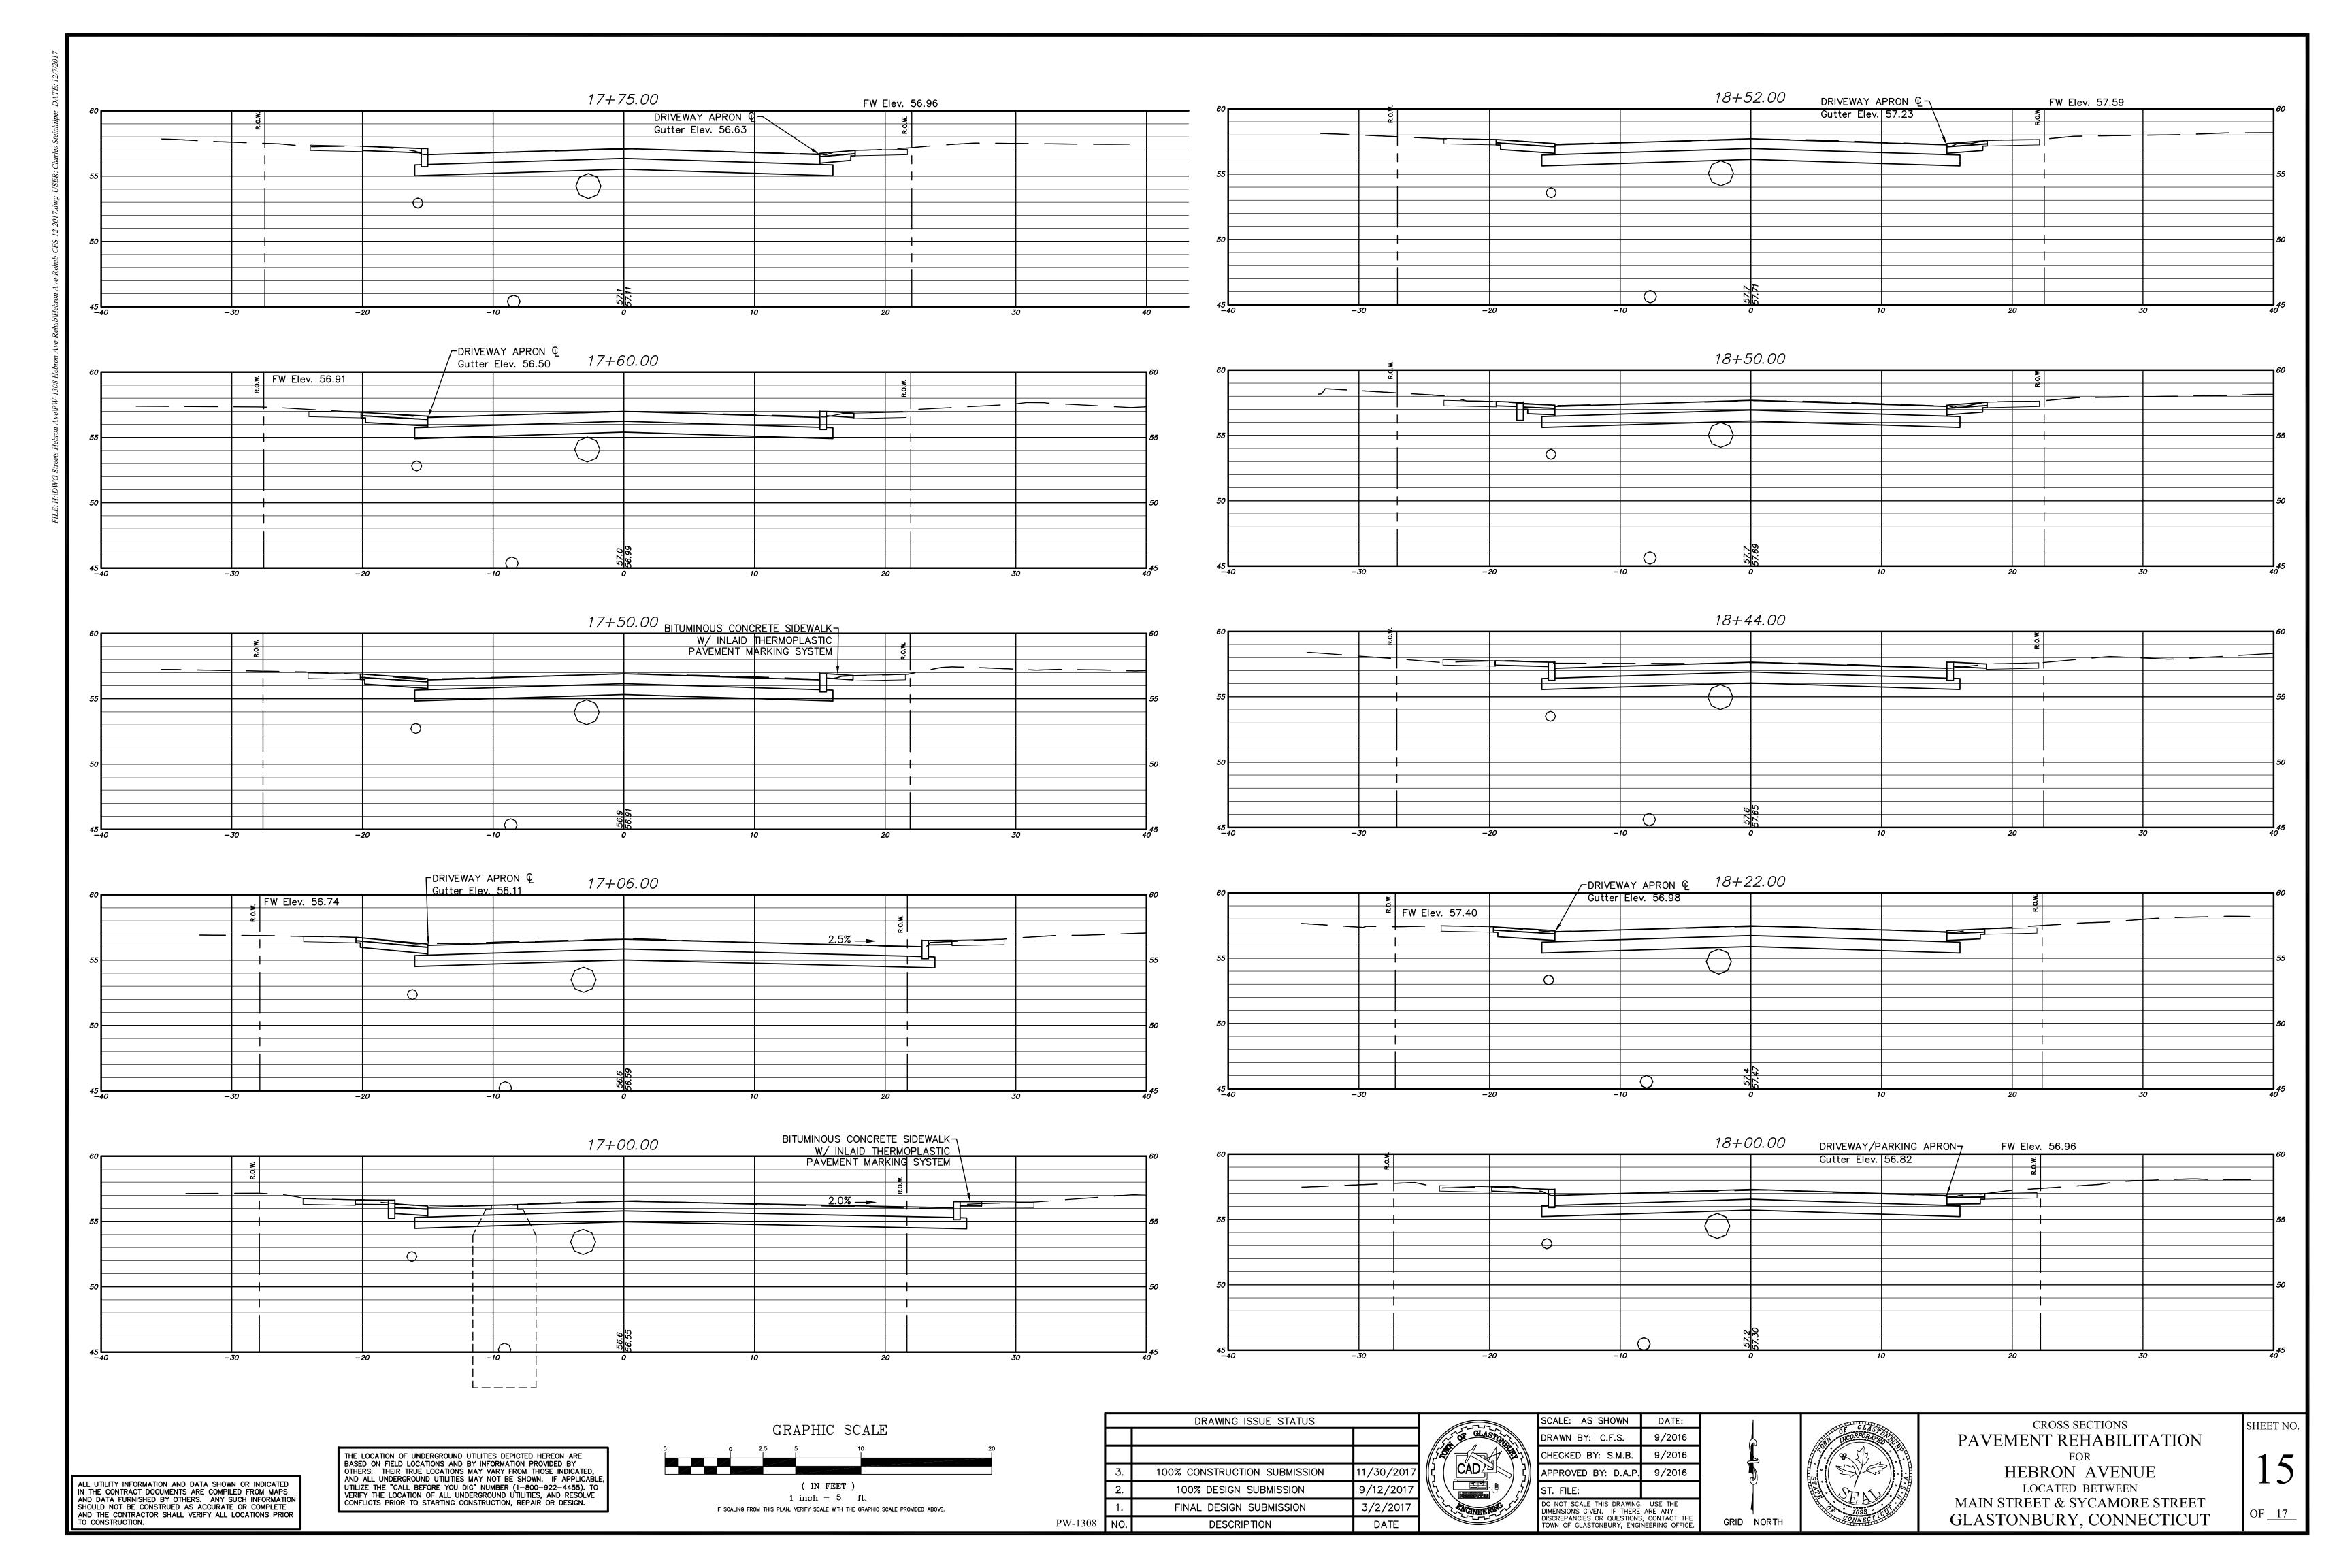

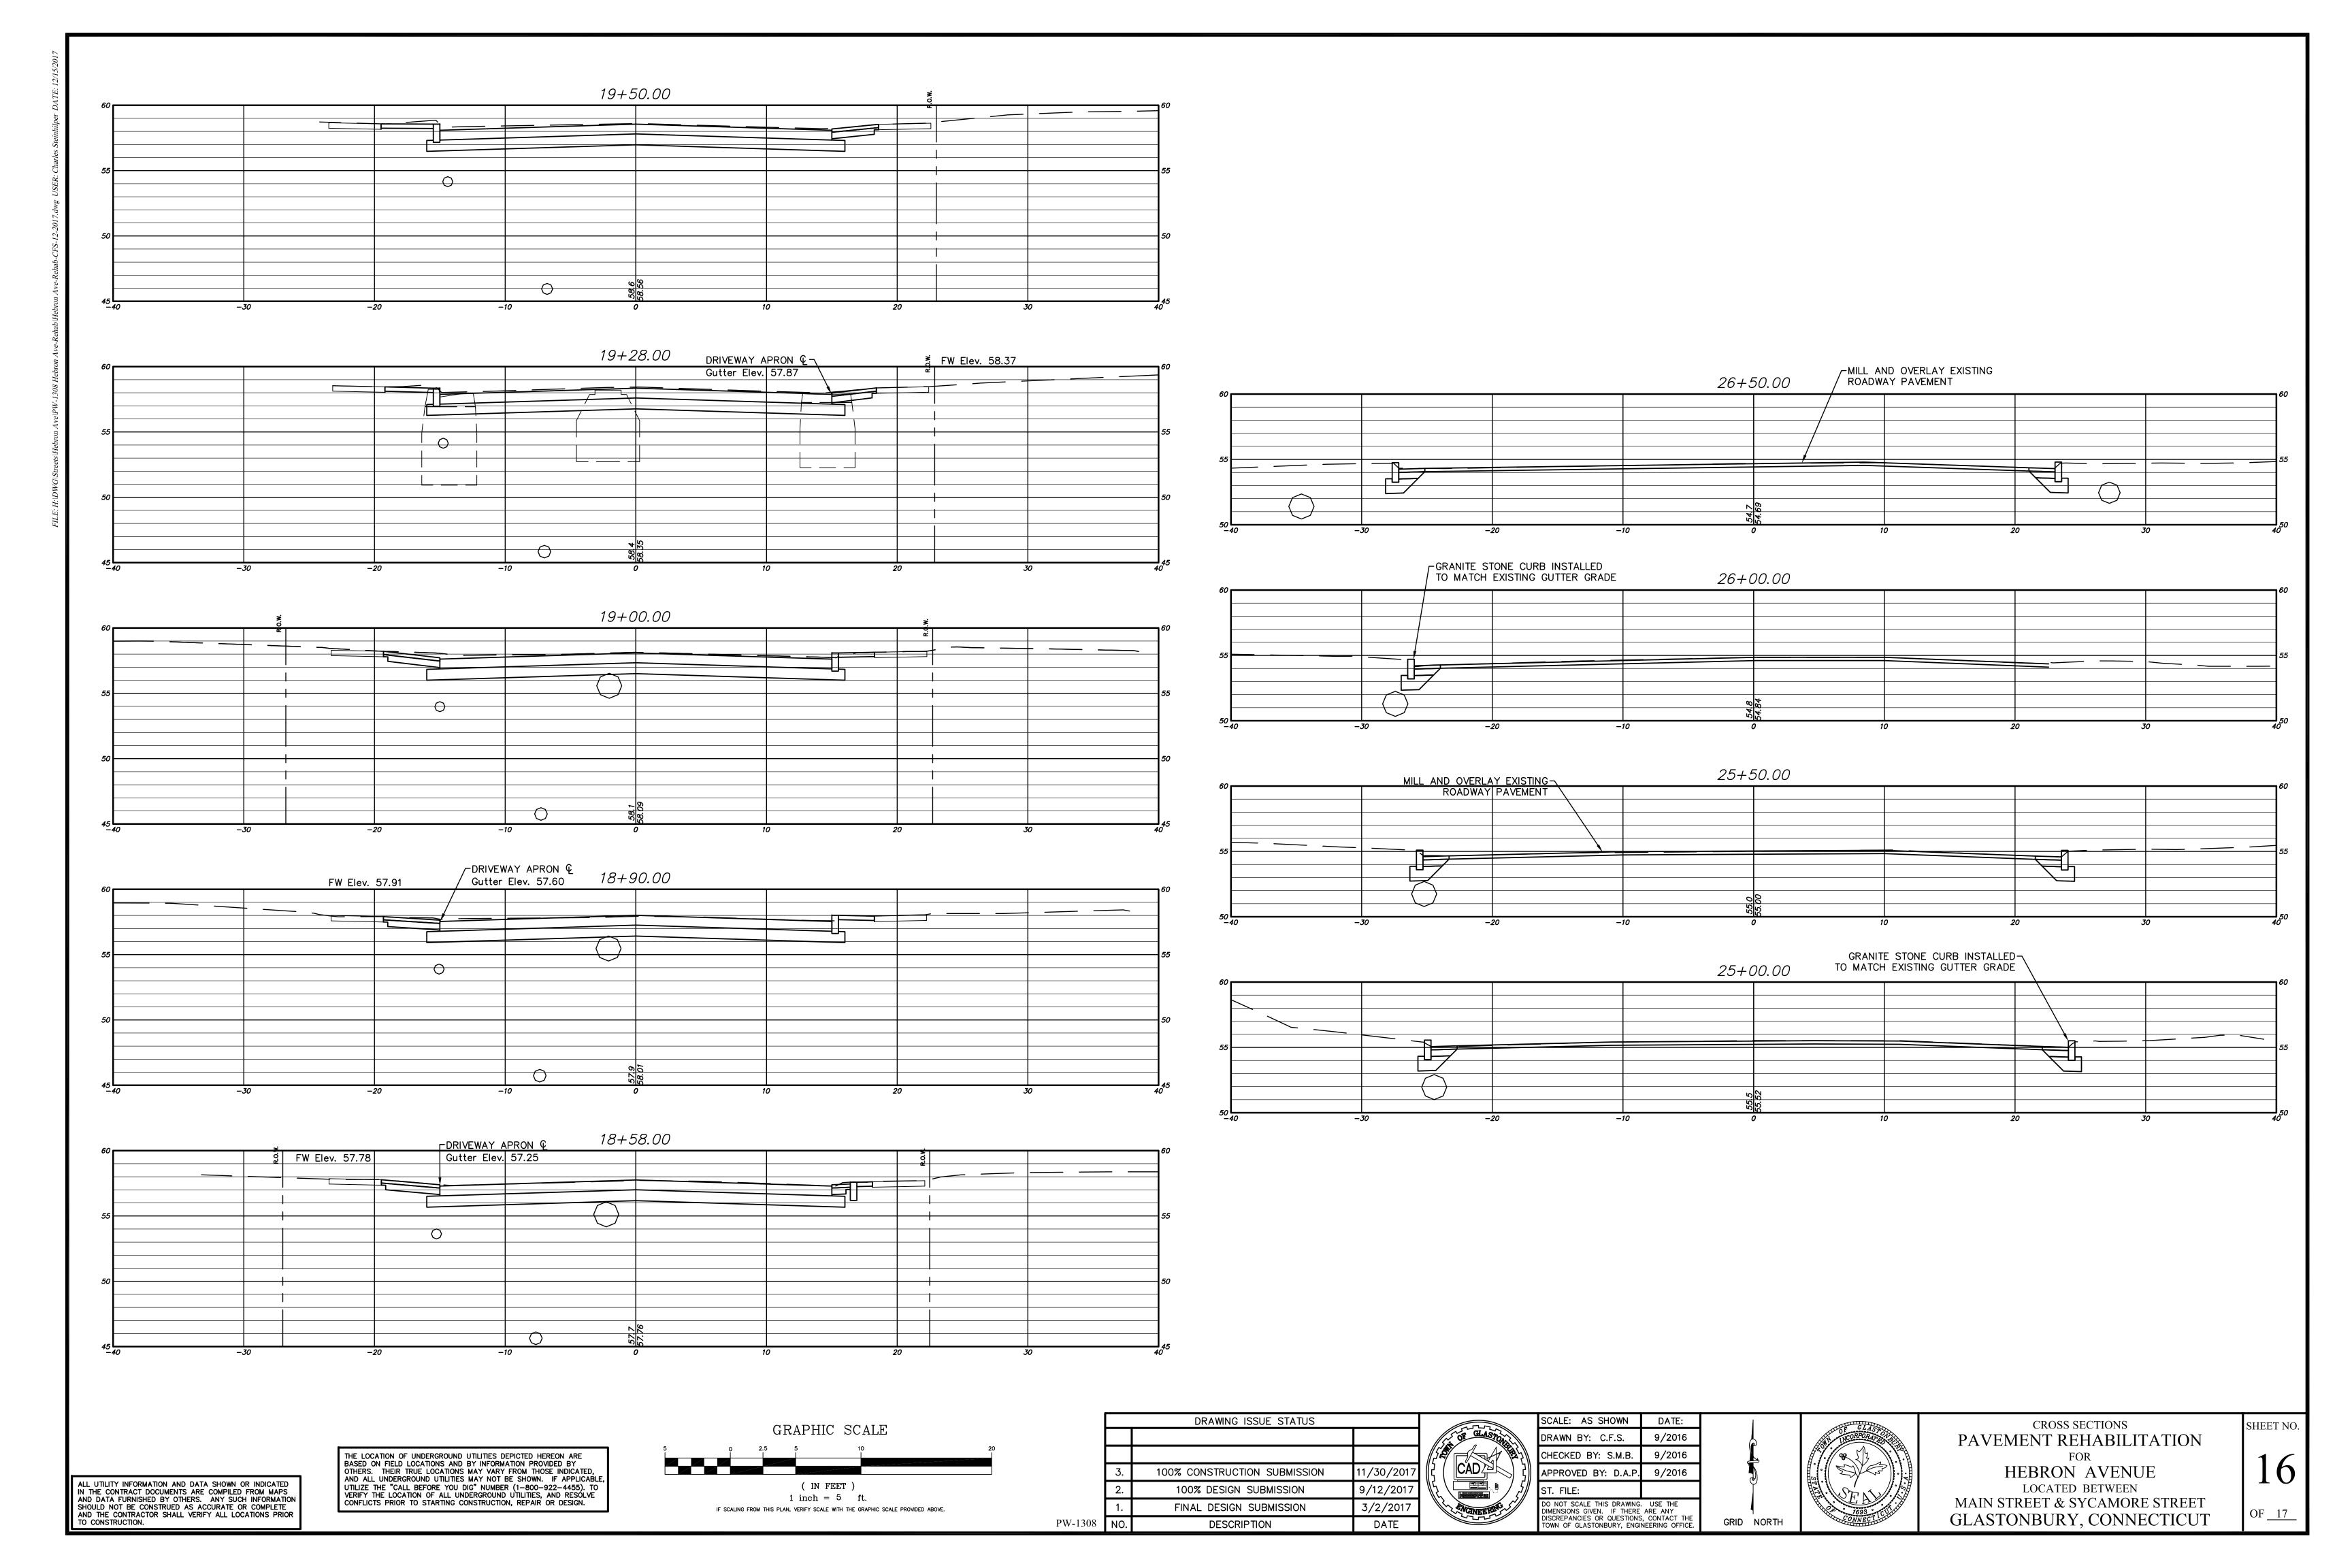

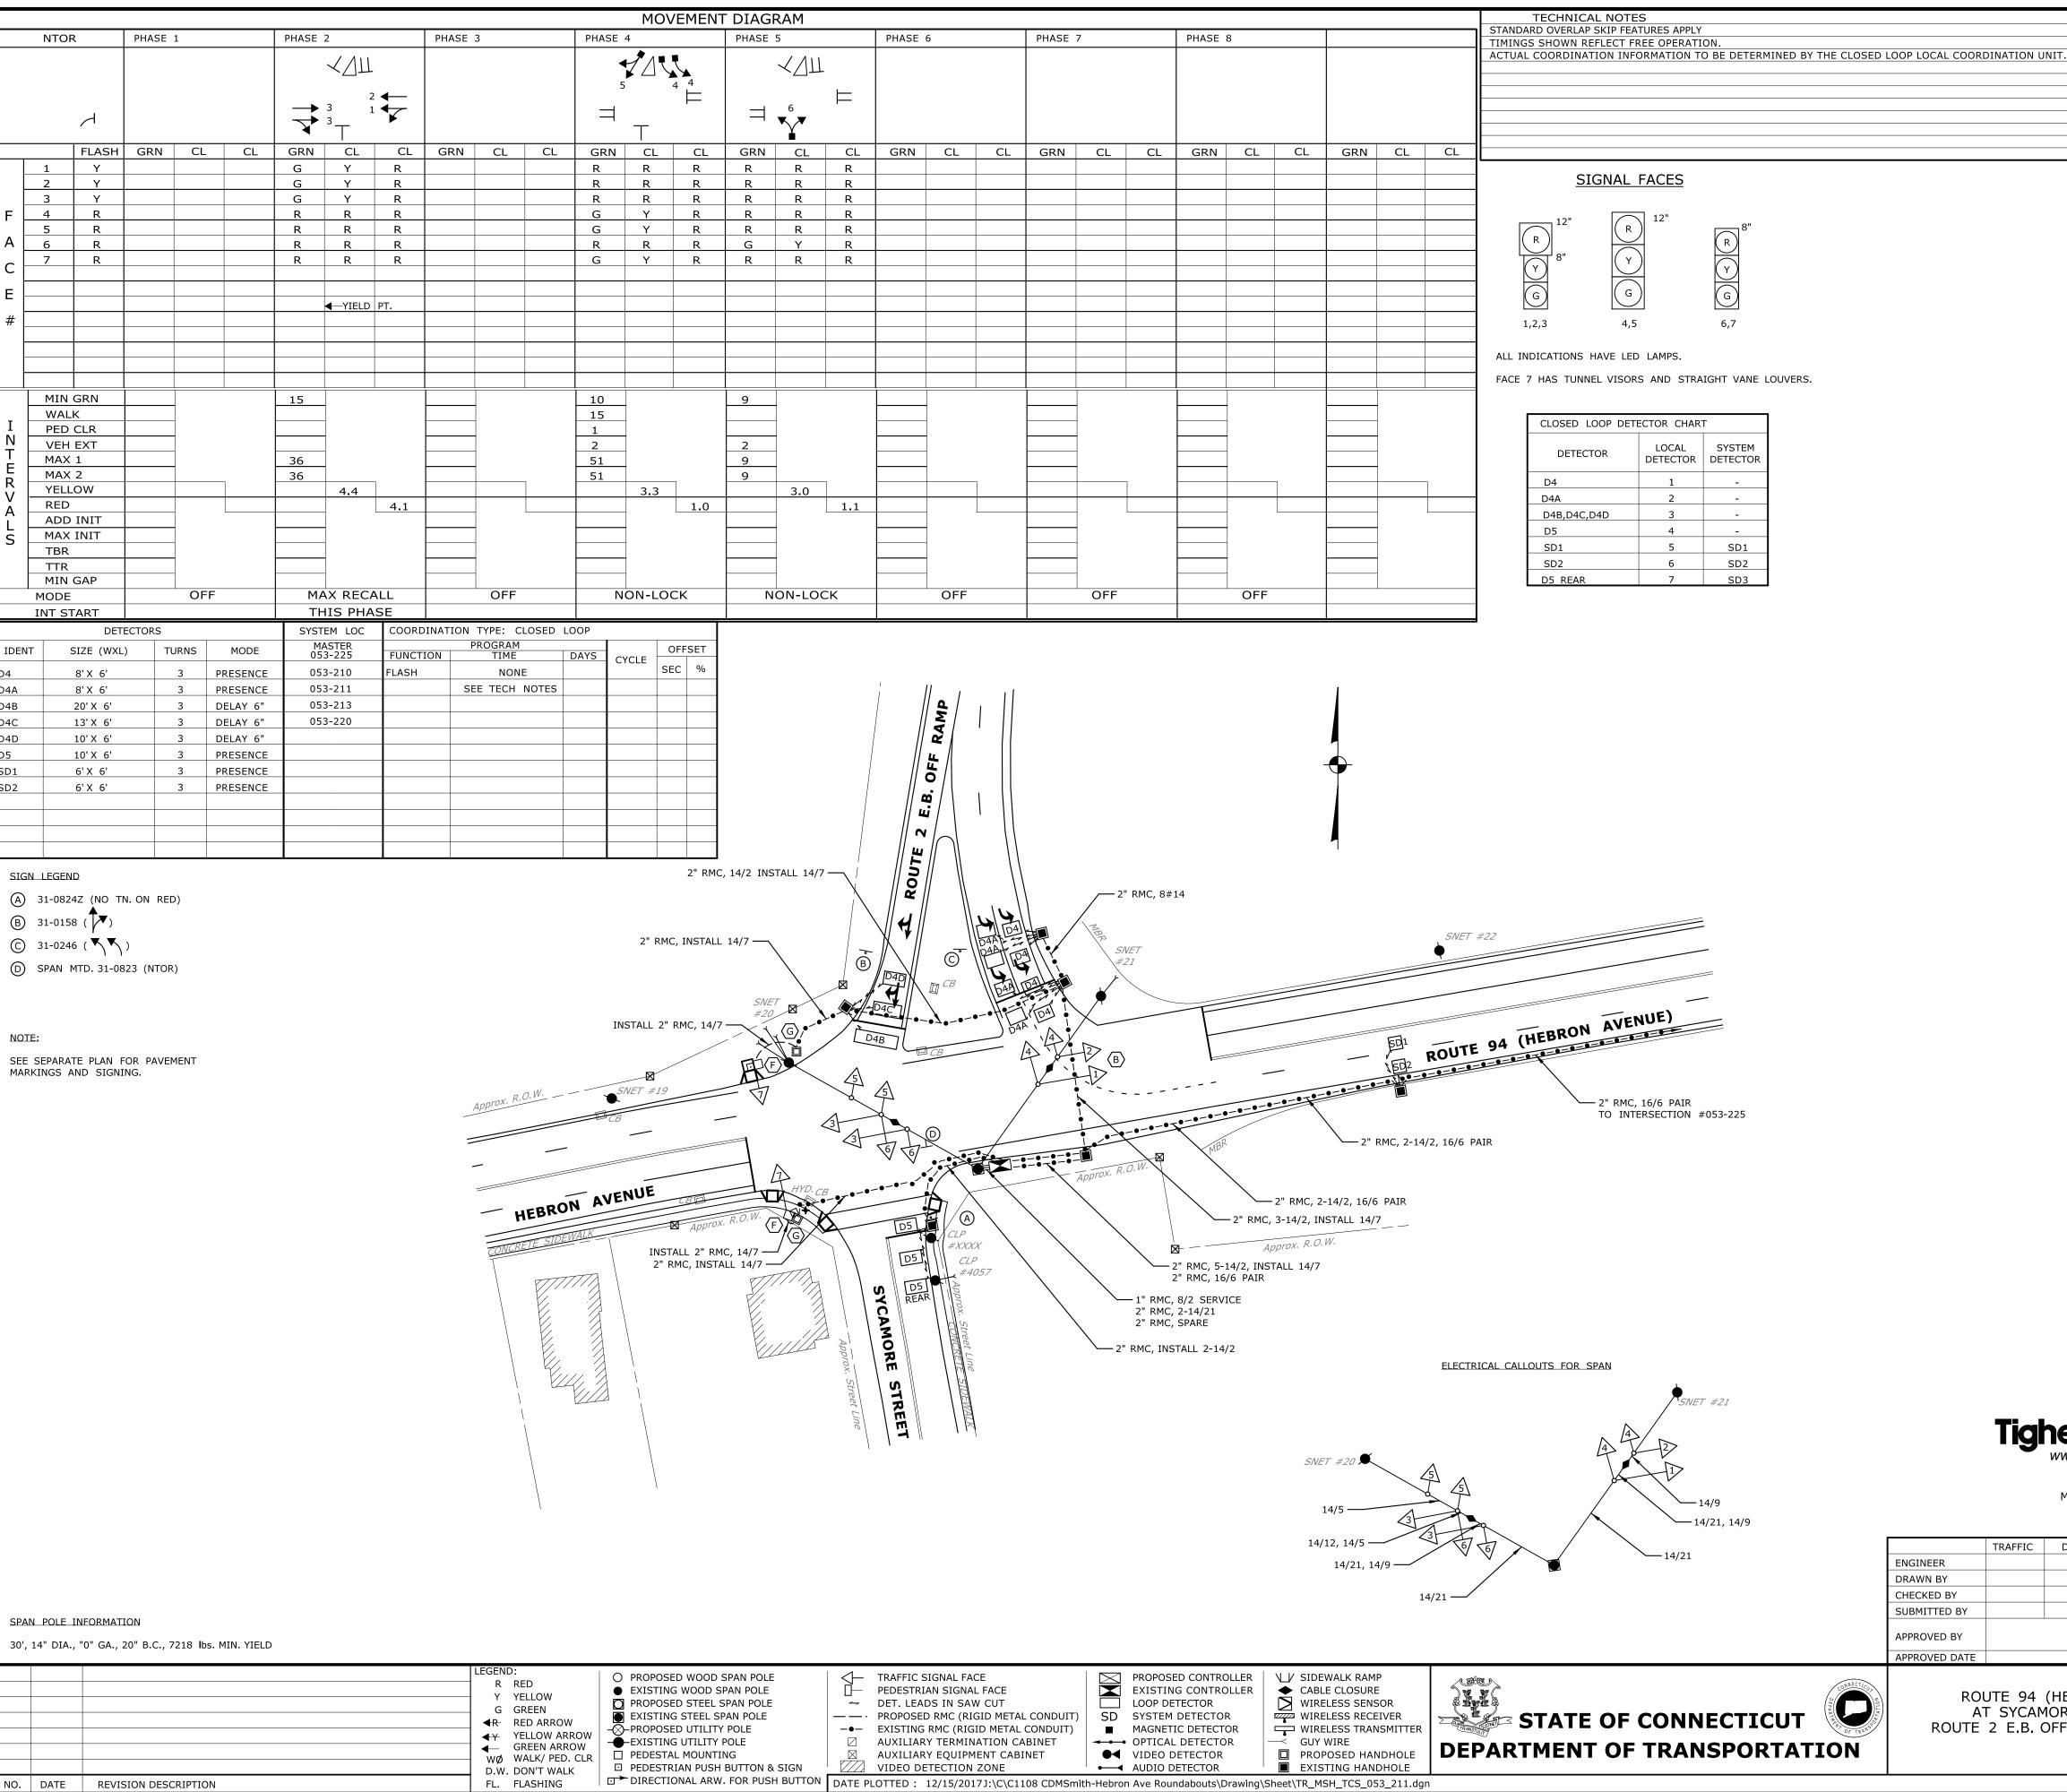

NO. DATE REVISION DESCRIPTION

### CONSTRUCTION NOTES

SM # N/A

TOWN REVISED SIDEWALK, SIDEWALK RAMPS, AND PEDESTAL LOCATIONS UNDER PERMIT

TIR # N/A

REVISED TIMINGS UNDER STATE PROJECT NO. 171-398.

TIR # N/A

ALL TRAFFIC SIGNAL EQUIPMENT IS EXISTING EXCEPT AS NOTED.

CLEAN EXISTING CONDUIT AND HANDHOLES WHERE REQUIRED.

STAKE ALL R.O.W. PRIOR TO EXCAVATION.

ANY PROPOSED REVISIONS TO THE LOCATION OF THE APPURTENANCES SHOWN ON THE PLAN MUST BE SUBMITTED FOR REVIEW AND APPROVAL BY THE DIVISION OF TRAFFIC ENGINEERING PRIOR TO INSTALLATION.

SIGNAL REVISED: 8/24/2017

SIGNAL REVISED

COORDINATE WITH UTILITY COMPANY REPRESENTATIVES LISTED IN THE SPECIAL PROVISION, 1.07 - LEGAL RELATIONS AND RESPONSIBILITIES.

REMOVE ALL ABANDONED TRAFFIC SIGNAL EQUIPMENT PER SPECIAL PROVISION.

COORDINATE THIS REVISION WITH CONNECTICUT D.O.T. SIGNAL LAB CONTACT MR. DONALD ASSARD (860) 258-0346 OR MR. MARK ZAMPINI (860) 258-0349 AT LEAST 14 DAYS PRIOR TO REVISION.

- (F) INSTALL NEW PEDESTAL FOUNDATION ADJACENT TO LANDING AREA. RELOCATE EXISTING PEDESTAL AND 8" SIGNAL HEADS. INSTALL NEW PEDESTRIAN PUSH BUTTON AND SIGN.
- G LOCATE EXISTING RIGID METAL CONDUIT. EXTEND INTO NEW HANDHOLE.

THE LOCATION OF TRAFFIC SIGNAL FOUNDATIONS WHEN IN OR ADJACENT TO SIDEWALKS SHALL BE VERIFIED PRIOR TO INSTALLATION TO PROVIDE A FREE PATH OF NOT LESS THAN 4 FEET, IF A MINIMUM 4 FOOT FREE PATH IS UNAVAILABLE, NOTIFY THE ENGINEER AND CONTACT THE DIVISION OF TRAFFIC ENGINEERING.

MODIFY EXISTING CONTROLLER TO ACCOMMODATE CHANGES. SUPPLY 5 COPIES OF REVISED CABINET WIRING DIAGRAMS.

TEST THE EXISTING LOOP AMPLIFIERS PRIOR TO REPLACING THE LOOPS.

INSTALL LOOP DETECTORS D5 CENTERED IN LANE AND 8'APART UNLESS OTHERWISE SPECIFIED.

SERIES SPLICE SEGMENTED LOOPS PER LANE.

SIDEWALK RAMP TYPES AND LOCATIONS CALLED OUT FOR CONSTRUCTION ON SHEET NO. 10 OF 17 (PLAN & PROFILE PAVEMENT REHABILITATION FOR HEBRON AVENUE).

INSTALL NEW LOOP AMPLIFIER FOR DETECTOR D5 REAR.

213 Court Street Suite 1100 Middletown, CT 06457 (860) 704-4760

	TRAFFIC	DATE	ELECTRICAL	DATE	DEV. #	T.N.T.	DOCCOTION #052 211
ENGINEER					REV #	EV # INTERSECTION #053-2	
DRAWN BY							
CHECKED BY							
SUBMITTED BY					ENERGY BY - TO	WN	ADDRESS #
APPROVED BY					MAINT LEVEL 1		SERVICE POLE - SNET 20
APPROVED DATE							UNMETERED SERVICE
					TOWN:		PROJECT NO.

ROUTE 94 (HEBRON AVE) AT SYCAMORE ST AND ROUTE 2 E.B. OFF RAMP (EXIT 8)

SCALE 1" = 40'

**GLASTONBURY** 

TRAFFIC CONTROL **SIGNAL PLAN** 

DRAWING NO.

SHEET NO.