# THIS PROJECT INCLUDES THE CONSTRUCTION OF APPROXIMATELY 1,000 LINEAR FEET OF NEW FOUR-FOOT-WIDE CONCRETE SIDEWALKS ALONG ADDISON ROAD BETWEEN NORMAN DRIVE AND HEBRON AVENUE, ROUTE 94. THE PROJECT ALSO INCLUDES THE CONSTRUCTION OF RETAINING WALLS AT THREE DIFFERENT LOCATIONS DUE TO STEEP SLOPES ADJACENT TO ADDISON ROAD. TOTAL AREA OF DISTURBANCE IS APPROXIMATELY PROJECT SPECIFIC SEDIMENTATION AND EROSION CONTROL PLAN CONSTRUCTION ACTIVITIES OF CONCERN RELATIVE TO THE PROTECTION OF ADJACENT WETLANDS AND WATERCOURSES FROM SEDIMENTATION ARE AS FOLLOWS: DEWATERING: OPEN TRENCH EXCAVATIONS WILL NEED TO BE DEWATERED AS DISCHARGE USING MEASURES DESCRIBED IN SECTION 5-13 OF THE 2002 CT GUIDELINES FOR EROSION AND SEDIMENT CONTROL. THIS MAY INCLUDE A STONE

- NECESSARY FOR PROPER INSTALLATION OF THE PROPOSED PIPES. IN THESE AREAS, ALL WATER REMOVED FROM THE TRENCH SHALL BE ADEQUATELY TREATED PRIOR TO SUMP AND STANDPIPE FOR PUMP INTAKE PROTECTION. AND A DIRT BAG OR PUMPING
- 2. STOCKPILING: EXCAVATED MATERIAL SHALL NOT BE STOCKPILED ADJACENT TO STORM DRAIN INLETS, WETLANDS, OR WATERCOURSES. WHEN IT IS NECESSARY BASED ON THE PROPOSED METHODS OF CONSTRUCTION TO STAGE EXCAVATED MATERIAL FOR SHORT DURATIONS IN THE VICINITY OF STORM DRAIN INLETS, THESE INLETS SHALL BE PROPERLY PROTECTED AS DESCRIBED ON THE PLANS. LONGER DURATION STOCKPILING OF MATERIAL, WHEN NECESSARY, SHALL BE ONLY IN LOCATIONS APPROVED IN ADVANCE BY THE ENGINEER, AND SUCH STOCKPILES SHALL BE RINGED WITH A SEDIMENTATION CONTROL SYSTEM.

SETTLING BASIN FOR TREATMENT OF THE PUMPED WATER PRIOR TO DISCHARGE.

- 3. DISTURBED AREAS: LIMITS OF DISTURBANCE SHALL BE IN STRICT ACCORDANCE WITH THE APPROVED PLAN. ALL AREAS DISTURBED BY CONSTRUCTION SHALL BE STABILIZED WITH THE FINAL SURFACE TREATMENT AS SOON AS POSSIBLE AFTER CONSTRUCTION ACTIVITIES ARE COMPLETED. DISTURBED AREAS WITH STEEP OR LONG SLOPES AND OTHER AREAS WITH SIGNIFICANT POTENTIAL FOR CAUSING SEDIMENTATION SHALL BE PROTECTED WITH TEMPORARY STRAW MULCH, WOOD CHIPS, EROSION CONTROL MATTING, OR OTHER SUITABLE MATERIALS PRIOR TO SIGNIFICANT FORECASTED RAIN STORM EVENTS TO REDUCE EROSION POTENTIAL.
- SEVERE WEATHER CONTINGENCY PLAN: IN ADVANCE OF A SEVERE WEATHER EVENT, ALL EROSION CONTROLS DESCRIBED ABOVE AND ELSEWHERE ON THE PLANS SHALL BE INSPECTED AND ADJUSTED AS NECESSARY.

### <u>RESPONSIBLE PARTIES:</u>

MICHAEL A & HEIDI

DEPASQUALE

#5 Norman Drive

THE CONTRACTOR SHALL PROVIDE A REPRESENTATIVE WHO IS RESPONSIBLE FOR IMPLEMENTING THE EROSION AND SEDIMENTATION CONTROL PLAN. THIS INCLUDES THE INSTALLATION AND MAINTENANCE OF ALL CONTROL MEASURES, INFORMING ALL PARTIES ENGAGED ON THE CONSTRUCTION SITE OF THE REQUIREMENTS AND OBJECTIVES OF THE

#### GENERAL\_SEDIMENTATION AND EROSION CONTROL REQUIREMENTS:

TURF ESTABLISHMENT

<u>PERMANENT PAVEMENT REPAIR</u>

WALK AND RAMP

REMOVE AND REPLACE CONCRETE

CONCRETE SIDEWALK RAMP

ARNOLD E & LOIS A PEIRI

FAMILY TRUST

#97 Addison Road

STOP SIGN -R1

FABRIC FENCE SYSTEM

SEDIMENTATION CONTROL FILTER

PROTECT MONUMENT

CROSSWALK (BY TOWN

STOP BAR (BY TOWN)

PERMANENT PAVEMENT REPAIR

UTILITY POLE (BY OTHERS)

WITH SILT FENCE.

1' CONCRETE SIDEWALK

ROBERT H SMITH

#100 Addison Road

THESE GUIDELINES SHALL APPLY TO ALL WORK CONSISTING OF ANY AND ALL TEMPORARY AND/OR PERMANENT MEASURES TO CONTROL WATER POLLUTION AND SOIL EROSION AS MAY BE REQUIRED, DURING THE CONSTRUCTION OF THE PROJECT.

IN GENERAL, ALL ACTIVITIES SHALL PROCEED IN SUCH A MANNER SO AS NOT TO POLLUTE ANY WETLANDS. WATERCOURSE, WATERBODY, AND CONDUIT CARRYING WATER, ETC. THE DEPARTMENT OF PHYSICAL SERVICES SHALL LIMIT, INSOFAR AS POSSIBLE, THE SURFACE AREA OF EARTH MATERIALS EXPOSED BY CONSTRUCTION METHODS. AND IMMEDIATELY PROVIDE PERMANENT AND TEMPORARY POLLUTION CONTROL MEASURES TO PREVENT CONTAMINATION OF ADJACENT WETLANDS, WATERCOURSES AND WATERBODIES, AND TO PREVENT, INSOFAR AS POSSIBLE, EROSION ON THE

CONSTRUCTION METHODS, IN GENERAL, SHALL BE IN ACCORDANCE WITH THE PROVISIONS SET FORTH IN THE "GUIDELINES FOR SOIL EROSION AND SEDIMENT CONTROL" (2002) BY THE STATE OF CONNECTICUT COUNCIL ON SOIL AND WATER CONSERVATION.

- 1. ALL CONTROL MEASURES SHALL BE INSTALLED AS NOTED ABOVE AND AS SHOWN ON THE PLANS.
- 2. ALL CONTROL MEASURES SHALL BE INSPECTED AND APPROVED BY THE ENGINEER PRIOR TO COMMENCEMENT OF ANY WORK, INCLUDING PRE-CONSTRUCTION CLEARING AND GRUBBING.
- 3. ALL CONTROL MEASURES SHALL BE MAINTAINED AND UPGRADED AS REQUIRED TO ACHIEVE PROPER SEDIMENT CONTROL THROUGHOUT THE CONSTRUCTION PERIOD AND UNTIL DISTURBED AREAS HAVE BEEN THOROUGHLY
- 4. NO CONTROL MEASURES SHALL BE REMOVED WITHOUT APPROVAL FROM THE ENGINEER.
- 5. ADDITIONAL CONTROL MEASURES SHALL BE INSTALLED DURING THE CONSTRUCTION PERIOD IF DEEMED NECESSARY BY THE ENGINEER.
- 6. THE LIMITS OF CLEARING, GRADING AND DISTURBANCE, AS SHOWN ON THE PLAN(S), SHALL BE KEPT TO A MINIMUM WITHIN THE APPROVED AREA OF CONSTRUCTION. ALL AREAS OUTSIDE THE LIMITS OF CLEARING SHALL
- ANY CONTROL MEASURES RETAINING SEDIMENT OVER 1/2 THEIR HEIGHT SHALL HAVE THE SEDIMENT IMMEDIATELY REMOVED, AND ALL DAMAGED CONTROL MEASURES SHALL BE REMOVED AND REPLACED.
- 8. ALL NEW AND EXISTING CATCH BASINS LOCATED WITHIN THE PROJECT LIMITS SHALL BE PROTECTED WITH A SEDIMENTATION CONTROL SYSTEM IN GRASSED AREAS OR WITH A SEDIMENTATION CONTROL SACK IN PAVED AREAS UNTIL ALL DISTURBED AREAS HAVE BEEN THOROUGHLY STABILIZED.
- 9. SEDIMENT REMOVED FROM CONTROL MEASURES AND DRAINAGE FACILITIES SHALL BE DISPOSED OF IN A MANNER THAT IS CONSISTENT WITH STATE AND LOCAL REGULATIONS.
- 10. THE PLANTING SEASONS FOR THE SPECIFIED SEED MIXTURE SHALL BE AS DEFINED IN THE 2002 CONNECTICUT GUIDELINES FOR SOIL EROSION AND SEDIMENT CONTROL, UNLESS DIRECTED OTHERWISE BY THE TOWN ENVIROMENTAL PLANNER. OUTSIDE OF THESE SPECIFIED DATES, AREAS WILL BE STABILIZED WITH HAYBALE CHECK DAMS, FILTER FABRIC, OR WOODCHIP MULCH AS REQUIRED TO CONTROL EROSION.

LIMITS OF GRADING AND

URF E\$TABLISHMENT

UTILITY POLE (BY OTHERS)

<u>TOCKPILE EXCESS EXCAVATED MATERIA</u> FOR USE BY OWNER OF #97, COORDINATE

QUANTITY WITH OWNER, PROTECT

#### CONSTRUCTION NOTES:

JOHN BRIODY

#90 Addison Road

pprex.\_Street\_Line

HMLTS OF GRADING
TURF ESTABLISHMENT

END SEGMENTAL RETAINING WALL

4" PERFORATED PVC UNDERDRAIN

P.W. 1613

(SITE NO. 1) STATION 2+00

BEGIN BITUMINOUS CONCRETE LIP

CURBING - 6"

WALL (SITE NO.2) STATION 2+60

BEGIN SEGMENTAL RETAINING

REMOVE TREES AND

BRUSH WITHIN R.O.W.

DUBALDO REALTY ADDISON LLC

Lot W6 Addison Road

RELOCATE POLE

(BY OTHERS)

TEST PIT (Typ.

STEVEN B. MCPHEE

#91 Addison Road

1. ALL PROPERTY LINE AND RIGHT OF WAY INFORMATION DEPICTED ON THESE PLANS WERE TAKEN FROM TOWN OF GLASTONBURY ASSESSOR MAPS AND ARE TO BE CONSIDERED APPROXIMATE AND INFORMATIONAL IN NATURE; AND ARE NOT TO BE CONSTRUED AS AN ACCURATE BOUNDARY

2. ALL UTILITY INFORMATION AND DATA SHOWN OR INDICATED IN THE CONTRACT DOCUMENTS ARE

- COMPILED FROM MAPS AND DATA FURNISHED BY OTHERS, ANY SUCH INFORMATION SHOULD NOT BE CONSTRUED AS ACCURATE OR COMPLETE AND THE CONTRACTOR SHALL VERIFY ALL LOCATIONS
- 3. THESE PLANS ARE NOT TO BE USED FOR THE LOCATION OF UNDERGROUND UTILITIES —Call Before You Dig CBYD (1-800-922-4445) A MINIMUM OF TWO WORKING DAYS BEFORE PERFORMING ANY
- 4. ALL TREES NOT IDENTIFIED FOR REMOVAL SHALL BE TRIMMED BY A LICENSED ARBORIST AS REQUIRED TO RAISE THE CANOPY FOR ACCESS BY CONSTRUCTION EQUIPMENT AND PEDESTRIANS. SUCH TREES AND OTHER PLANTINGS ADJACENT TO THE WORK AREA SHALL BE PROTECTED WITH ORANGE CONSTRUCTION FENCE. THIS WORK SHALL BE INCLUDED UNDER ITEM #0201001A CLEARING AND GRUBBING WITHIN THE
- 5. INSTALLATION OF TREE PROTECTION TRENCH AND ADDITIONAL HAND PRUNING OF ROOTS DISTURBED DURING EXCAVATION SHALL BE PREFORMED BY A CT LICENSED
- 6. INSTALL SILT SACKS IN CATCH BASINS ADJACENT TO WORK AREA FOR PROTECTION OF INLETS FROM SEDIMENTATION.
- 7. PAVEMENT MARKINGS ARE NOT INCLUDED IN THIS CONTRACT.
- 8. THE CONTRACTOR IS RESPONSIBLE FOR MAINTENANCE AND PROTECTION OF TRAFFIC PER THE SPECIFICATIONS. IF MUNICIPAL POLICE OFFICERS ARE REQUIRED, THE TOWN OF GLASTONBURY WILL PROVIDE A DIRECT PAYMENT FOR THIS COST.
- 9. THE CONTRACTOR IS RESPONSIBLE TO SECURE ALL WORK AREAS AT THE END OF EACH DAY THROUGH OUT THE DURATION OF THIS PROJECT.
- 10. CONTRACTOR IS REQUIRED TO PROVIDE VEHICLE/PEDESTRIAN ACCESS TO ALL EXISTING DRIVEWAYS AT ALL TIMES THROUGH OUT DURATION OF THIS PROJECT.
- 11. CONTRACTOR IS RESPONSIBLE FOR COORDINATION OF DAILY CONSTRUCTION ACTIVITIES WITH ALL ABUTTING PROPERTY OWNERS AND LOCAL BUSINESSES.
- 12. CONTRACTOR IS RESPONSIBLE TO ADHERE TO ALL CONDITIONS OUTLINED WITHIN THE CONNECTICUT DEPARTMENT OF TRANSPORTATION ENCROACHMENT PERMIT HELD BY THE TOWN OF GLASTONBURY.

ADJUST

ADJUST GAS SERVICE


F.=106.54


DUBALDO/REALT

#77-81 /Addison Rog

<u> 1" SOLID PVC</u>

ADDISON LLC

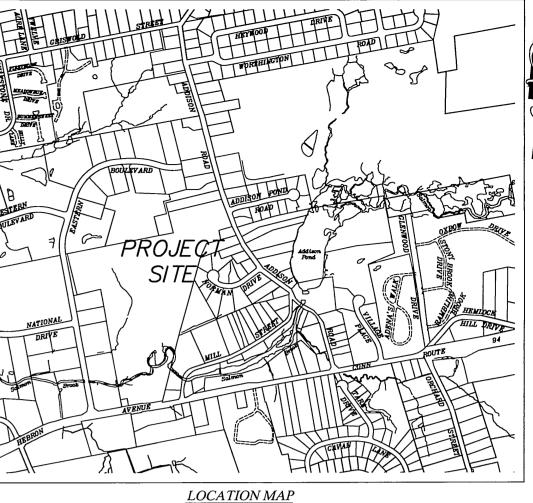

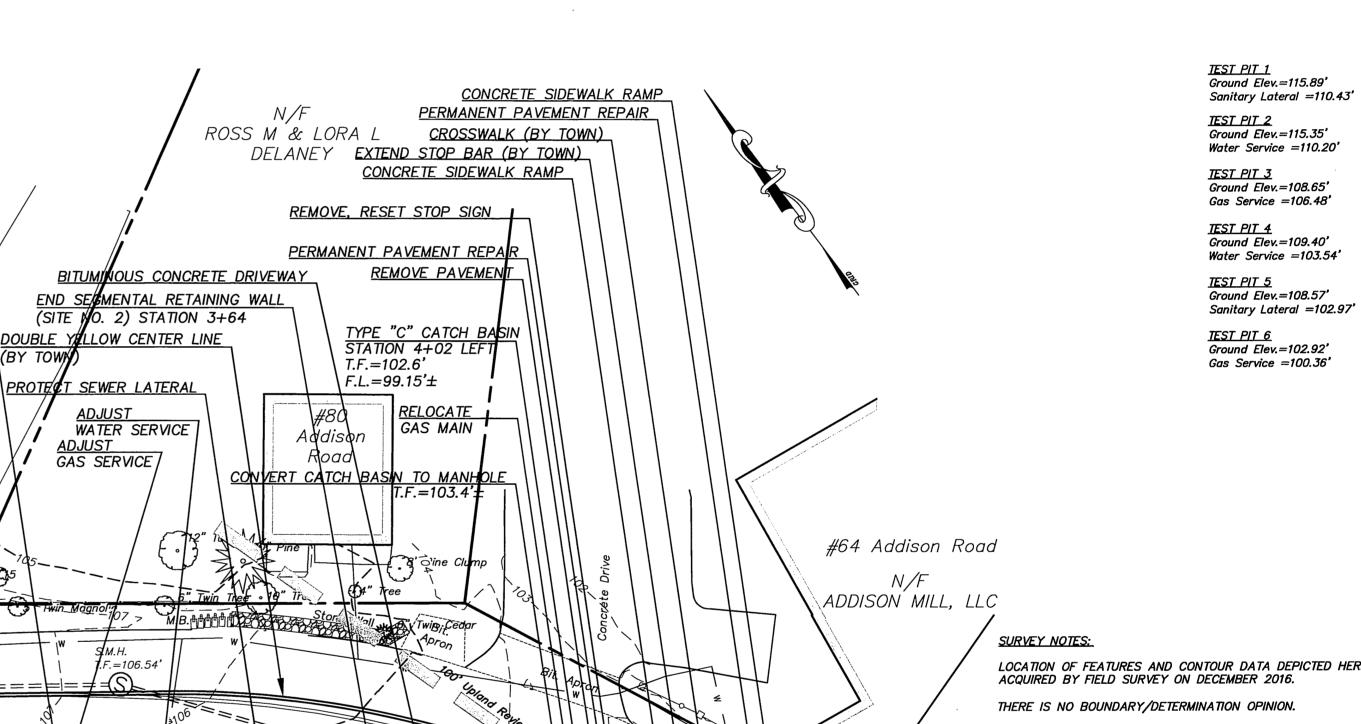

OCATION OF FEATURES AND CONTOUR DATA DEPICTED HEREON WERE

NOT ALL IMPROVEMENTS ARE DEPICTED HEREON.

HORIZONTAL CONTROL IS BASED ON THE CONNECTICUT GEODETIC SURVEY STATE PLANE COORDINATES, NORTH AMERICAN DATUM OF 1983 - (NAD83). ELEVATIONS AND VERTICAL CONTROL IS BASED ON THE NORTH AMERICAN VERTICAL DATUM 1988 - (NAVD88).

THIS PLAN WAS COMPILED FROM OTHER MAPS, RECORD RESEARCH OR OTHER SOURCES OF INFORMATION. IT IS NOT TO BE CONSTRUED AS HAVING BEEN OBTAINED AS THE RESULT OF A FIELD SURVEY, AND IS SUBJECT TO SUCH CHANGE AS AN ACCURATE FIELD SURVEY MAY DISCLOSE.

PROPERTY LINE LOCATIONS DEPICTED HEREON ARE THE RESULT OF RECORD RESEARCH AND LIMITED FIELD MEASUREMENTS AND ARE NOT INTENDED TO BE USED FOR CONVEYANCE PURPOSES, IT DOES NOT PRESENT A PROPERTY/BOUNDARY OPINION.

## REFERENCE IS MADE TO THE FOLLOWING MAPS ENTITLED:

- "PLAN MADE FOR THE GLASTONBURY KNITTING CO. LOCATED AT ADDISON, TOWN OF GLASTONBURY, CONN. SCALE: 1INCH = 50FEET. BY CHANDLER & PALMER, ENGRS. NORWICH, CONN. JULY 1935" MAP IS ON FILE IN THE GLASTONBURY LAND RECORDS AS MAP NUMBER 2635A.
- "PROPERTY OF J.B. WILLIAMS CO. ADDISON. CONN. MARCH 11, 1942 SCALE 1"=40' JOHN T. HENDERSON CONSULTING ENGINEERS HARTFORD CONN." MAP IS ON FILE IN THE GLASTONBURY LAND RECORDS AS MAP
- 3. "CERTIFICATION PLAN #64 ADDISON ROAD PREPARED FOR 64 ADDISON ROAD ASSOCIATES, LLC GLASTONBURY, CONN. MEGSON & HEAGLE CIVIL ENGINEERS & LAND SURVEYORS, LLC 81 RANKIN ROAD GLASTONBURY, CONN 06033 Phone (860)-659-0587 CK. BY. JLH DRW. BY. JHS DATE 9-28-05 SCALE: 1"=20' SHEET 1 OF 1 MAP NO. 109-03-1LF" MAP IS
- P. "SITE, GRADING AND UTILITY PLAN PROPOSED OFFICE BUILDING ADDISON ROAD & HEBRON AVENUE GLASTONBURY CONNECTICUT CLOSE, JENSON & MILLER CONSULTING ENGINEERS, LAND PLANNERS & SURVEYORS 1137 SILAS DEANE HIGHWAY WETHERSFIELD, CONNECTICUT 06109 DESIGNED KRJ DRAWN KRJ CHECKED DES SCALE 1"=20' DATE DEC. 1987 SHEET NO. 1 OF 3" MAP IS ON FILE IN THE GLASTONBURY LAND RECORDS AS MAP NUMBER 5003.


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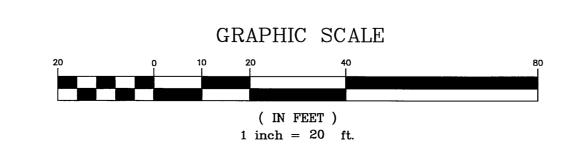
ON FILE IN THE GLASTONBURY LAND RECORDS AS MAP NUMBER 7012.

**PLAN DEPICTING** 

PROPOSED SIDEWALKS ADDISON ROAD

GLASTONBURY, CONNECTICUT



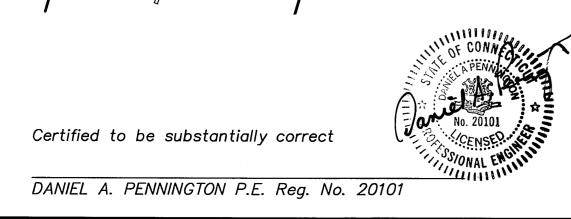

CONCRETE SIDEWALK

<u>BITUMINOUS CONCRETE DRIVEWAY</u>

BEGIN SECMENTAL RETAINING WALL (SITE NO. 1) STATION 0+70

APPROX! LIMITS OF GRADING, RIGHT TO GRADE REQUIRED


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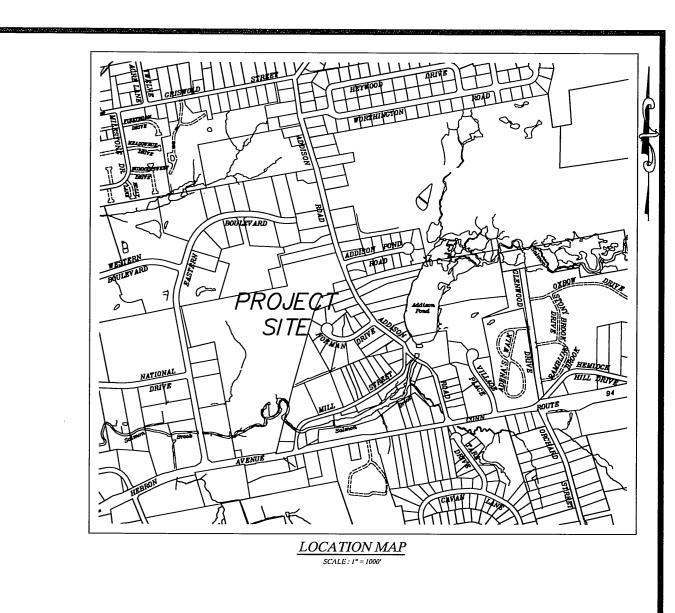
/ Elev.=105.31'


CHECKED BY: S.M.B. 8-21-2017 APPROVED BY: D.A.P. 8—21—2017 **DESCRIPTION** 


DRAWN BY: S.Troy 8-21-201


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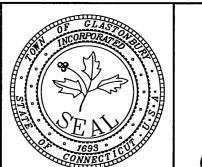




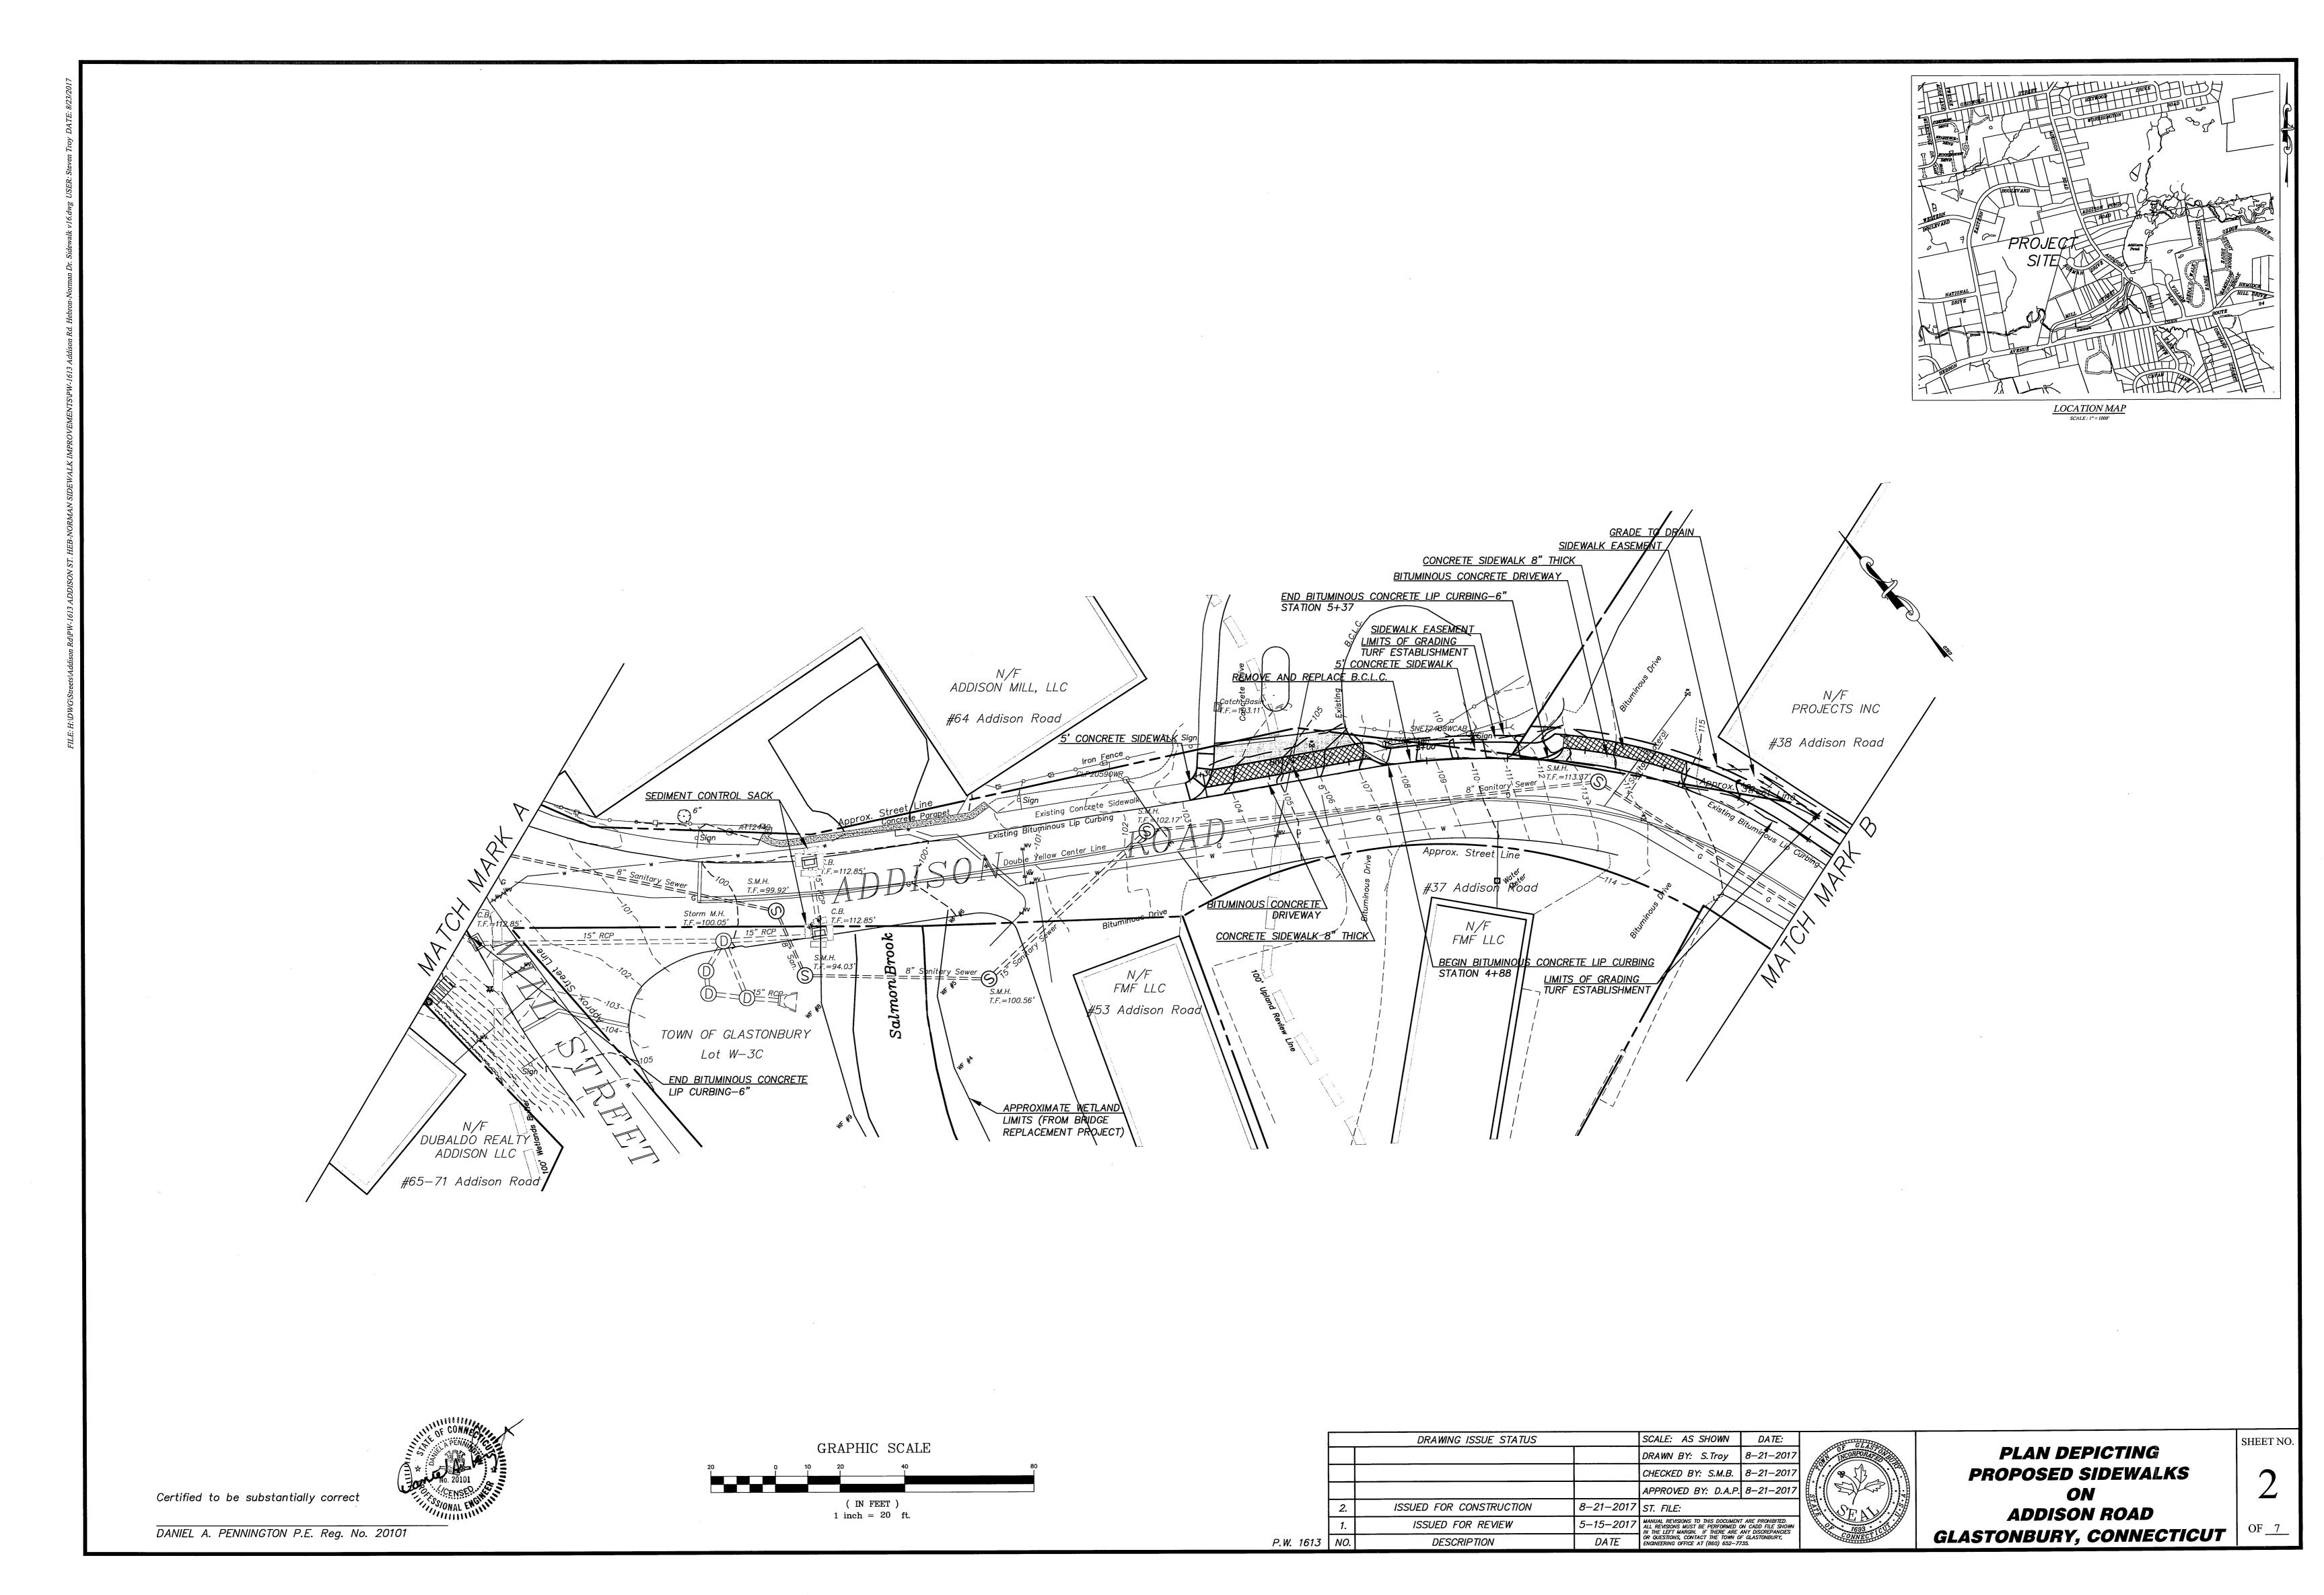

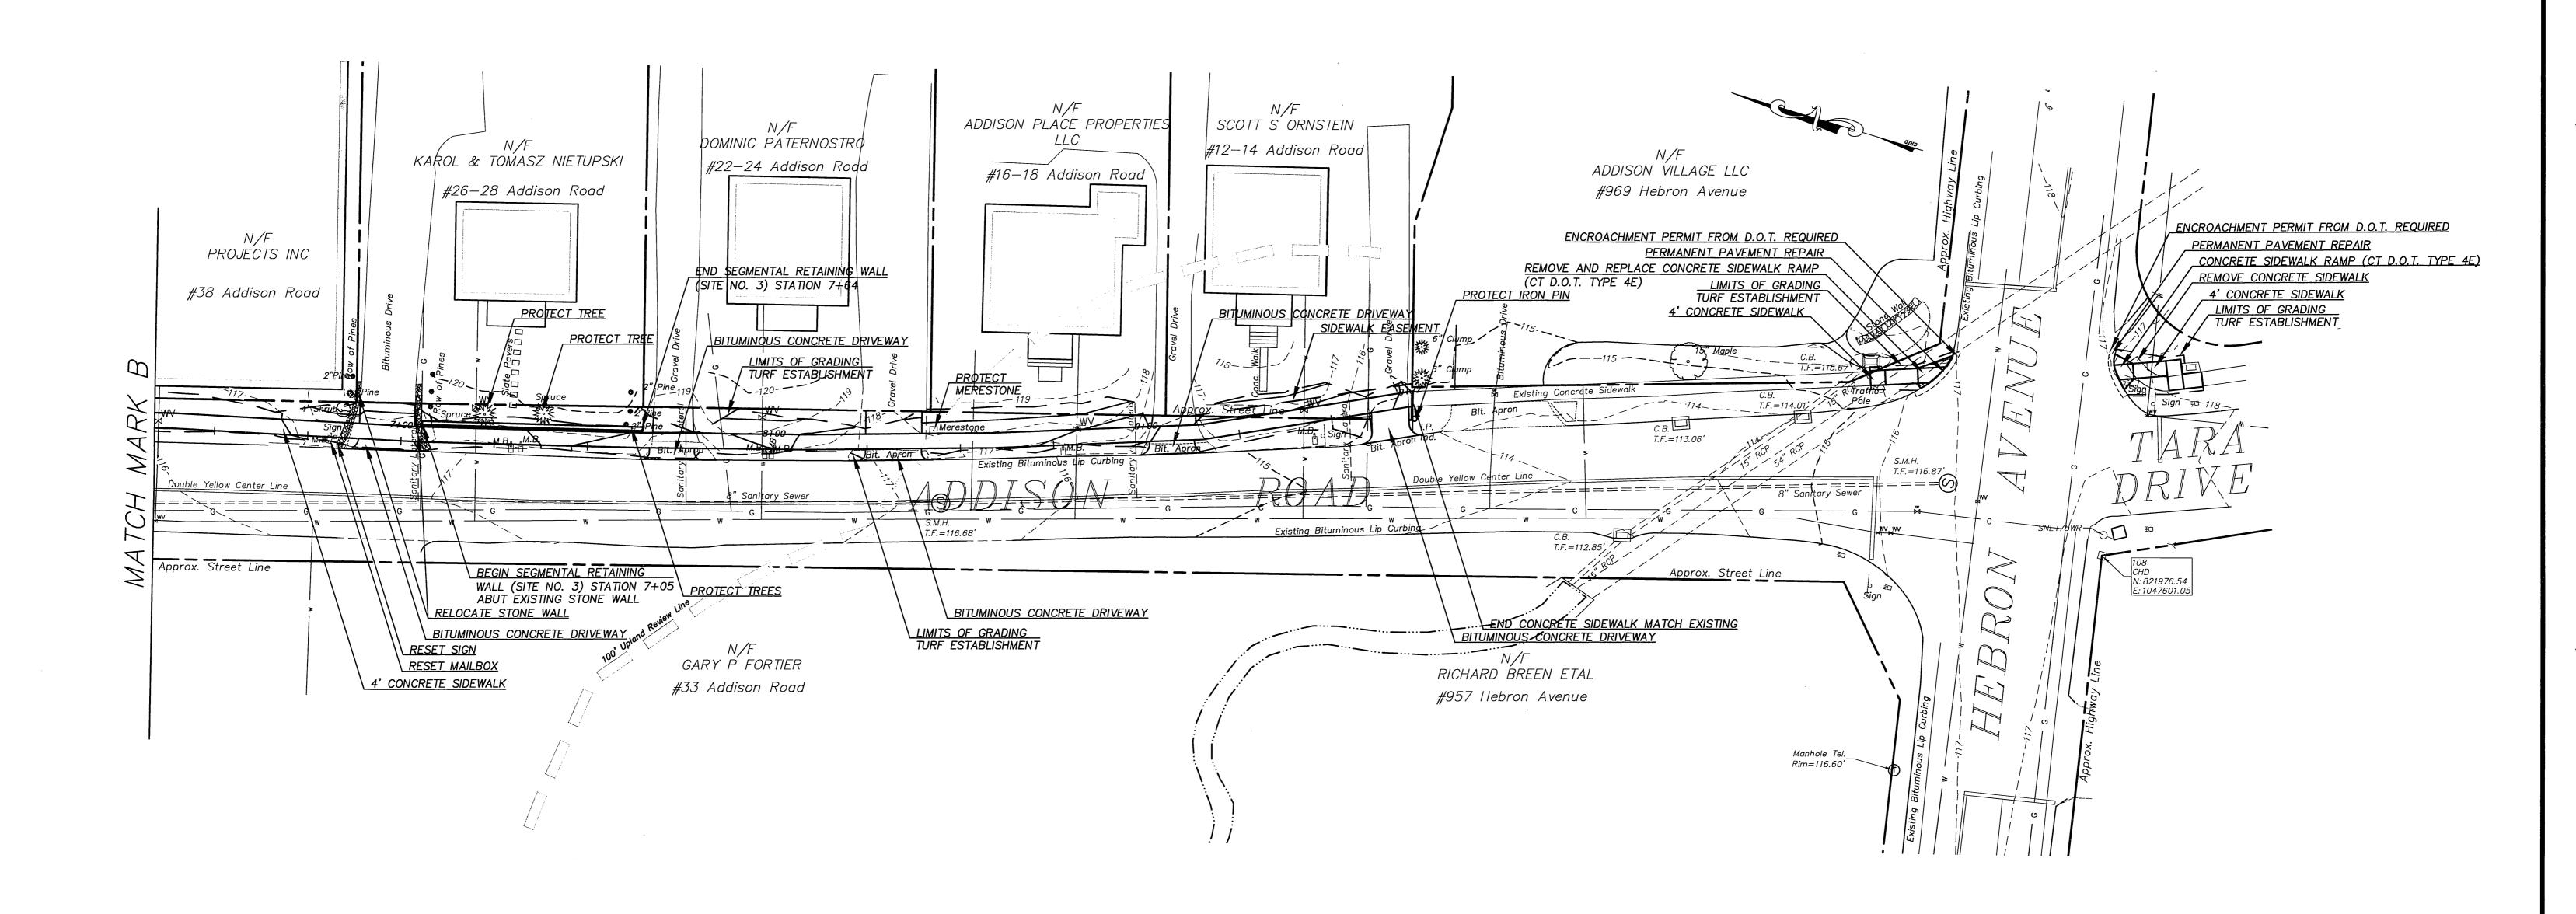


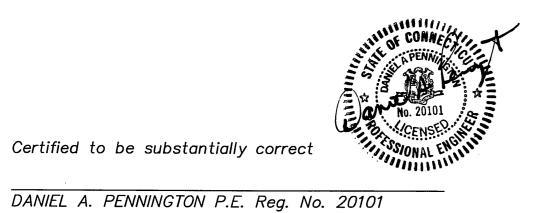
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				DRAWN BY: S.Troy	8-21-2017	
				CHECKED BY: S.M.B.	8-21-2017	
				APPROVED BY: D.A.P.	8-21-2017	
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W. 1613	NO.	DESCRIPTION	DATE	OR QUESTIONS, CONTACT THE TOWN OF GLASTONBURY, ENGINEERING OFFICE AT (860) 652-7735.		

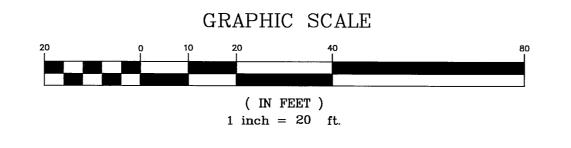


PLAN DEPICTING
PROPOSED SIDEWALKS
ON
ADDISON ROAD
GLASTONBURY, CONNECTICUT

3
OF 7

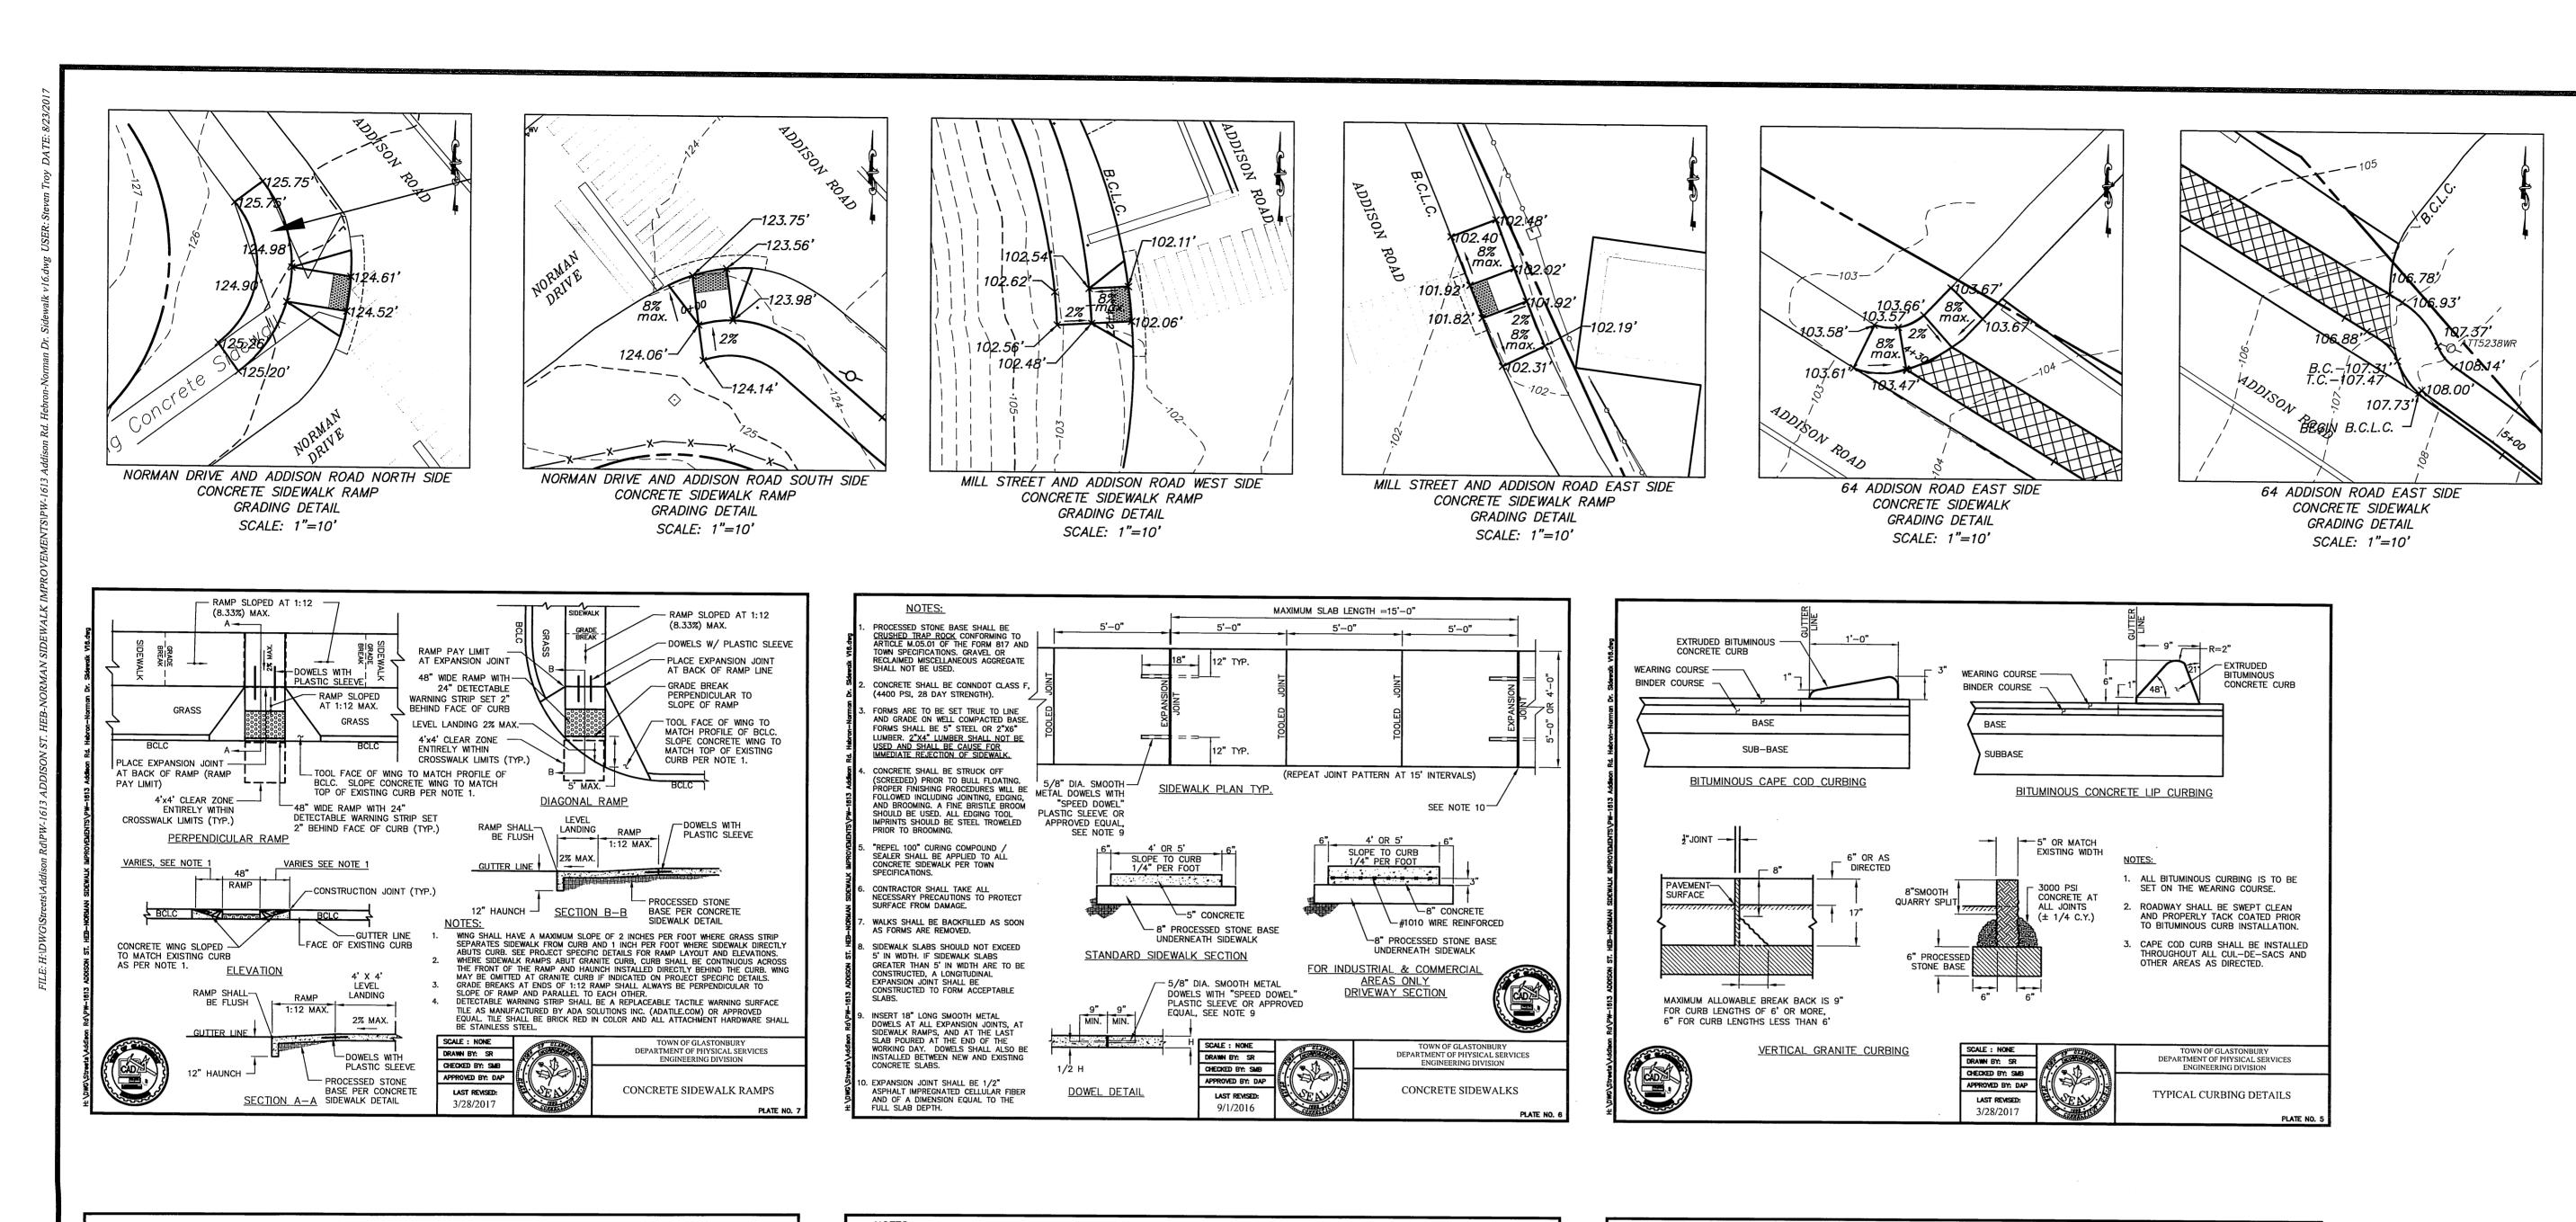

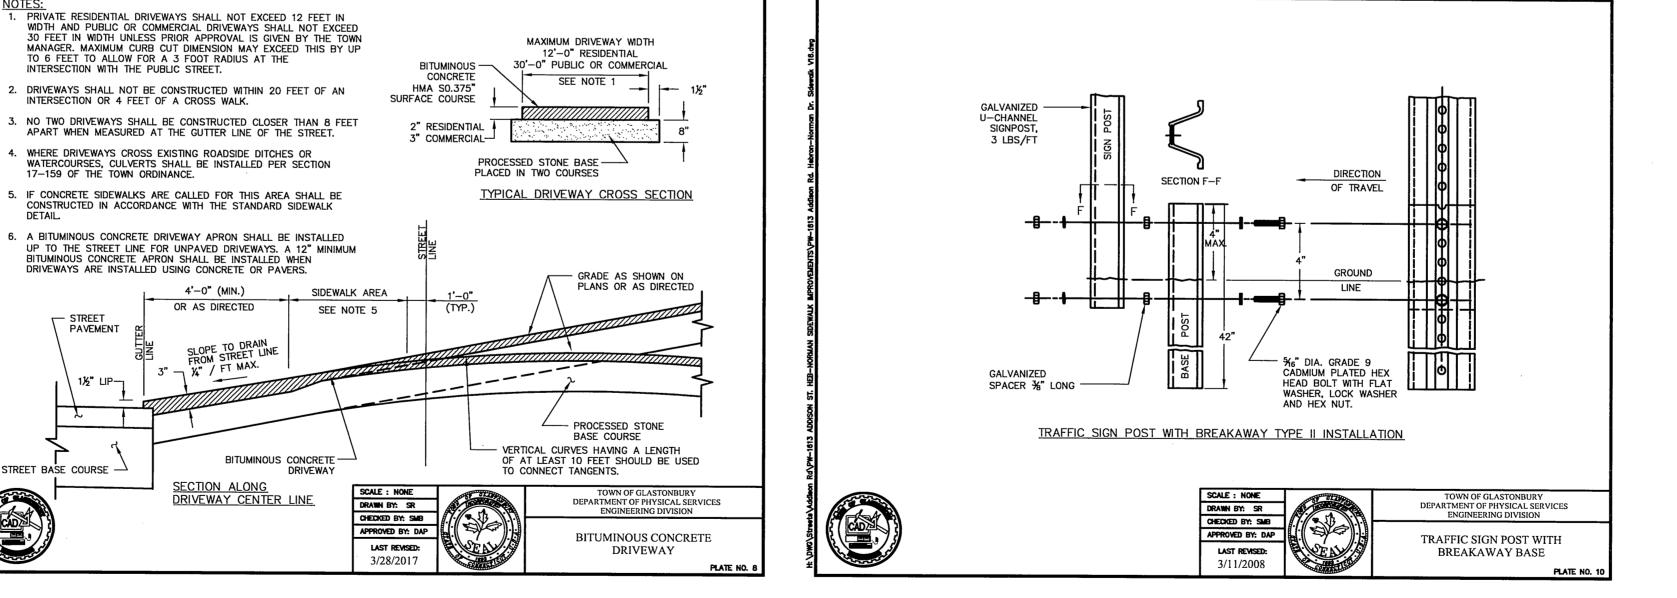

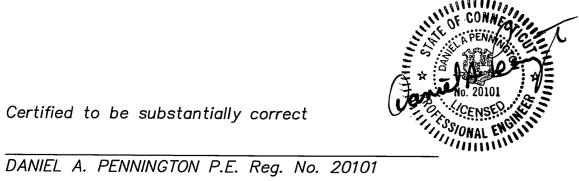

2" HMA S0.375" BITUMINOUS CONC. SURFACE COURSE

IN 6" THICK LIFTS MAX.

\*COMPACTION OF BACKFILL REQUIRED WITHIN TRENCH AREA

TRENCH OR AS

INSTALL HMA S1.0"

AS REQUIRED

BASE COURSE (AS PER

TABLE BELOW) OR FINE GRADE TRENCH WITH

ADDITIONAL PROCESSED STONE AND RECOMPACT

HMA S0.375"

HMA S0.5"

APPROVED BY: DAP

LAST REVISED:

3/28/2017

RECOMPACTED & BASE

-UNDISTURBED DIRECTED (TYP.)

LIMIT OF PERMANENT

PAVEMENT REPAIR

- BITUMINOUS WEARING

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TRENCH

PERMANENT PAVEMENT REPAIR DETAIL

LOCAL OR

COLLECTOR

N/A

SURFACE

PAVEMENT JOINT

SEALER APPLIED TO ALL PAVEMEN

EXISTING PAVEMENT

HMA IN TWO COURSES OF EQUAL THICKNESS AS PER TABLE BELOW

OR AS REQUIRED TO MATCH EXISTING

ARTERIAL

(> 3000 ADT)

3" (IN TWO LIFTS)

6" (IN TWO LIFTS)

TEMPORARY AND PERMANENT

PLATE NO.

PAVEMENT REPAIRS

PAVEMENT THICKNESS.

- STREET PAVEMENT

LIMIT OF TEMPORARY
PAVEMENT REPAIR

TEMPORARY PAVEMENT REPAIR DETAIL

PROCESS STONE BASE SHALL BE CRUSHED TRAP ROCK CONFORMING TO ARTICLE M.05.01 OF THE FORM 817 AND TOWN

SPECIFICATIONS, GRAVEL OR RECLAIMED

2. PERMANENT TRENCH REPAIRS FOR STREETS

WITH CONCRETE PAVEMENT OR CONCRETE

BASE MAY CONSIST OF 2" HMA SO.5". 6"

HMA S1.0", AND 10" GRAVEL SUBBASE AT

THE DISCRETION OF THE TOWN ENGINEER.

AT THE REQUEST OF THE TOWN ENGINEER

THE CONTRACTOR SHALL VERIFY AND SUBMIT PROPER TESTING RESULTS THAT


TANDARDS FOR A 95% COMPACTED

COMPACTION MEETS WITH TOWN'S

MISCELLANEOUS AGGREGATE SHALL NOT BE

SAW CUT-

		DRAWING ISSUE STATUS			SCALE: AS SHOWN	DATE:	
					DRAWN BY: S.Troy	8-21-2017	JAN J
					CHECKED BY: S.M.B.	8-21-2017	
					APPROVED BY: D.A.P.	8-21-2017	
		2.	ISSUED FOR CONSTRUCTION	8-21-2017	ST. FILE:		13.1
		1.	ISSUED FOR REVIEW	5-15-2017	ALL REVISIONS MUST BE PERFORMED (	ANUAL REVISIONS TO THIS DOCUMENT ARE PROHIBITED. LL REVISIONS MUST BE PERFORMED ON CADD FILE SHOWN THE LEFT MARGIN. IF THERE ARE ANY DISCREPANCIES	
W.	1613	NO.	DESCRIPTION	DATE	OR QUESTIONS, CONTACT THE TOWN OF ENGINEERING OFFICE AT (860) 652-77	APP	

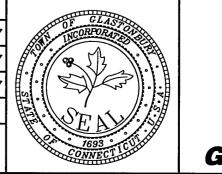

**DETAILS DEPICTING PROPOSED SIDEWALKS** ON **ADDISON ROAD** GLASTONBURY, CONNECTICUT

HEBRON AVENUE AND ADDISON ROAD

CONCRETE SIDEWALK RAMP

GRADING DETAIL

SCALE: 1"=10'

HEBRON AVENUE AND ADDISON ROAD

CONCRETE SIDEWALK RAMP


GRADING DETAIL


SCALE: 1"=10'


Controller

116.98'-


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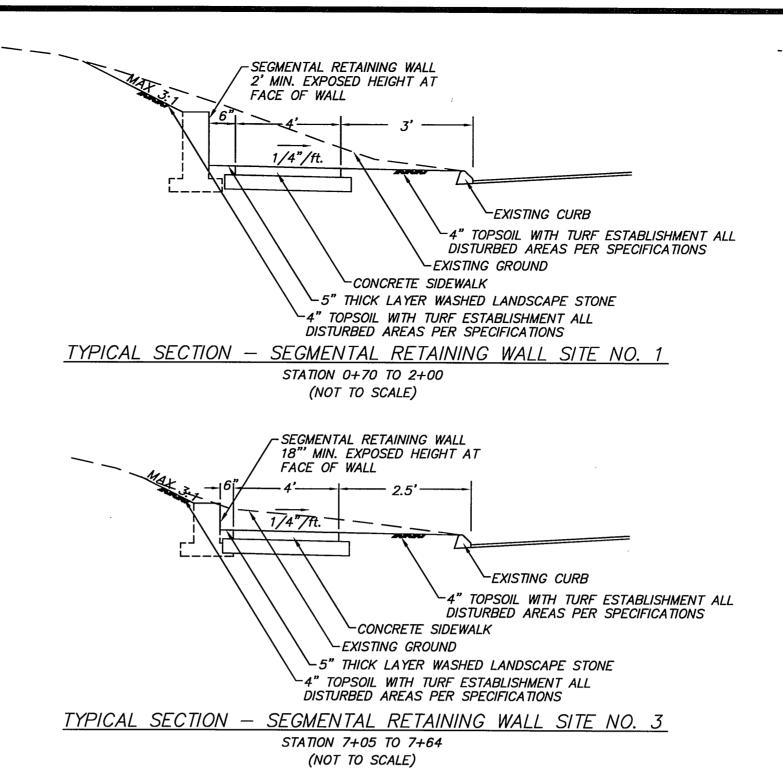


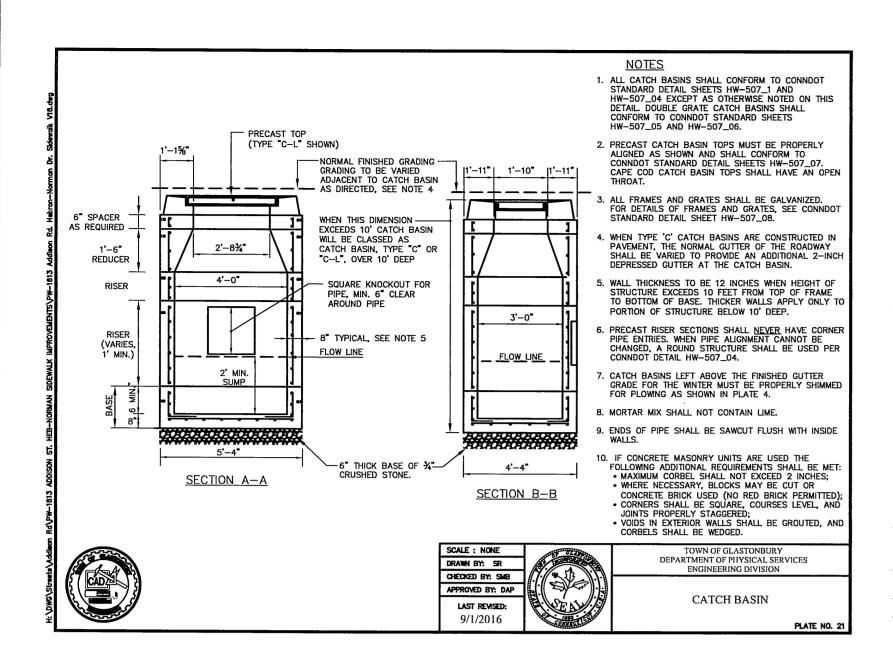


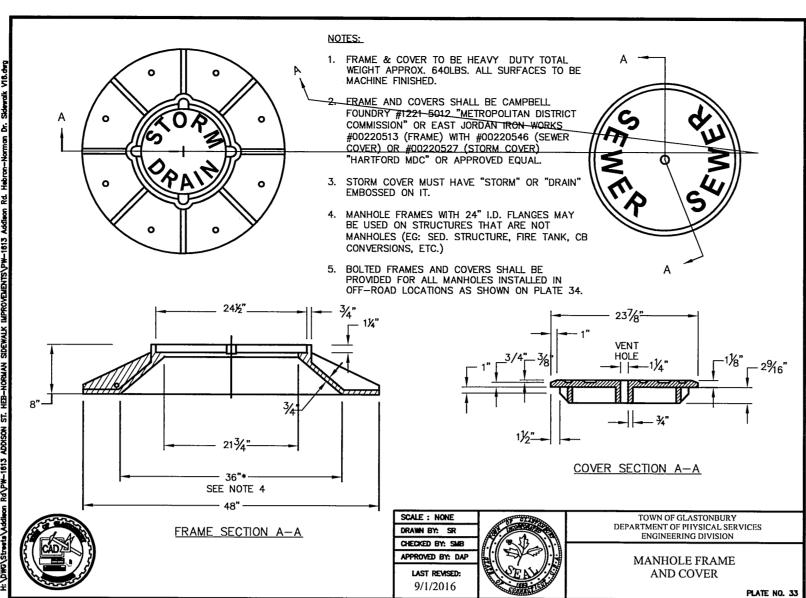

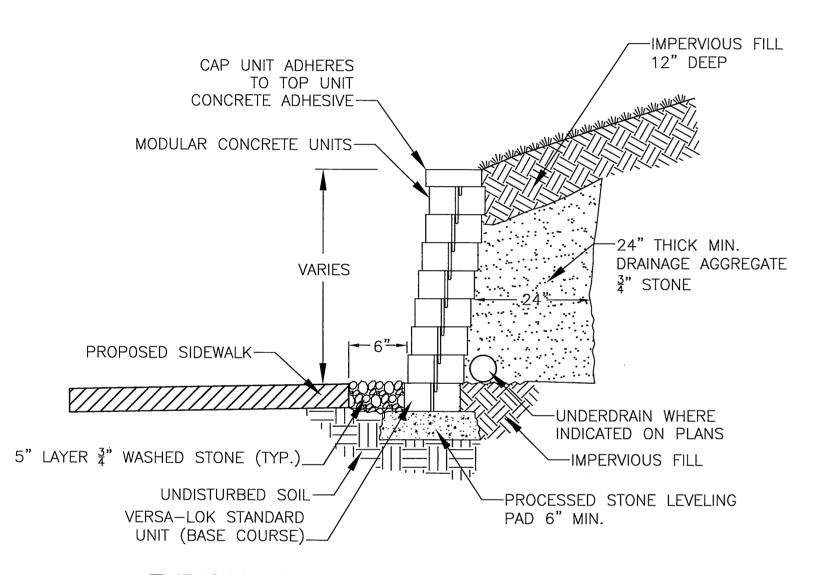
TYPICAL SECTION-SEGMENTAL RETAINING WALL



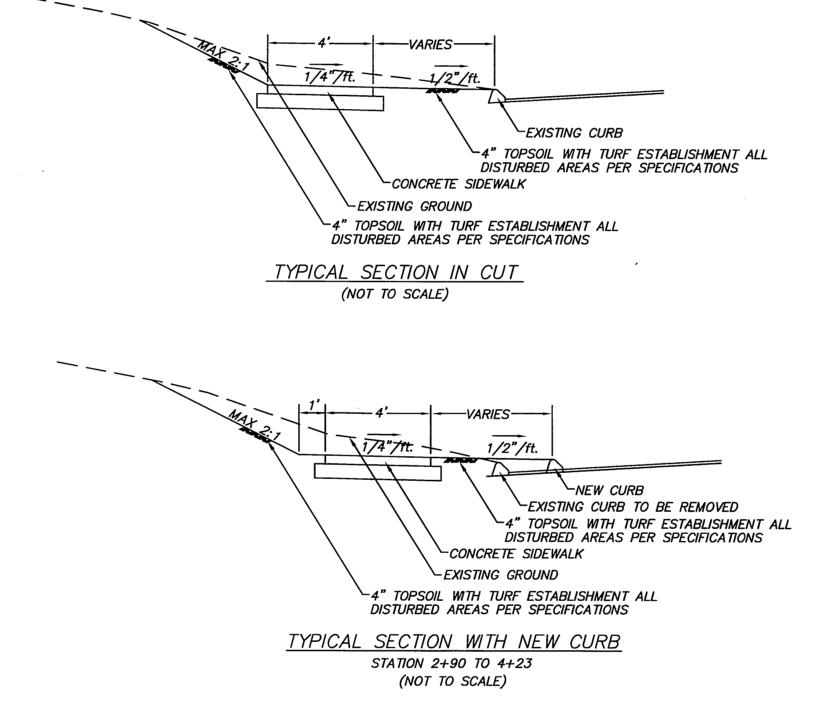


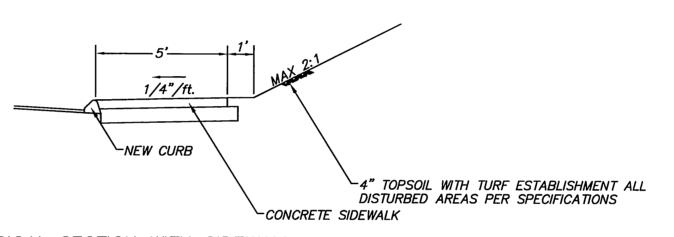

TYPICAL SECTION WITH SIDEWALK ABUTTING BITUMINOUS CURB STATION 4+85 TO 5+37 (NOT TO SCALE)

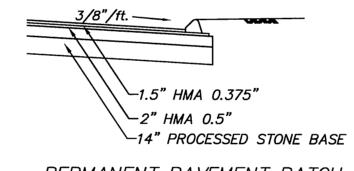



PERMANENT PAVEMENT PATCH ADDISON ROAD (NOT TO SCALE)

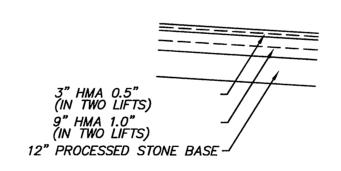


PERMANENT PAVEMENT PATCH HEBRON AVENUE (NOT TO SCALE)

P.W. 1613 NO.

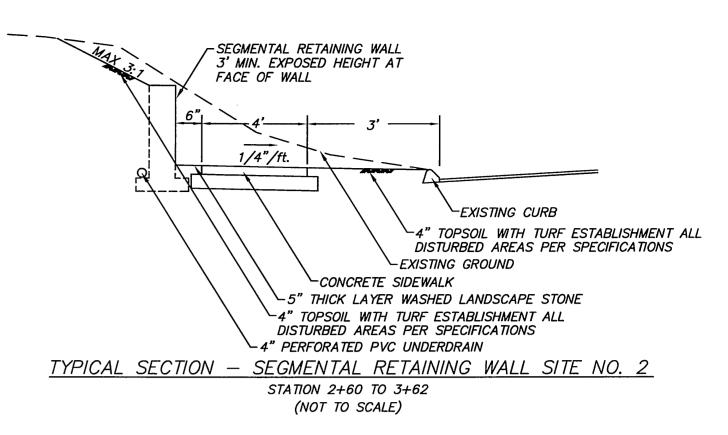

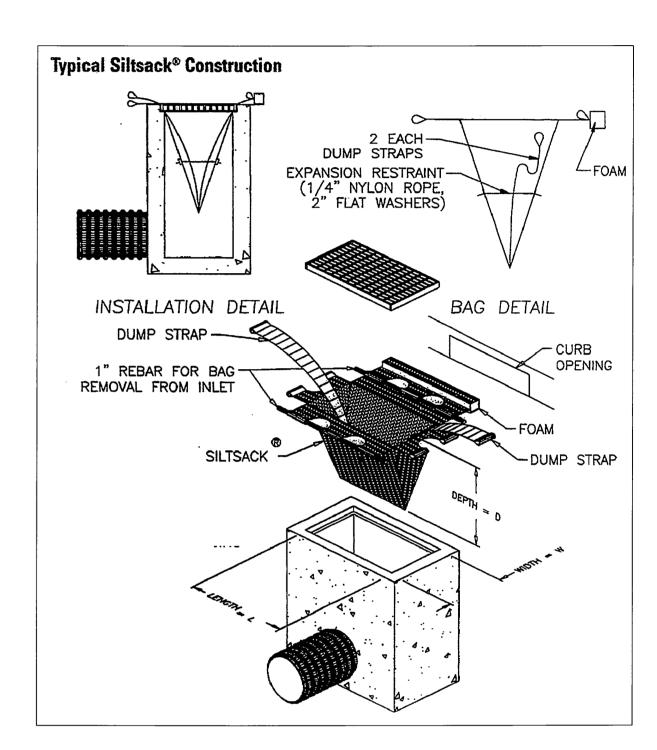

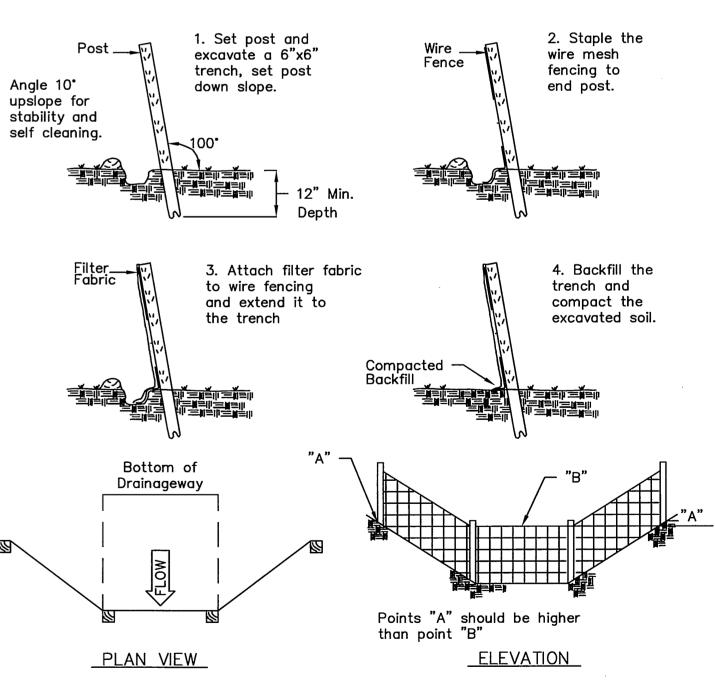

Source: U.S. Department of Agriculture, Soil Conservation Service, Storrs, Connecticut

PLACEMENT AND CONSTRUCTION SEDIMENTATION CONTROL SYSTEM

		DRAWING ISSUE STATUS		SCALE: AS SHOWN D		
				DRAWN BY: S.Troy	8-21-2017	,
				CHECKED BY: S.M.B.	8-21-2017	
				APPROVED BY: D.A.P.	8-21-2017	l s
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V. 1613	NO.	DESCRIPTION	DATE			



**DETAILS DEPICTING** PROPOSED SIDEWALKS ON **ADDISON ROAD** GLASTONBURY, CONNECTICUT

SHEET NO

DANIEL A. PENNINGTON P.E. Reg. No. 20101

Certified to be substantially correct

