

FILE: H:\DWG\Streets\Main St\PW-0908 ACADEMY SCHOOL SITE IMPROVEMENTS\TownHall-Academy-Filing-2017.dwg USER: Charles Stachulski DATE: 3/2/2017

TOWN OF GLASTONBURY ENGINEERING DEPARTMENT TOWN HALL / ACADEMY COMPLEX PW-0908 located at 2155 MAIN STREET GLASTONBURY, CONNECTICUT

SHEET INDEX

| SHEET NO. | DESCRIPTION |
|-----------|-----------------------------------|
| 1 | TITLE SHEET |
| 2 | EXISTING CONDITIONS |
| 3 | SITE LAYOUT |
| 4 | DEMOLITION |
| 5 | SITE GRADING |
| 6 | DRAINAGE/UTILITIES |
| 7 | EROSION AND SEDIMENTATION CONTROL |
| 8 | DETAILS AND SPECIFICATIONS |
| 9 | DETAILS AND SPECIFICATIONS |
| 10 | LANDSCAPING PLAN |
| 11 | LIGHTING PLAN |
| 12 | IRRIGATION PLAN |
| | |



LOCATION MAP

SCALE: 1"=1000'

DECEMBER 2016

RICHARD J. JOHNSON
TOWN MANAGER


DANIEL A. PENNINGTON
TOWN ENGINEER / MANAGER OF PHYSICAL SERVICES

| | |
|---|-----------------------------------|
| Town of Glastonbury PROJECT/APPLICANT | Reserved Land Zone ZONE |
| 2155 & 2143 Main Street Town Hall & Academy Building PROJECT ADDRESS | |
| Section 12 SPECIAL PERMIT SECTION | TPZ CHAIRPERSON |
| January 17, 2017 DATE SPECIAL PERMIT APP'D | DIRECTOR OF COMMUNITY DEVELOPMENT |
| FILE NO. | |

THIS MAP PRODUCED BY
ORIGINAL INK DRAWING ON
POLY FILM OR LINEN
TOWN OF GLASTONBURY
2155 MAIN STREET
GLASTONBURY, CT 06033


ALL UTILITY INFORMATION AND DATA SHOWN OR INDICATED IN THE CONTRACT DOCUMENTS ARE COMPILED FROM MAPS AND DATA FURNISHED BY OTHERS. ANY SUCH INFORMATION SHOULD NOT BE CONSTRUED AS ACCURATE OR COMPLETE AND THE CONTRACTOR SHALL VERIFY ALL LOCATIONS PRIOR TO CONSTRUCTION.

MANUAL REVISIONS TO THIS DOCUMENT ARE PROHIBITED.
ALL REVISIONS MUST BE PERFORMED ON CADD FILE:
H:\DWG\Streets\Main St\PW-0908 ACADEMY SCHOOL SITE IMPROVEMENTS\TownHall-Academy-Filing-2017.dwg


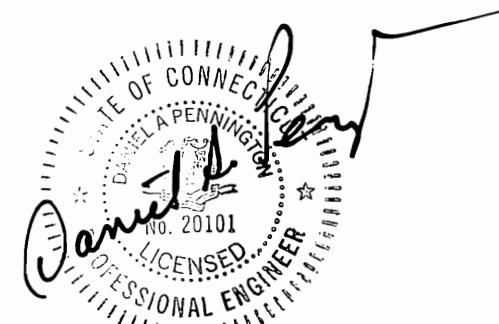


PW-0908

| DRAWING ISSUE STATUS | | |
|----------------------|----------------------------|------------|
| NO. | DESCRIPTION | DATE |
| 3. | ISSUED FOR LANDSCAPING BID | 5/5/2017 |
| 2. | CONDITIONS OF APPROVAL | 3/28/2017 |
| 1. | ISSUED FOR PERMITTING | 12/16/2016 |
| NO. | DESCRIPTION | DATE |

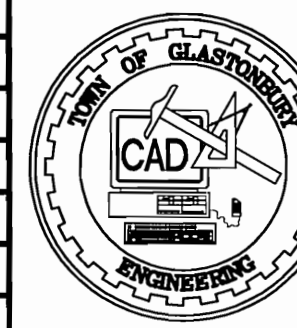

| | |
|--|------------|
| SCALE: AS SHOWN | DATE: |
| DRAWN BY: C.F.S. | 11/11/2016 |
| CHECKED BY: S.M.B. | 11/11/2016 |
| APPROVED BY: D.A.P. | 11/11/2016 |
| ST. FILE: | |
| DO NOT SCALE THIS DRAWING. USE THE DIMENSIONS GIVEN. IF THERE ARE ANY DISCREPANCIES OR QUESTIONS, CONTACT THE TOWN OF GLASTONBURY, ENGINEERING OFFICE. | |

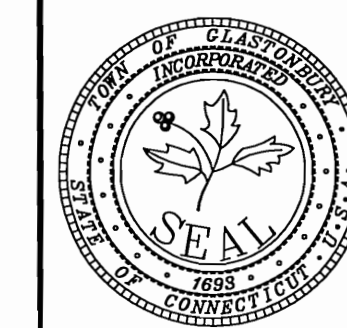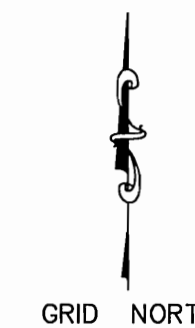


PRELIMINARY
PLAN DEPICTING
TOWN HALL / ACADEMY COMPLEX
FOR THE
DRIVE & PARKING RECONFIGURATION
LOCATED AT
2155 / 2143 MAIN STREET
GLASTONBURY, CONNECTICUT


SHEET NO.
1
OF 12

FILE: H:\DWG\Streets\Main St\PW-0908 ACADEMY SCHOOL SITE IMPROVEMENTS\TownHall-Academy-Filing-2017.dwg USER: Charles Stuchlik DATE: 5/15/2017

NOTE:
THIS PLAN WAS COMPILED FROM OTHER MAPS, RECORD RESEARCH OR OTHER SOURCES OF INFORMATION. IT IS NOT TO BE CONSTRUED AS HAVING BEEN OBTAINED AS THE RESULT OF A FIELD SURVEY, AND IS SUBJECT TO SUCH CHANGE AS AN ACCURATE FIELD SURVEY MAY DISCLOSE.
REPRODUCTIONS OF THIS PLAN ARE INVALID IF THEY DO NOT BEAR THE IMPRESSION SEAL OF THE UNDERSIGNED LAND SURVEYOR AND/OR PROFESSIONAL ENGINEER.

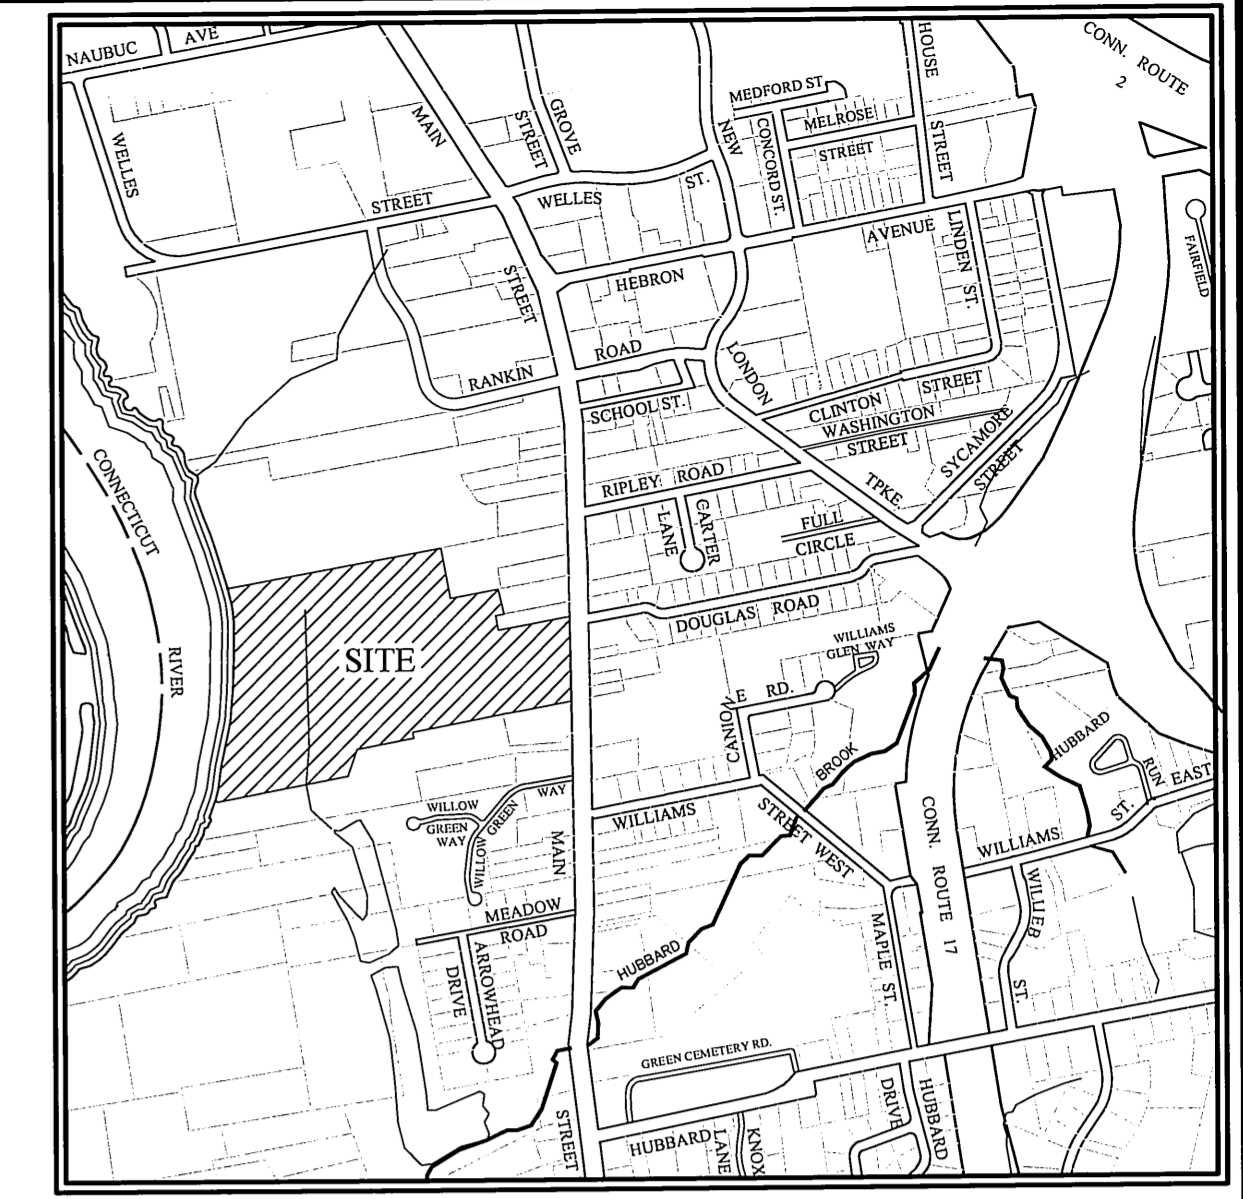



LOCATION MAP
SCALE: 1" = 1000'

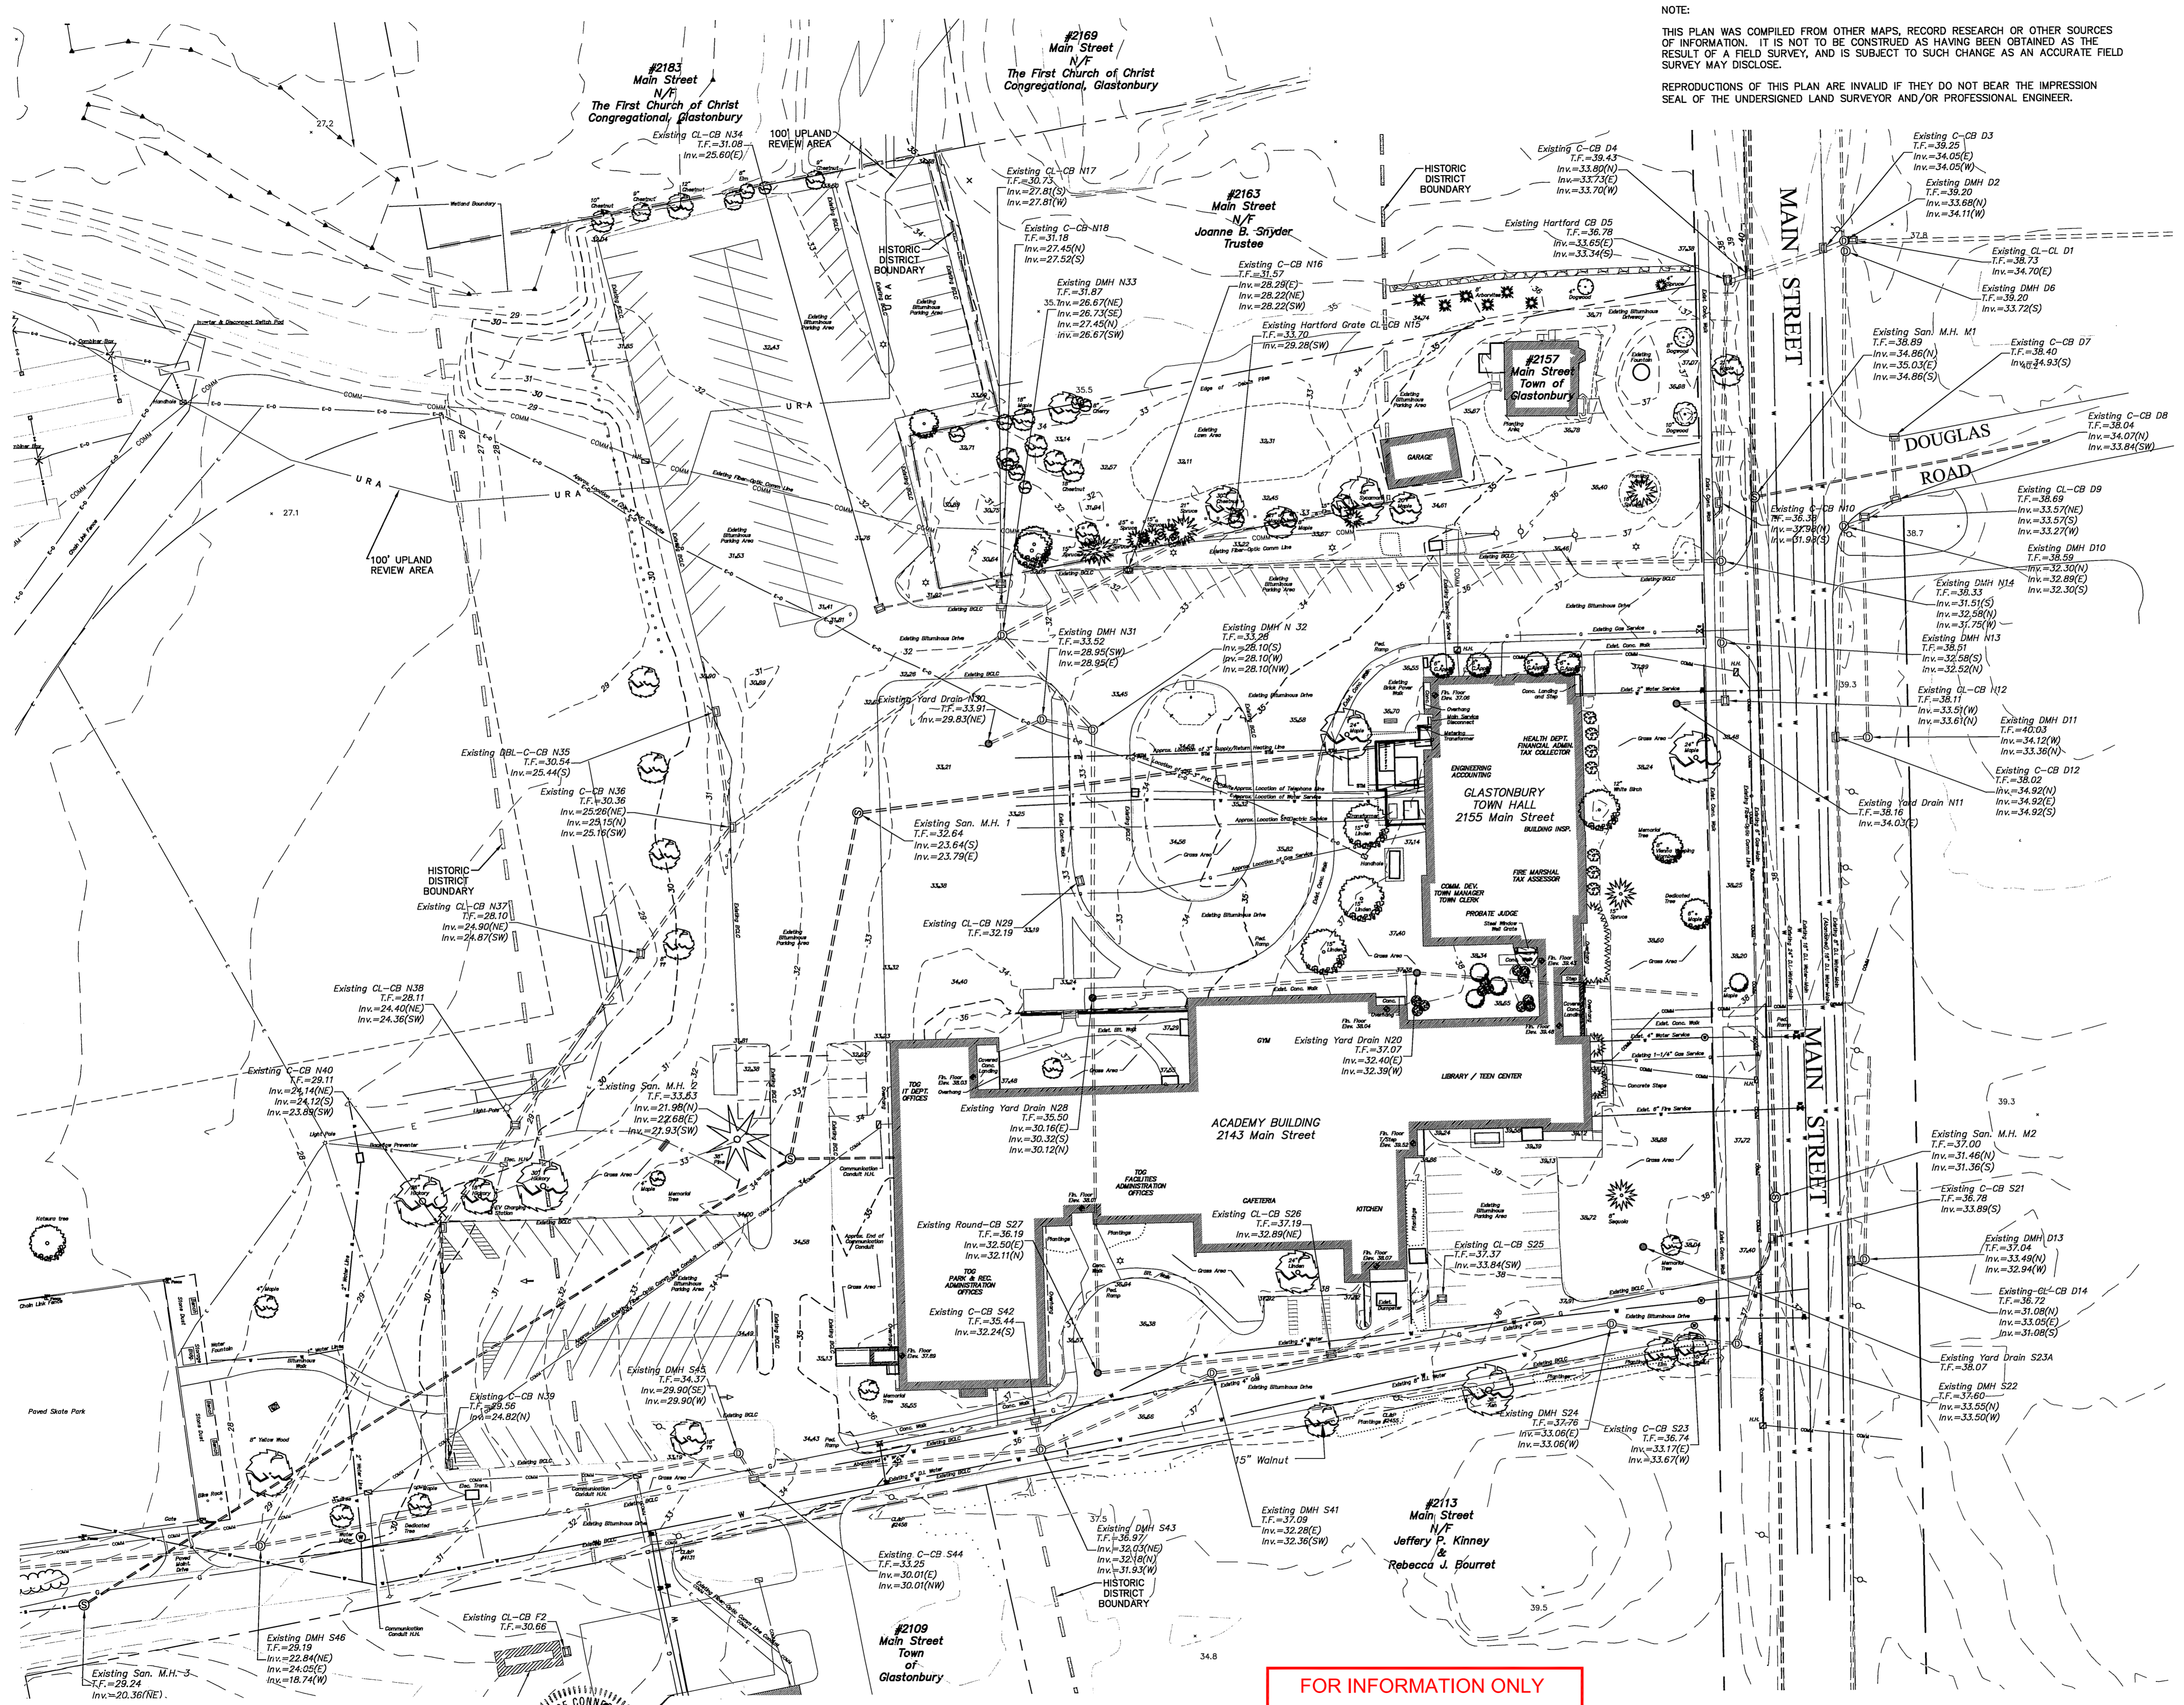

| | |
|---------------------------|-----------------------------------|
| Town of Glastonbury | Reserved Land Zone |
| PROJECT/APPLICANT | ZONE |
| 2155 & 2143 Main Street | Town Hall & Academy Building |
| PROJECT ADDRESS | |
| Section 12 | TPZ CHAIRPERSON |
| SPECIAL PERMIT SECTION | |
| January 17, 2017 | DIRECTOR OF COMMUNITY DEVELOPMENT |
| DATE SPECIAL PERMIT APP'D | |
| FILE NO. | |


- SURVEY NOTES:**
- LOCATION OF FEATURES AND CONTOUR DATA DEPICTED HEREON WHERE ACQUIRED THROUGH FIELD SURVEY CONDUCTED 5-2011.
 - THERE IS NO BOUNDARY/DETERMINATION OPINION.
 - NOT ALL IMPROVEMENTS ARE DEPICTED HEREON.
 - HORIZONTAL CONTROL IS BASED ON THE CONNECTICUT GEODETIC SURVEY STATE PLANE COORDINATES, NORTH AMERICAN DATUM OF 1983 - (NAD83).
 - ELEVATIONS AND VERTICAL CONTROL IS BASED ON THE NORTH AMERICAN VERTICAL DATUM 1988 - (NAVD88).
 - REFERENCE FOR UTILITY INFO FROM THE FOLLOWING:
 - SITE PLAN LYONS AND MATHER ARCHITECTS BRIDGEPORT CONNECTICUT ACADEMY SCHOOL CONVERSION FOR JUNIOR HIGH SCHOOL DATE 1 JUNE 1960 JOB NO. 804
 - VARIOUS SITE, ELECTRICAL, MECHANICAL-HEATING & PLUMBING PLANS PROJECT 7202 ACADEMY SCHOOL RENOVATIONS 2141 MAIN STREET GLASTONBURY, CONNECTICUT DATE NOV 5 73 STECKER AND COLAVECCHIO ARCHITECTS, INC. 800 COTTAGE GROVE ROAD BLOOMFIELD, CONNECTICUT 06002 BEMIS FREEMAN SIPALA CONSULTING ENGINEERS

THIS MAP PRODUCED BY ORIGINAL INK DRAWING ON POLY FILM OR LINEN TOWN OF GLASTONBURY 2155 MAIN STREET GLASTONBURY, CT 06033

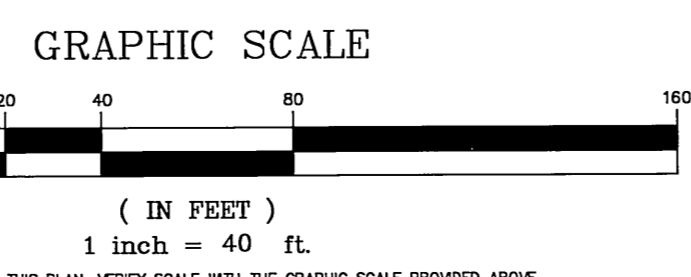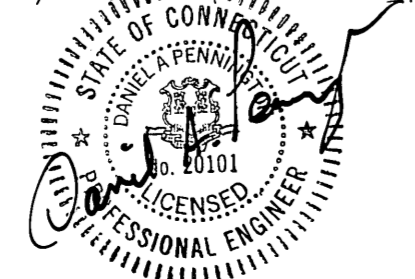


FOR INFORMATION ONLY

| DRAWING ISSUE STATUS | |
|----------------------|-------------------------------------|
| NO. | DESCRIPTION |
| 3. | ISSUED FOR LANDSCAPING BID 5/5/2017 |
| 2. | CONDITIONS OF APPROVAL 3/28/2017 |
| 1. | ISSUED FOR PERMITTING 12/16/2016 |
| NO. | DESCRIPTION |

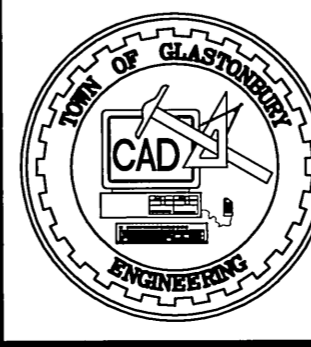

| | |
|---------------------|------------------|
| DRAWN BY: C.F.S. | DATE: 11/15/2016 |
| CHECKED BY: S.M.B. | DATE: 11/15/2016 |
| APPROVED BY: D.A.P. | DATE: 11/15/2016 |
| ST. FILE: | |

DO NOT SCALE THIS DRAWING. USE THE DIMENSIONS GIVEN. IF THERE ARE ANY DISCREPANCIES OR QUESTIONS CONTACT THE TOWN OF GLASTONBURY, ENGINEERING OFFICE.

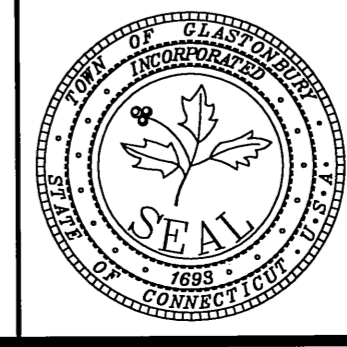

PLAN DEPICTING EXISTING CONDITIONS
TOWN HALL / ACADEMY COMPLEX
DRIVE & PARKING RECONFIGURATION
LOCATED AT
2155 / 2143 MAIN STREET
GLASTONBURY, CONNECTICUT

SHEET NO.
2
OF 12

ALL UTILITY INFORMATION AND DATA SHOWN OR INDICATED IN THE CONTRACT DOCUMENTS ARE COMPILED FROM MAPS AND DATA FURNISHED BY OTHERS. ANY SUCH INFORMATION SHOULD NOT BE CONSTRUED AS ACCURATE OR COMPLETE AND THE CONTRACTOR SHALL VERIFY ALL LOCATIONS PRIOR TO CONSTRUCTION.

MANUAL REVISIONS TO THIS DOCUMENT ARE PROHIBITED.
ALL REVISIONS MUST BE PERFORMED ON CADD FILE.
H:\DWG\Streets\Main St\PW-0908 ACADEMY SCHOOL SITE IMPROVEMENTS\TownHall-Academy-Filing-2017.dwg


PW-0908

FILE: E:\DWG\Streets\Main St\PW-0908 ACADEMY SCHOOL SITE IMPROVEMENTS\TownHall-Academy-Filing-2017.dwg USER: Charles Stoddard DATE: 5/4/2017

SIGN LEGEND

LIGHTING NOTE:
 PARKING AREA AND WALKWAY LIGHTING FIXTURE TO BE STERNBERG LIGHTING
 MODEL: HISTORIC 6130LED, BLACK FINISH, CSA LENS.
 PARKING AREA LIGHT FIXTURES TO BE MOUNTED TO 12' OR 14' POLE AS NOTED.
 WALKWAY LIGHT FIXTURE TO BE MOUNTED TO 10' POLE.

NOTE:
 THIS PLAN WAS COMPILED FROM OTHER MAPS, RECORD RESEARCH OR OTHER SOURCES OF INFORMATION. IT IS NOT TO BE CONSTRUED AS HAVING BEEN OBTAINED AS THE RESULT OF A FIELD SURVEY, AND IS SUBJECT TO SUCH CHANGE AS AN ACCURATE FIELD SURVEY MAY DISCLOSE.
 REPRODUCTIONS OF THIS PLAN ARE INVALID IF THEY DO NOT BEAR THE IMPRESSION SEAL OF THE UNDERSIGNED LAND SURVEYOR AND/OR PROFESSIONAL ENGINEER.

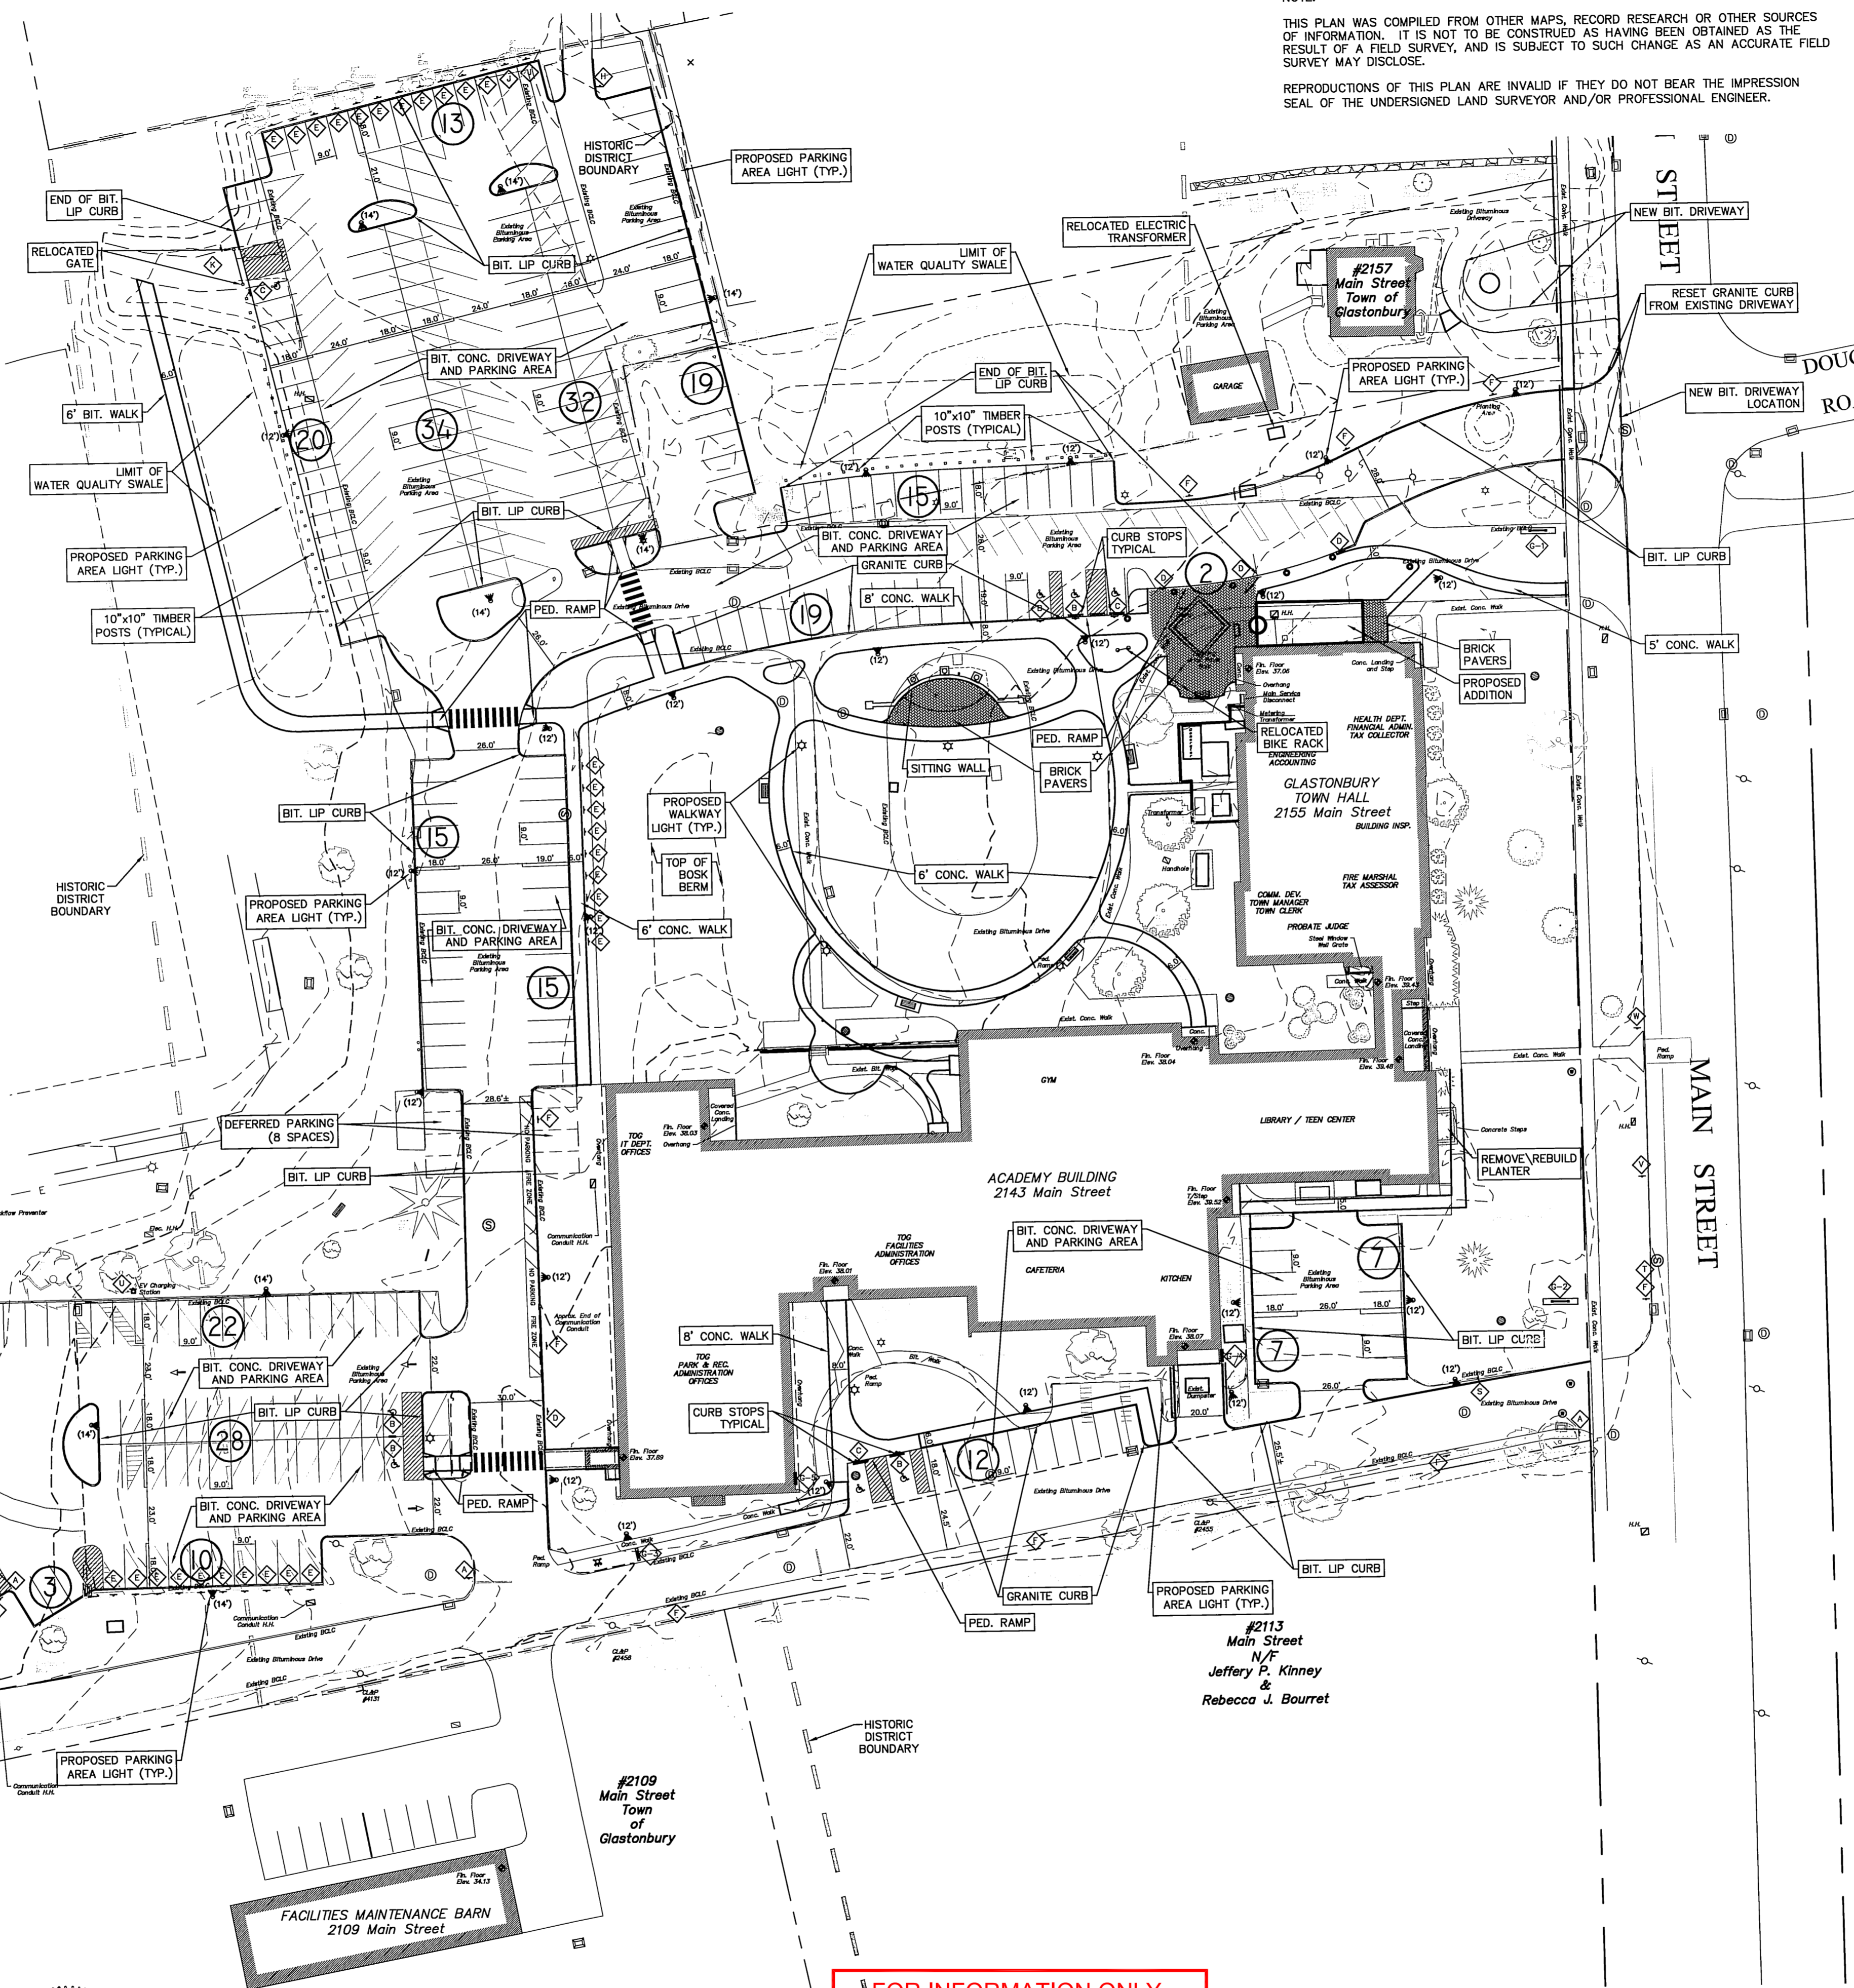

BUILDING AREA CALCULATION FOR PARKING ANALYSIS:
 SQUARE FOOTAGE FOR THE TOWN HALL BUILDING ARE AS FOLLOWS:
 LOWER LEVEL - TAX, ASSESSOR, TOWN CLERK = 6,992 SF
 MIDDLE LEVEL - FINANCE, ACCOUNTING, MANAGERS = 8,842 SF
 UPPER LEVEL - HEALTH, BUILDING, ENGINEERING = 7,750 SF
 TOTAL BUILDING - TOWN HALL = 23,584 SF
 SQUARE FOOTAGE FOR THE ACADEMY COMPLEX BUILDING ARE AS FOLLOWS:
 PARK & REC., ACTIVITY ROOMS = 5,616 SF
 IT, CONFERENCE ROOM, WEST OFFICES = 4,060 SF
 FACILITIES, CONFERENCE ROOM, PROBATE = 5,768 SF
 GYM, CAFETERIA, KITCHEN = 2,896 SF
 TEEN CENTER = 4,004 SF
 ACADEMY LIBRARY (NOT INCLUDED) = 0 SF
 TOTAL BUILDING - ACADEMY COMPLEX = 32,344 SF
 PROPOSED TOWN HALL ADDITION = 1,000 SF

PARKING ANALYSIS:
 PARKING CALCULATIONS ARE COMPUTED BASED ON COMBINED SQUARE FOOTAGE FOR THE ENTIRE MUNICIPAL BUILDING COMPLEX AND ARE AS FOLLOWS:
 NET FLOOR AREAS FOR PARKING CALCULATIONS:
 #2155 TOWN HALL OFFICE BUILDING = 23,584 SF
 #2143 ACADEMY BUILDING = 32,344 SF
 PROPOSED ADDITION = 1,000 SF
 TOTAL BUILDING SF = 56,928 SF
 TOTAL REQUIRED PARKING SPACES AT 1 SPACE PER 200 SF OF BUILDING AREA:
 56,928 / 200 = 284.6, SAY 285 SPACES REQUIRED.
 TOTAL PROVIDED PARKING SPACES = 277
 TOTAL DEFERRED PARKING SPACES = 8
 TOTAL PARKING SPACES SHOWN = 285
 SEE CHART BELOW.
 ADA PARKING REQUIREMENT FOR PARKING LOTS WITH 201-300 SPACE
 REQUIRES - 7 HANDICAPPED SPACES.
 TOTAL OF ADA COMPLIANT SPACES = 9
 SEE CHART BELOW.

NET FLOOR AREAS FOR PARKING CALCULATIONS:
 #2155 TOWN HALL OFFICE BUILDING = 23,584 SF
 #2143 ACADEMY BUILDING = 32,344 SF
 PROPOSED ADDITION = 1,000 SF
 TOTAL BUILDING SF = 56,928 SF

TOTAL REQUIRED PARKING SPACES AT 1 SPACE PER 200 SF OF BUILDING AREA:
 56,928 / 200 = 284.6, SAY 285 SPACES REQUIRED.
TOTAL PROVIDED PARKING SPACES = 277
TOTAL DEFERRED PARKING SPACES = 8
TOTAL PARKING SPACES SHOWN = 285



SEE CHART BELOW.
 ADA PARKING REQUIREMENT FOR PARKING LOTS WITH 201-300 SPACE
 REQUIRES - 7 HANDICAPPED SPACES.
TOTAL OF ADA COMPLIANT SPACES = 9
 SEE CHART BELOW.

| Parking Area Designation | Existing Site | Proposed |
|-------------------------------|---------------|------------|
| Town Hall - Driveway Parking | 24 | 36 |
| Town Hall - Traffic Circle | 13 | N/A |
| Town Hall - Rear Parking Area | 79 | 118 |
| Bosk Area Parking | 32 | 30 |
| Parks/Skate Park Parking | 43 | 67 |
| Facilities Office | 7 | 12 |
| Teen Center | 16 | 14 |
| Deferred Parking (Bosk Area) | 0 | 8 |
| Total Parking Spaces | 214 | 285 |
| Total Designated HC Spaces | 7 | 9 |


| | |
|---------------------------|-----------------------------------|
| Town of Glastonbury | Reserved Land Zone |
| PROJECT/APPLICANT | ZONE |
| 2155 & 2143 Main Street | Town Hall & Academy Building |
| PROJECT ADDRESS | |
| Section 12 | TPZ CHAIRPERSON |
| SPECIAL PERMIT SECTION | |
| January 17, 2017 | DIRECTOR OF COMMUNITY DEVELOPMENT |
| DATE SPECIAL PERMIT APP'D | |
| FILE NO. | |

FOR INFORMATION ONLY



THIS MAP PRODUCED BY ORIGINAL INK DRAWING ON POLY FILM OR LINEN TOWN OF GLASTONBURY 2155 MAIN STREET GLASTONBURY, CT 06033

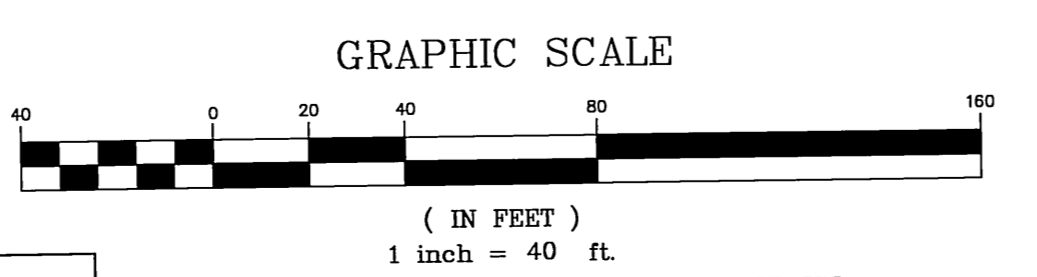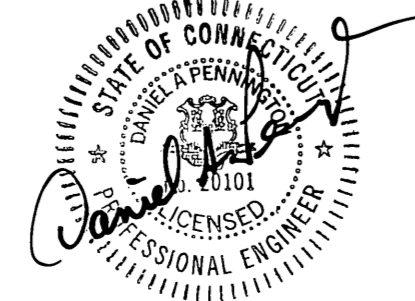

| DRAWING ISSUE STATUS | |
|----------------------|-------------------------------------|
| NO. | DESCRIPTION |
| 3. | ISSUED FOR LANDSCAPING BID 5/5/2017 |
| 2. | CONDITIONS OF APPROVAL 3/28/2017 |
| 1. | ISSUED FOR PERMITTING 12/16/2016 |
| NO. | DATE |

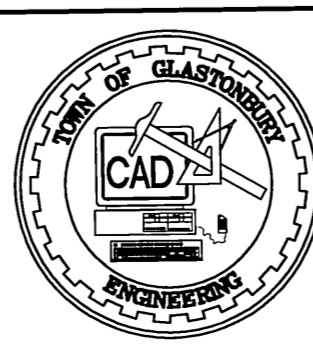

| | |
|---------------------|--------------------|
| SCALE: AS SHOWN | DATE: 11/17/2016 |
| DRAWN BY: C.F.S. | CHECKED BY: S.M.B. |
| APPROVED BY: D.A.P. | DATE: 11/17/2016 |

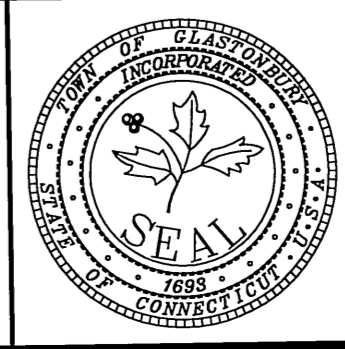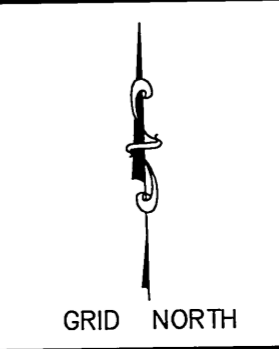

PLAN DEPICTING SITE LAYOUT
TOWN HALL / ACADEMY COMPLEX
 DRIVE & PARKING RECONFIGURATION
 LOCATED AT
 2155 / 2143 MAIN STREET
 GLASTONBURY, CONNECTICUT

SHEET NO. **3** OF 12

ALL UTILITY INFORMATION AND DATA SHOWN OR INDICATED IN THE CONTRACT DOCUMENTS ARE COMPILED FROM MAPS AND DATA FURNISHED BY OTHERS. ANY SUCH INFORMATION SHOULD NOT BE CONSTRUED AS ACCURATE OR COMPLETE AND THE CONTRACTOR SHALL VERIFY ALL LOCATIONS PRIOR TO CONSTRUCTION.

MANUAL REVISIONS TO THIS DOCUMENT ARE PROHIBITED.
 ALL REVISIONS MUST BE PERFORMED ON CADD FILE.
 E:\DWG\Streets\Main St\PW-0908 ACADEMY SCHOOL SITE IMPROVEMENTS\TownHall-Academy-Filing-2017.dwg PW-0908

FILE: E:\DWG\Streets\Main ST\PW-0908 ACADEMY SCHOOL SITE IMPROVEMENTS\TownHall-Academy-Filing-2017.dwg USER: Charles Stuchlik Date: 5/4/2017

NOTE:
 THIS PLAN WAS COMPILED FROM OTHER MAPS, RECORD RESEARCH OR OTHER SOURCES OF INFORMATION. IT IS NOT TO BE CONSTRUED AS HAVING BEEN OBTAINED AS THE RESULT OF A FIELD SURVEY, AND IS SUBJECT TO SUCH CHANGE AS AN ACCURATE FIELD SURVEY MAY DISCLOSE.
 REPRODUCTIONS OF THIS PLAN ARE INVALID IF THEY DO NOT BEAR THE IMPRESSION SEAL OF THE UNDERSIGNED LAND SURVEYOR AND/OR PROFESSIONAL ENGINEER.





SITE DEMOLITION KEY:

| | |
|--------------------|--|
| [Dotted Hatching] | AREA OF PAVEMENT TO BE RECLAIMED PRIOR TO FULL-DEPTH RECONSTRUCTION. |
| [Cross-hatch] | AREA OF PAVEMENT TO BE RECLAIMED AND REGRADED. |
| [Diagonal Hatch] | AREA OF PAVEMENT TO BE RECLAIMED AND COMPLETELY REMOVED. |
| [Horizontal Hatch] | AREA OF SIDEWALK TO BE COMPLETELY REMOVED. |
| [Vertical Hatch] | AREAS OF FULL DEPTH PAVEMENT CONSTRUCTION TO BE CLEARED, GRUBBED, AND HAVE TOPSOIL STRIPPED. |
| [Dashed Line] | STORM DRAINAGE LINES TO BE REMOVED OR ABANDONED IN PLACE. |
| [Solid Line] | PROTECT TREES WITH CONSTRUCTION FENCE. |


Town of Glastonbury Reserved Land Zone
 PROJECT/APPLICANT ZONE
 2155 & 2143 Main Street Town Hall & Academy Building
 PROJECT ADDRESS
 Section 12
 SPECIAL PERMIT SECTION TPZ CHAIRPERSON
 January 17, 2017
 DATE SPECIAL PERMIT APP'D DIRECTOR OF COMMUNITY DEVELOPMENT
 FILE NO.

FOR INFORMATION ONLY



THIS MAP PRODUCED BY ORIGINAL INK DRAWING ON POLY FILM OR LINEN TOWN OF GLASTONBURY 2155 MAIN STREET GLASTONBURY, CT 06033

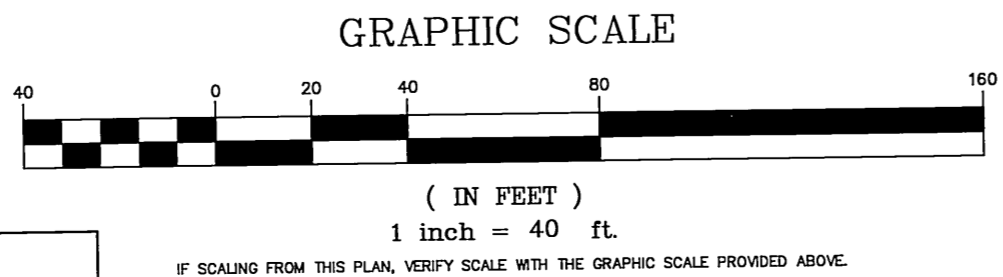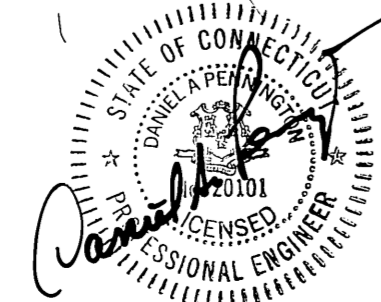

| DRAWING ISSUE STATUS | | |
|----------------------|----------------------------|------------|
| NO. | DESCRIPTION | DATE |
| 3. | ISSUED FOR LANDSCAPING BID | 5/5/2017 |
| 2. | CONDITIONS OF APPROVAL | 3/28/2017 |
| 1. | ISSUED FOR PERMITTING | 12/16/2016 |
| NO. | DESCRIPTION | DATE |

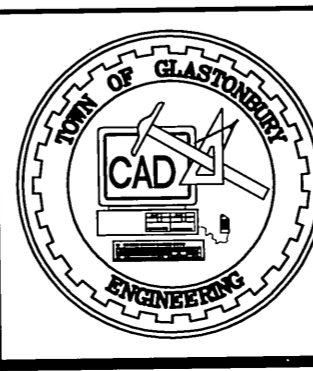

| | |
|--|--------------------|
| SCALE: AS SHOWN | DATE: 11/17/2016 |
| DRAWN BY: C.F.S. | CHECKED BY: S.M.B. |
| APPROVED BY: D.A.P. | 11/17/2016 |
| ST. FILE: | |
| DO NOT SCALE THIS DRAWING. USE THE DIMENSIONS GIVEN. IF THERE ARE ANY DISCREPANCIES OR QUESTIONS, CONTACT THE TOWN OF GLASTONBURY, ENGINEERING OFFICE. | |

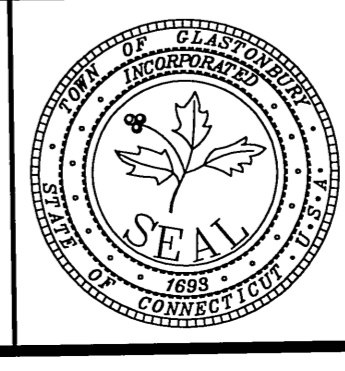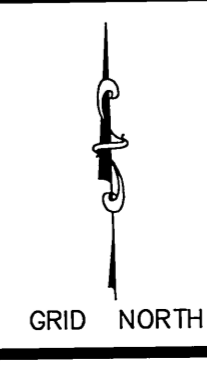

PLAN DEPICTING DEMOLITION
 TOWN HALL / ACADEMY COMPLEX
 DRIVE & PARKING RECONFIGURATION
 LOCATED AT
 2155 / 2143 MAIN STREET
 GLASTONBURY, CONNECTICUT


SHEET NO.
4
 OF 12

ALL UTILITY INFORMATION AND DATA SHOWN OR INDICATED IN THE CONTRACT DOCUMENTS ARE COMPILED FROM MAPS AND DATA FURNISHED BY OTHERS. ANY SUCH INFORMATION SHOULD NOT BE CONSTRUED AS ACCURATE OR COMPLETE AND THE CONTRACTOR SHALL VERIFY ALL LOCATIONS PRIOR TO CONSTRUCTION.

MANUAL REVISIONS TO THIS DOCUMENT ARE PROHIBITED.
 ALL REVISIONS MUST BE PERFORMED ON CADD FILE.
 H:\DWG\Streets\Main ST\PW-0908 ACADEMY SCHOOL SITE IMPROVEMENTS\TownHall-Academy-Filing-2017.dwg

PW-0908

FILE: H:\DWG\Streets\Main St\PW-0908 ACADEMY SCHOOL SITE IMPROVEMENTS\TownHall-Academy-Filing-2017.dwg USER: Charles Stubbler DATE: 5/4/2017

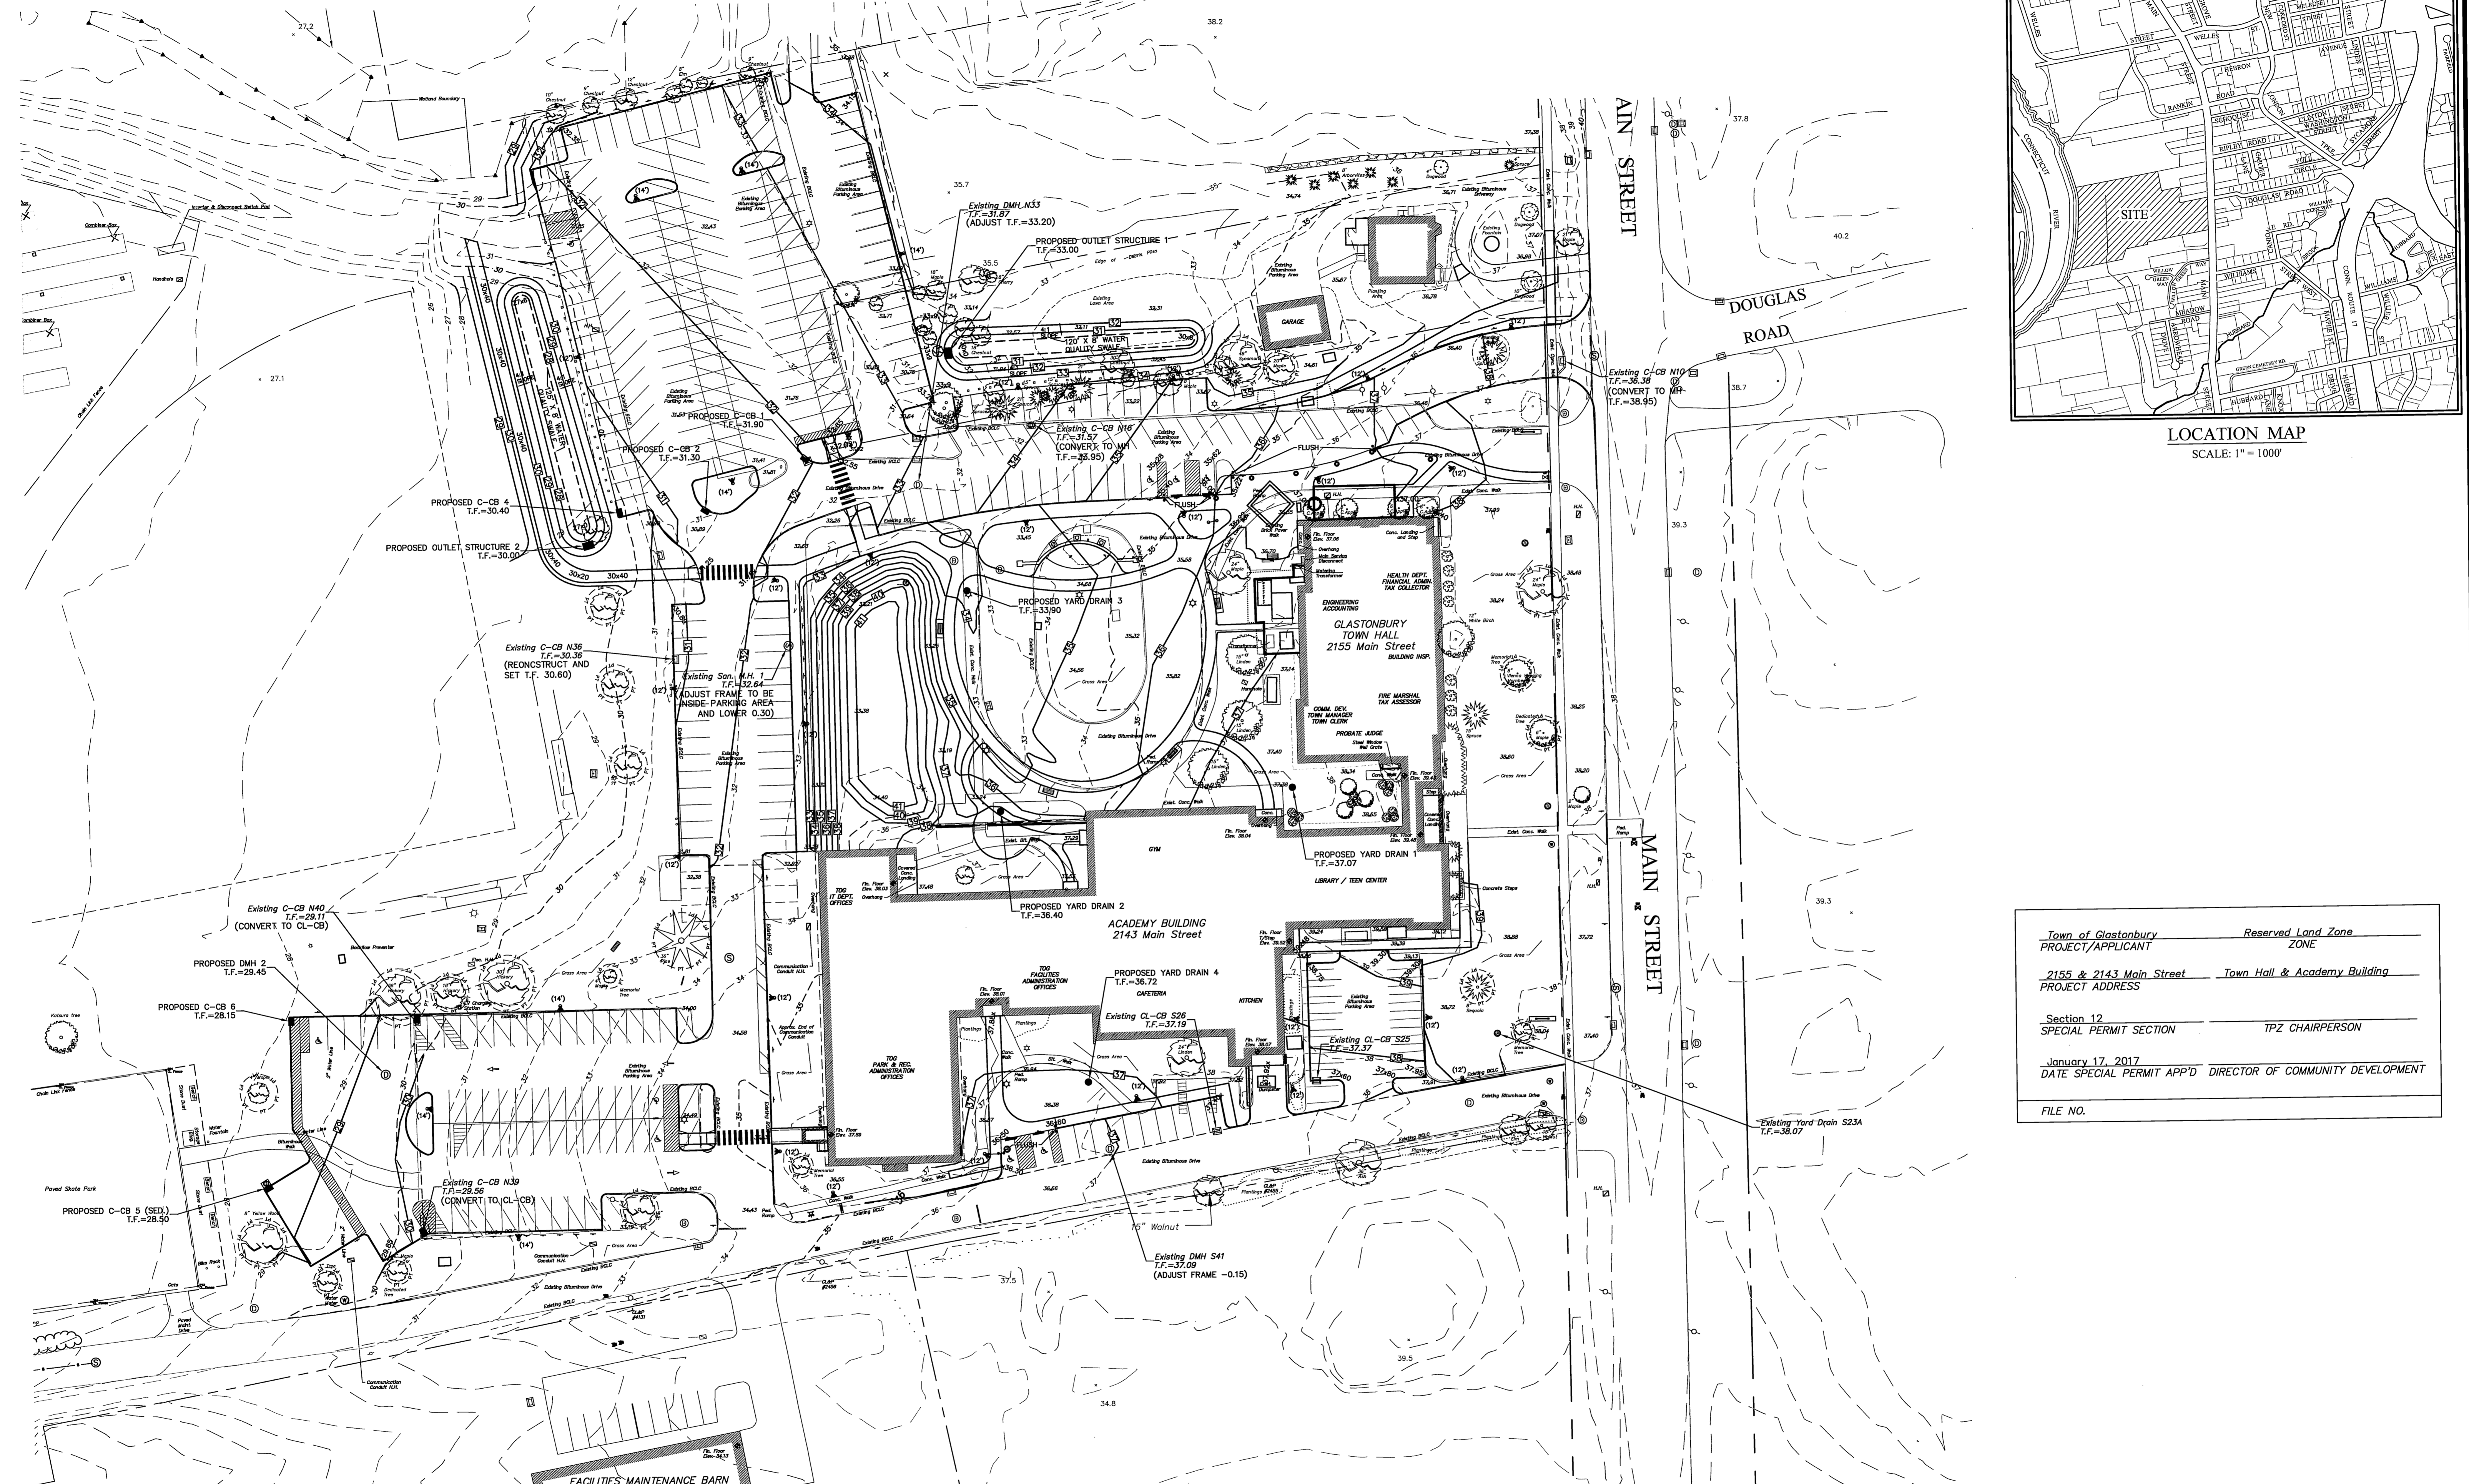



LOCATION MAP
SCALE: 1" = 1000'

Town of Glastonbury Reserved Land Zone
PROJECT/APPLICANT ZONE
2155 & 2143 Main Street Town Hall & Academy Building
PROJECT ADDRESS
Section 12 SPECIAL PERMIT SECTION TPZ CHAIRPERSON
January 17, 2017 DATE SPECIAL PERMIT APP'D DIRECTOR OF COMMUNITY DEVELOPMENT
FILE NO.

FOR INFORMATION ONLY


ALL UTILITY INFORMATION AND DATA SHOWN OR INDICATED IN THE CONTRACT DOCUMENTS ARE COMPILED FROM MAPS AND DATA FURNISHED BY OTHERS. ANY SUCH INFORMATION SHOULD NOT BE CONSTRUED AS ACCURATE OR COMPLETE AND THE CONTRACTOR SHALL VERIFY ALL LOCATIONS PRIOR TO CONSTRUCTION.

THIS MAP PRODUCED BY ORIGINAL INK DRAWING ON POLY FILM OR LINEN TOWN OF GLASTONBURY 2155 MAIN STREET GLASTONBURY, CT 06033

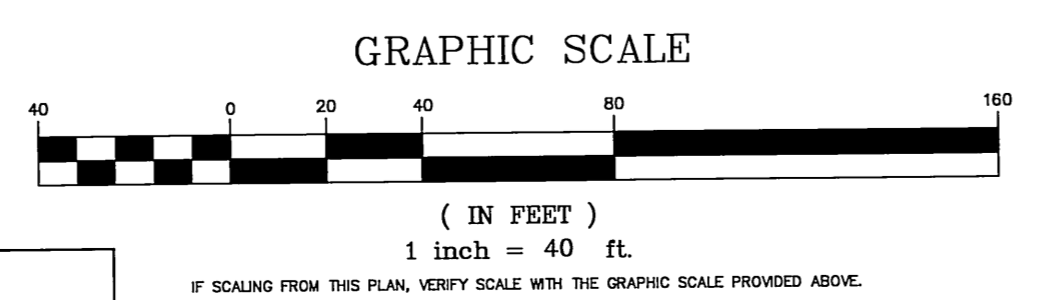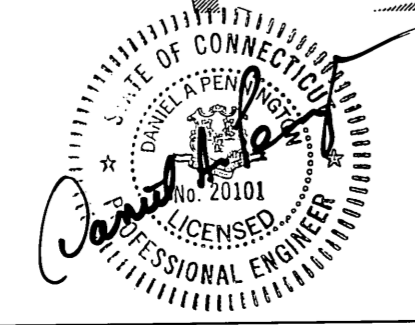


MANUAL REVISIONS TO THIS DOCUMENT ARE PROHIBITED. ALL REVISIONS MUST BE PERFORMED ON CAD FILE. H:\DWG\Streets\Main St\PW-0908 ACADEMY SCHOOL SITE IMPROVEMENTS\TownHall-Academy-Filing-2017.dwg

| DRAWING ISSUE STATUS | | |
|----------------------|----------------------------|------------|
| NO. | DESCRIPTION | DATE |
| 3. | ISSUED FOR LANDSCAPING BID | 5/5/2017 |
| 2. | CONDITIONS OF APPROVAL | 3/28/2017 |
| 1. | ISSUED FOR PERMITTING | 12/16/2016 |

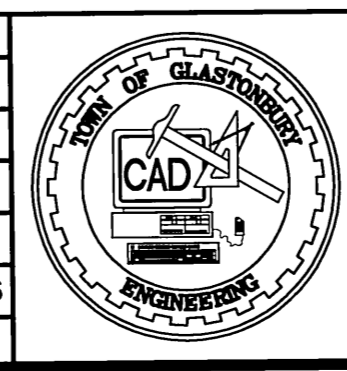

| SCALE: | AS SHOWN | DATE: |
|--------------|----------|------------|
| DRAWN BY: | C.F.S. | 11/17/2016 |
| CHECKED BY: | S.M.B. | 11/17/2016 |
| APPROVED BY: | D.A.P. | 11/17/2016 |

GRID NORTH

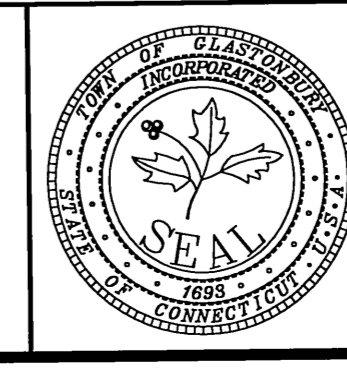

PLAN DEPICTING SITE GRADING
TOWN HALL / ACADEMY COMPLEX
DRIVE & PARKING RECONFIGURATION
LOCATED AT
2155 / 2143 MAIN STREET
GLASTONBURY, CONNECTICUT

SHEET NO.
5
OF 12

PW-0908

FILE # H:\DWG\Streets\Main St\PW-0908 ACADEMY SCHOOL SITE IMPROVEMENTS\TownHall-Academy-Filing-2017.dwg (USER: Charles Strahlbacher DATE: 5/4/2017)



GENERAL SEDIMENTATION AND EROSION CONTROL REQUIREMENTS:

THESE GUIDELINES SHALL APPLY TO ALL WORK CONSISTING OF ANY AND ALL TEMPORARY AND/OR PERMANENT MEASURES TO CONTROL WATER POLLUTION AND SOIL EROSION AS MAY BE REQUIRED, DURING THE CONSTRUCTION OF THE PROJECT.

IN GENERAL, ALL ACTIVITIES SHALL PROCEED IN SUCH A MANNER SO AS NOT TO POLLUTE ANY WETLANDS, WATERCOURSE, WATERBODY, AND CONDUIT CARRYING WATER, ETC. THE DEPARTMENT OF PHYSICAL SERVICES SHALL LIMIT, INsofar AS POSSIBLE, THE SURFACE AREA OF EARTH MATERIALS EXPOSED BY CONSTRUCTION METHODS, AND IMMEDIATELY PROVIDE PERMANENT AND TEMPORARY POLLUTION CONTROL MEASURES TO PREVENT CONTAMINATION OF ADJACENT WETLANDS, WATERCOURSES AND WATERBODIES, AND TO PREVENT, INsofar AS POSSIBLE, EROSION ON THE SITE.

CONSTRUCTION METHODS, IN GENERAL, SHALL BE IN ACCORDANCE WITH THE PROVISIONS SET FORTH IN THE "GUIDELINES FOR SOIL EROSION AND SEDIMENT CONTROL" (2002) BY THE STATE OF CONNECTICUT COUNCIL ON SOIL AND WATER CONSERVATION.

- 1. ALL CONTROL MEASURES SHALL BE INSTALLED AS NOTED ABOVE AND AS SHOWN ON THE PLANS.
- 2. ALL CONTROL MEASURES SHALL BE INSPECTED AND APPROVED BY THE ENGINEER PRIOR TO COMMENCEMENT OF ANY WORK, INCLUDING PRE-CONSTRUCTION CLEARING AND GRUBBING.
- 3. ALL CONTROL MEASURES SHALL BE MAINTAINED AND UPGRADED AS REQUIRED TO ACHIEVE PROPER SEDIMENT CONTROL THROUGHOUT THE CONSTRUCTION PERIOD AND UNTIL DISTURBED AREAS HAVE BEEN THOROUGHLY STABILIZED.
- 4. NO CONTROL MEASURES SHALL BE REMOVED WITHOUT APPROVAL FROM THE ENGINEER.
- 5. ADDITIONAL CONTROL MEASURES SHALL BE INSTALLED DURING THE CONSTRUCTION PERIOD IF DEEMED NECESSARY BY THE ENGINEER.
- 6. THE LIMITS OF CLEARING, GRADING AND DISTURBANCE, AS SHOWN ON THE PLANS(S), SHALL BE KEPT TO A MINIMUM WITHIN THE APPROVED AREA OF CONSTRUCTION. ALL AREAS OUTSIDE THE LIMITS OF CLEARING SHALL REMAIN TOTALLY UNDISTURBED.
- 7. ANY CONTROL MEASURES RETAINING SEDIMENT OVER 1/2 THEIR HEIGHT SHALL HAVE THE SEDIMENT IMMEDIATELY REMOVED, AND ALL DAMAGED CONTROL MEASURES SHALL BE REMOVED AND REPLACED.
- 8. ALL NEW AND EXISTING CATCH BASINS LOCATED WITHIN THE PROJECT LIMITS SHALL BE PROTECTED WITH A SEDIMENTATION CONTROL SYSTEM IN GRASSED AREAS OR WITH A SEDIMENTATION CONTROL SACK IN PAVED AREAS UNTIL ALL DISTURBED AREAS HAVE BEEN THOROUGHLY STABILIZED.
- 9. SEDIMENT REMOVED FROM CONTROL MEASURES AND DRAINAGE FACILITIES SHALL BE DISPOSED OF IN A MANNER THAT IS CONSISTENT WITH STATE AND LOCAL REGULATIONS.
- 10. THE PLANTING SEASONS FOR THE SPECIFIED SEED MIXTURE SHALL BE AS DEFINED IN THE 2002 CONNECTICUT GUIDELINES FOR SOIL EROSION AND SEDIMENT CONTROL, UNLESS DIRECTED OTHERWISE BY THE TOWN ENVIRONMENTAL PLANNER. OUTSIDE OF THESE SPECIFIED DATES, AREAS WILL BE STABILIZED WITH HAY BALE CHECK DAMS, FILTER FABRIC, OR WOOD CHIP MULCH AS REQUIRED TO CONTROL EROSION.

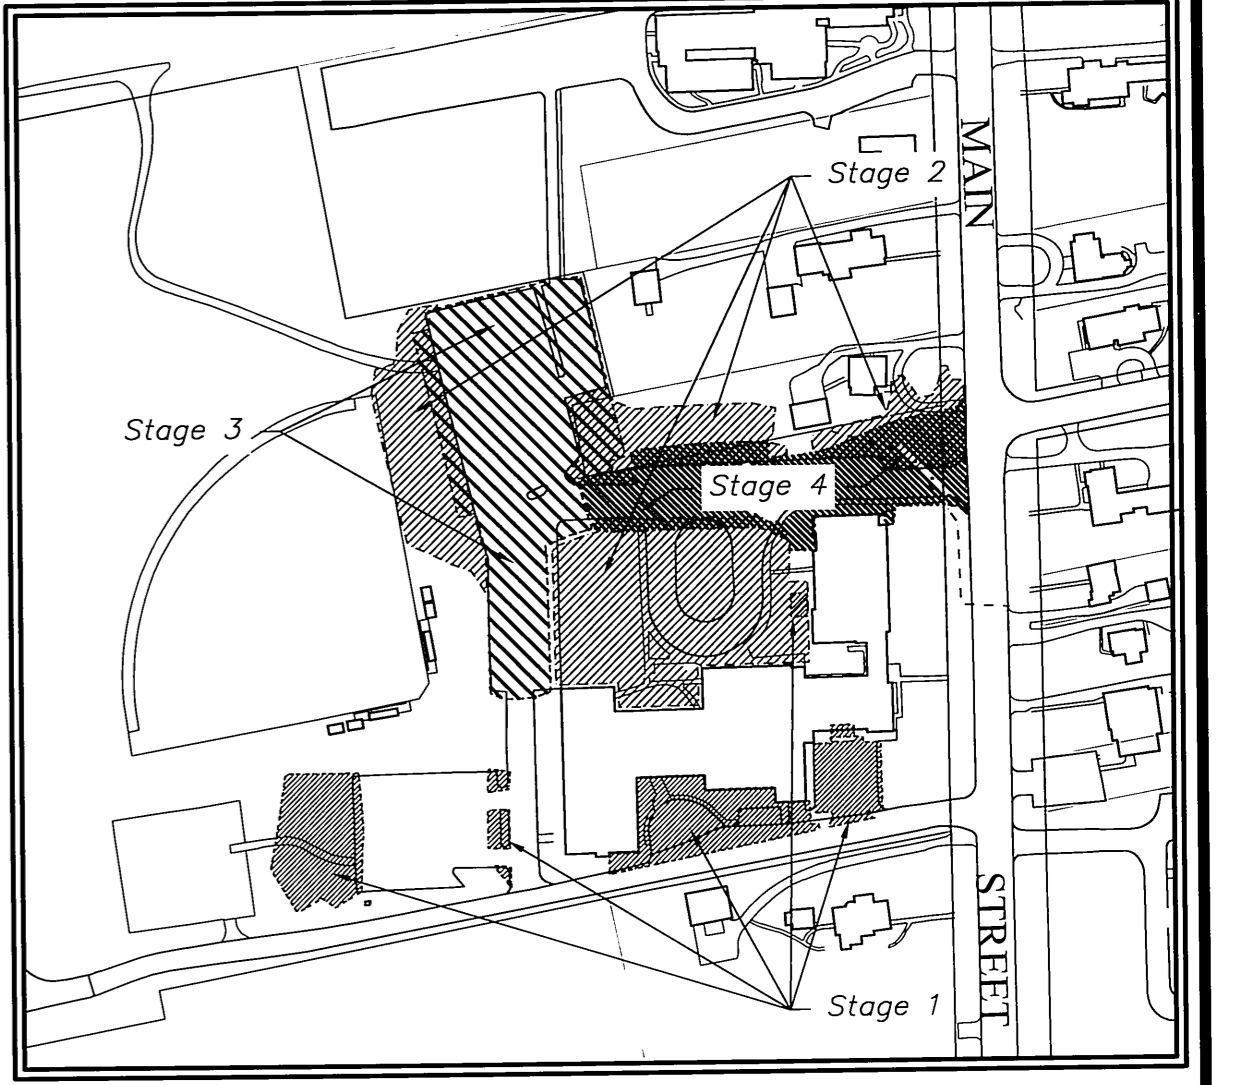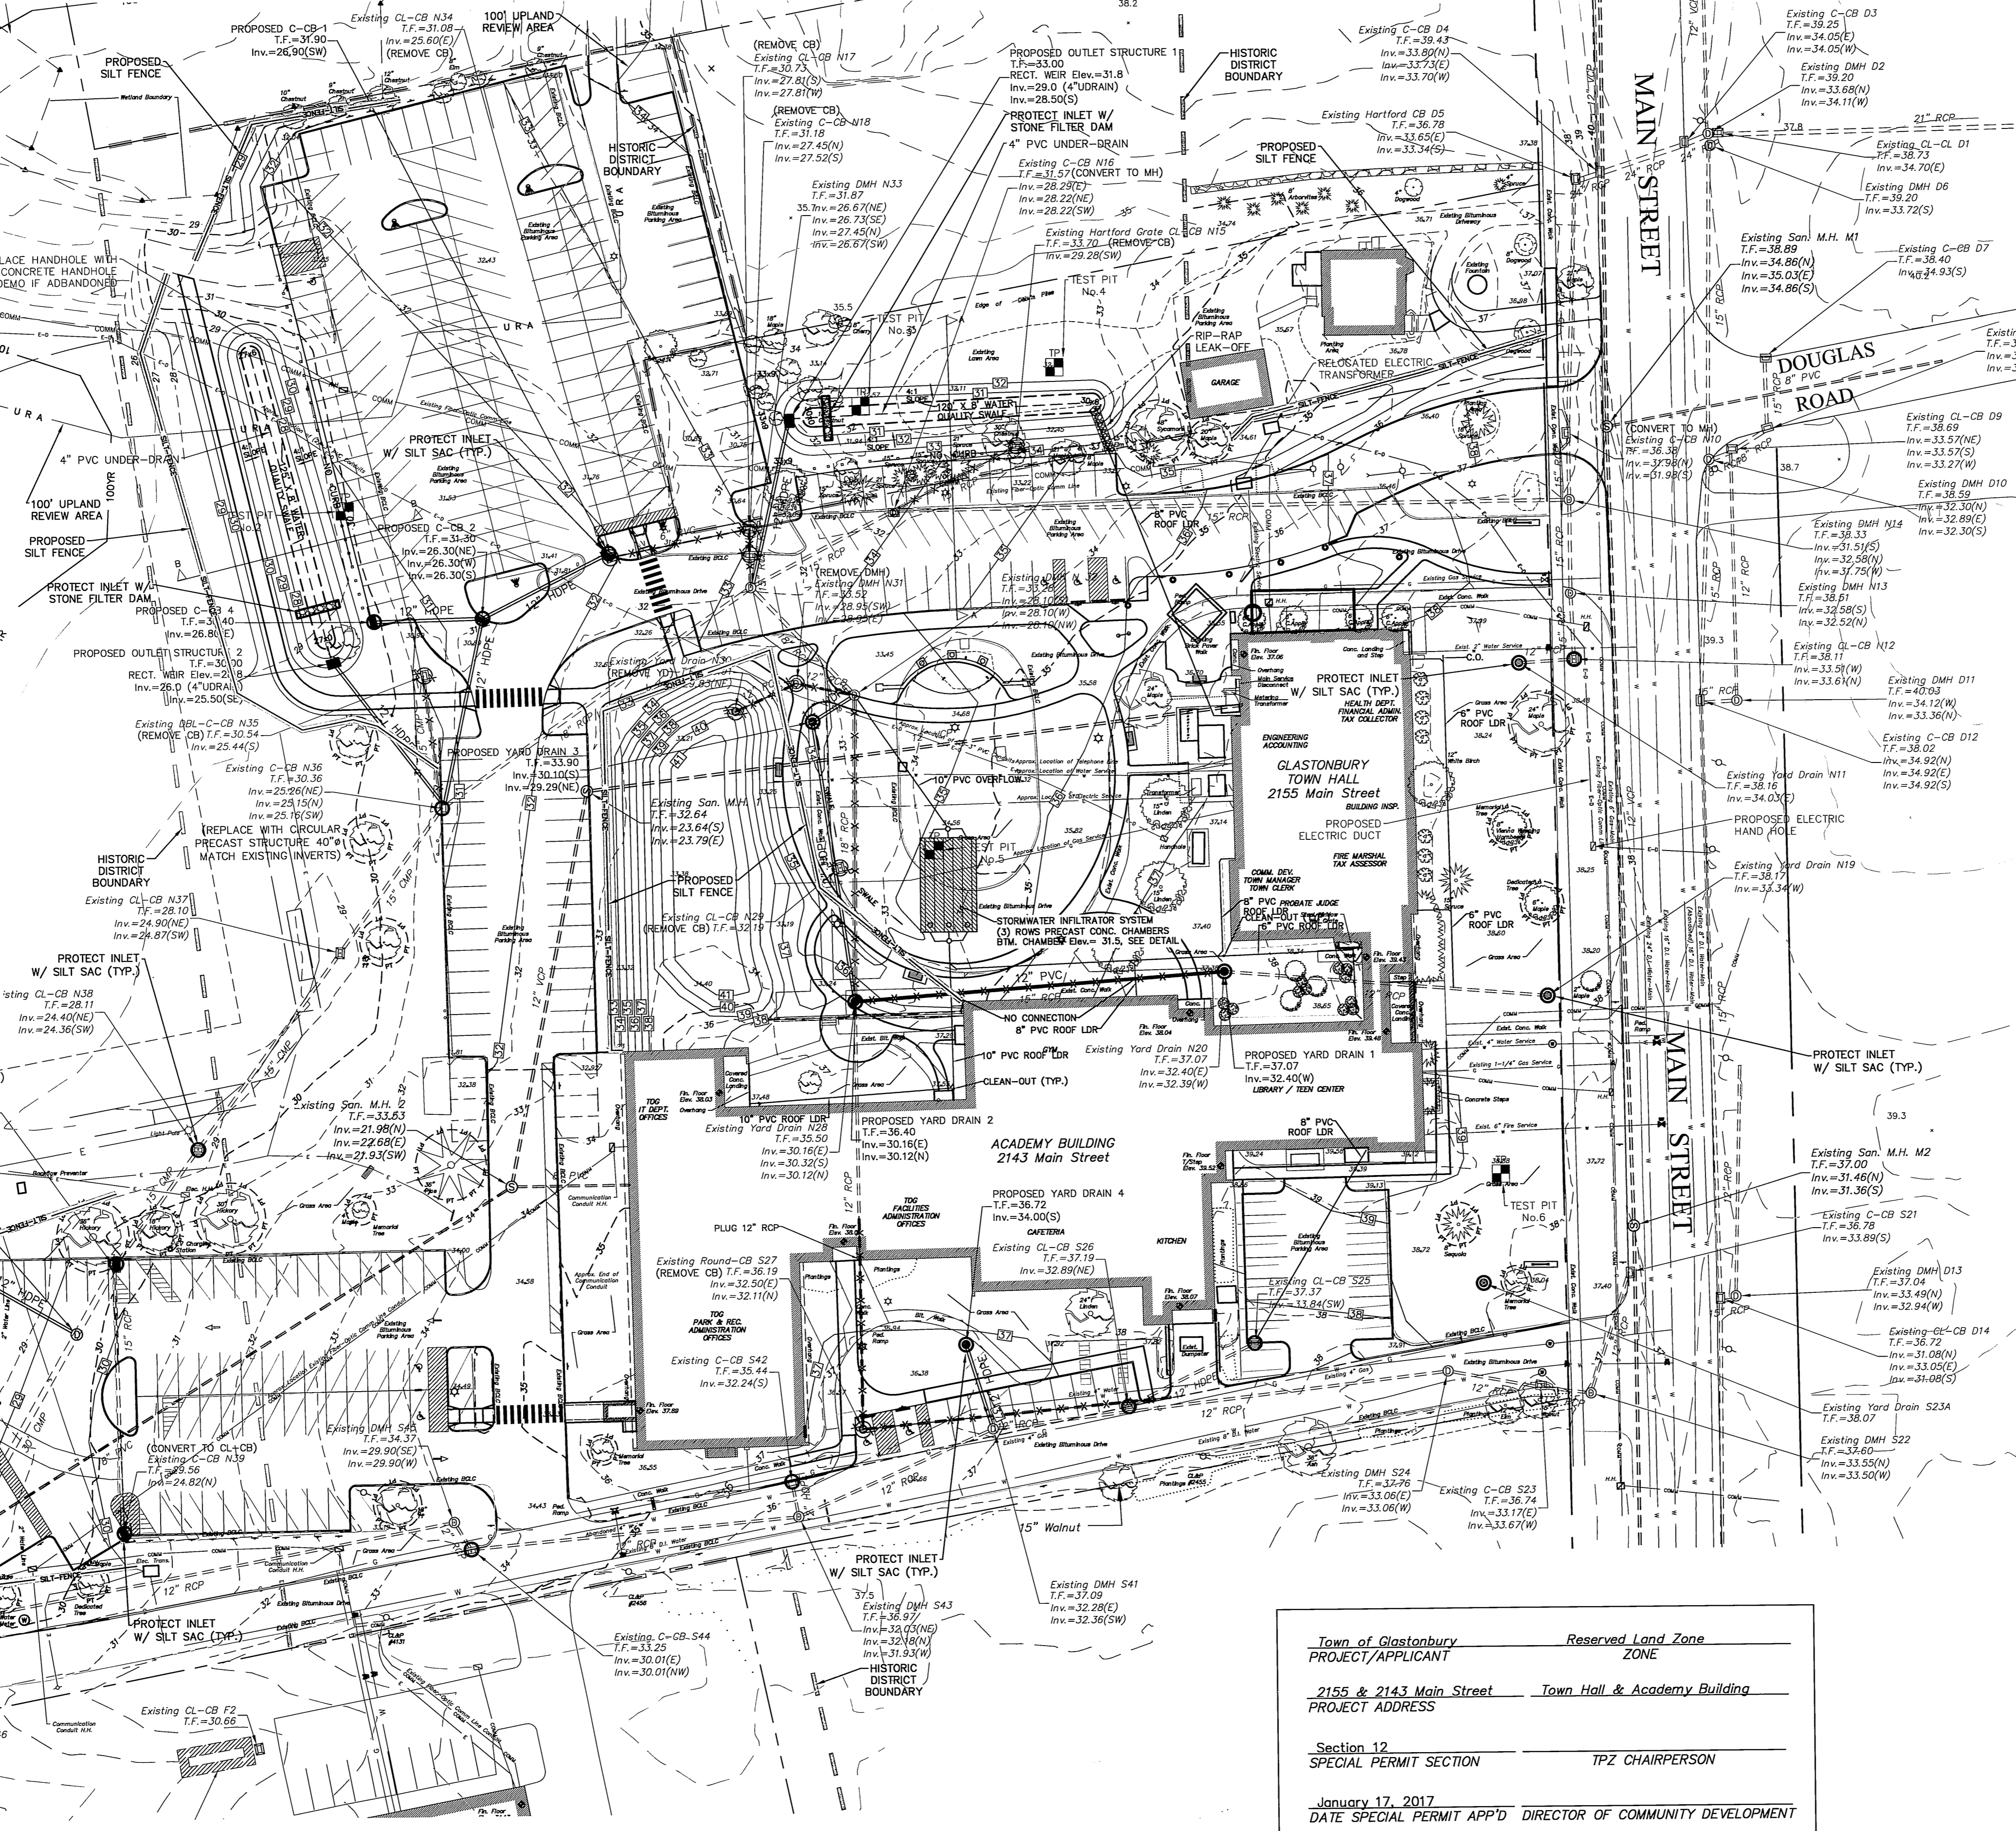

PHASE MAP
SCALE: 1 INCH = 200 FEET

PROJECT NARRATIVE:
THE TOWN HALL SITE IMPROVEMENT PROJECT INCLUDES THE INSTALLATION OF AN 1,000 SQUARE FOOT BUILDING ADDITION ON THE NORTH SIDE OF TOWN HALL AS WELL AS RECONFIGURATION / RECONSTRUCTION OF PARKING LOT, DRIVEWAY, AND SIDEWALK AREAS TO ADDRESS POOR PAVEMENT CONDITIONS, PROVIDE ADDITIONAL PARKING, AND IMPROVE TRAFFIC FLOW THROUGH THE SITE. ALSO INCLUDED IN THE PROJECT IS RELOCATION OF THE NORTHERLY SITE DRIVEWAY TO ALIGN OPPOSITE DOUGLAS ROAD, AND REMOVAL OF THE LOOP DRIVEWAY BEHIND TOWN HALL AND REPLACEMENT WITH A LAWN AREA. DRAINAGE IMPROVEMENTS ASSOCIATED WITH THE PROJECT INCLUDE AN UNDERGROUND INFILTRATION SYSTEM FOR ROOF WATER FROM THE ACADEMY BUILDING AND PART OF TOWN HALL, AND TWO STORMWATER QUALITY SWALES AND A PERFORATED PIPE INfiltrATION SYSTEM TO PROVIDE TREATMENT OF STORMWATER RUNOFF FROM PARKING LOT AREAS. THE TOTAL ESTIMATED AREA OF DISTURBANCE FOR THE PROJECT IS 4.5 ACRES.

CONSTRUCTION SEQUENCE:

- 1. SITE PREPARATION: INSTALL PERIMETER EROSION AND SEDIMENT CONTROLS AND PROTECT INLETS WITH SILT SACKS. PROTECT TREES IDENTIFIED FOR PROTECTION WITH ORANGE CONE WORK WITH TREE WARDEN TO POST 10-DAY NOTICE FOR ANY TREES OR SHRUBS TO BE REMOVED. REMOVE TREES, SHRUBS, AND STUMPS WITHIN THE LIMITS OF CONSTRUCTION AS INDICATED ON THE PLANS. REMOVE AND DISPOSE OF EXISTING UNDERGROUND OIL TANKS AS SHOWN ON THE PLANS.
- 2. STAGE 1: CONSTRUCT IMPROVEMENTS ON THE SOUTHERLY PORTION OF THE SITE, INCLUDING PARKING LOT EXPANSION NEAR SKATE PARK, PARKING AND SIDEWALK AT FACILITIES ENTRANCE, AND RECONSTRUCTED PARKING LOT AND SIDEWALKS NEAR TEEN CENTER ENTRANCE. CLOSE SOUTHERLY DRIVEWAY AS NEEDED TO FACILITATE CONSTRUCTION, REROUTE TRAFFIC TO NORTHERLY DRIVEWAY. INSTALL PROPOSED DRAINAGE, CONDUITS AND FOUNDATIONS FOR SITE LIGHTING. STRIP EXISTING PAVEMENT FROM TEEN CENTER PARKING LOT, FINE GRADE, PAVE ALL THREE SOUTHERLY PARKING LOT AREAS, STRIPE PAVEMENT MARKINGS, INSTALL SIGNS, AND RELOCATE DUMPSTERS TO DESIGNATED AREA NEAR SKATE PARK. TOPSOIL AND SEED DISTURBED AREAS.
- 3. STAGE 2: BEGUN WORK ON NORTHERLY PORTION OF THE SITE ON AREAS OUTSIDE LIMITS OF EXISTING PAVEMENT AND WITHIN TOWN HALL LOOP DRIVEWAY. INSTALL NEW TRANSFORMER FOUNDATION AND CONDUITS FOR UNDERGROUND ELECTRIC SERVICE TO MAIN STREET. CONSTRUCT STORMWATER QUALITY SWALES, INCLUDING UNDERDRAINS AND OUTLET STRUCTURES. IMMEDIATELY TOPSOIL AND SEED THESE AREAS TO COMPLETELY ESTABLISH VEGETATION PRIOR TO ALLOWING STORMWATER INTO THE SWALES. PROTECT OUTLET STRUCTURES WITH STONE BERM. CLOSE TOWN HALL LOOP DRIVEWAY TO TRAFFIC. PERFORM FULL DEPTH CONSTRUCTION (TO SUBBASE COURSE) FOR NEW PARKING AND DRIVEWAY AREAS ON THE NORTHERLY PORTION OF THE SITE THAT ARE OUTSIDE THE LIMITS OF EXISTING PAVEMENT, INCLUDING AREAS ADJACENT TO STORMWATER QUALITY SWALES. PROTECT EXISTING BITUMINOUS CURB ADJACENT TO SWALES TO PREVENT PARKING LOT STORMWATER FROM ENTERING THE SWALES UNTIL FULL VEGETATION IS ESTABLISHED. DEMOLISH DRAINAGE STRUCTURES, SIDEWALKS, AND RETAINING WALL IN AREA OF TOWN HALL LOOP DRIVEWAY AND FORMER D-WING AREA. INSTALL NEW DRAINAGE AND CONDUITS FOR SITE LIGHTING WITHIN WORK AREA LIMITS. BORROW MATERIAL AND ROUGH GRADE BOSK BERM AND PROPOSED LAWN AREA WITHIN FORMER LOOP DRIVE.
- 4. STAGE 3: CONSTRUCT IMPROVEMENTS TO NORTHWESTERN STAFF PARKING LOT AND PARKING LOT ADJACENT TO BOSK BERM (BEHIND FORMER D-WING). INSTALL NEW DRAINAGE STRUCTURES / PIPES, CONDUITS AND FOUNDATIONS FOR SITE LIGHTING. CONSTRUCT NEW CONCRETE SIDEWALKS AND RAMPS WITHIN THESE LIMITS OF CONSTRUCTION. PERFORM FULL DEPTH PAVEMENT RECLAMATION OF THE PARKING LOT AREAS. FINE GRADE PARKING LOTS, STOCKPILE EXCESS BASE MATERIAL FOR USE IN STAGE 4. PAVE PARKING AREAS, TOPSOIL AND SEED DISTURBED AREAS, INSTALL PAVEMENT MARKINGS AND SIGNS WITHIN LIMITS OF THIS STAGE.
- 5. STAGE 4: CLOSE NORTHERLY DRIVEWAY, ESTABLISH WORK AREA FOR BUILDING CONSTRUCTION. MAINTAIN ACCESS TO EMPLOYEE STAFF PARKING LOT AT THE NORTHWEST PORTION OF THE SITE. INSTALL BUILDING FOUNDATION AND CONSTRUCT BUILDING ADDITION. RECONSTRUCT NORTHERLY DRIVEWAY AND ADJACENT PARKING AREAS FULL DEPTH, INCLUDING SIDEWALKS AND GRANITE CURB. DEMOLISH EXISTING DRAINAGE STRUCTURES AND PIPES DESIGNATED FOR REMOVAL ON THE PLANS AND INSTALL NEW DRAINAGE STRUCTURES AND PIPING. PROTECT NEW INLETS WITH SILT SACKS AS SHOWN ON THE PLANS. DEMOLISH SIDEWALKS, LOOP DRIVEWAY, AND RETAINING WALL AND GRADE AREA TO FINISH LAWN ELEVATION. INSTALL PRECAST CONCRETE FOUNDATIONS AND CONDUITS FOR SITE LIGHTING AS SHOWN ON THE PLANS. INSTALL ANY OTHER UTILITY SERVICES REQUIRED FOR THE PROPOSED BUILDING ADDITION. INSTALL NEW SIDEWALKS AND PAVED PATIOS IN PROPOSED LAWN AREA. INSTALL FINAL PAVEMENT MARKINGS AND SIGNS. INSTALL SITE LIGHT FIXTURES AS SHOWN ON THE PLANS. TOPSOIL AND SEED ALL DISTURBED AREAS. INSTALL LANDSCAPING THROUGHOUT PROJECT LIMITS.

PROJECT SPECIFIC SEDIMENTATION AND EROSION CONTROL PLAN



- CONSTRUCTION ACTIVITIES OF CONCERN RELATIVE TO THE PROTECTION OF ADJACENT WETLANDS AND WATERCOURSES FROM SEDIMENTATION ARE AS FOLLOWS:
- 1. DEWATERING: OPEN TRENCH EXCAVATIONS WILL NEED TO BE DEWATERED AS NECESSARY FOR PROPER INSTALLATION OF THE PROPOSED PIPES. IN THESE AREAS, ALL EXCAVATED MATERIAL SHALL BE ADEQUATELY TREATED PRIOR TO DISCHARGE USING MEASURES DESCRIBED IN SECTION 5-13 OF THE 2002 CT GUIDELINES FOR EROSION AND SEDIMENT CONTROL. THIS MAY INCLUDE A STONE SUMP AND STANDPIPE FOR PUMP INTAKE PROTECTION, AND A DIRT BAG OR PUMPING SETTLING BASIN FOR TREATMENT OF THE PUMPED WATER PRIOR TO DISCHARGE.
 - 2. STOCKPILING: EXCAVATED MATERIAL SHALL NOT BE STOCKPILED ADJACENT TO STORM DRAIN INLETS, WETLANDS, OR WATERCOURSES. WHEN IT IS NECESSARY BASED ON THE PROPOSED METHODS OF CONSTRUCTION TO STAGE EXCAVATED MATERIAL FOR SHORT DURATIONS IN THE VICINITY OF STORM DRAIN INLETS, THESE INLETS SHALL BE PROPERLY PROTECTED AS DESCRIBED ON THE PLANS. LONGER DURATION STOCKPILING OF MATERIAL, WHEN NECESSARY, SHALL BE ONLY IN LOCATIONS APPROVED IN ADVANCE BY THE ENGINEER, AND SUCH STOCKPILES SHALL BE RINGED WITH A SEDIMENTATION CONTROL SYSTEM.
 - 3. DISTURBED AREAS: LIMITS OF DISTURBANCE SHALL BE IN STRICT ACCORDANCE WITH THE APPROVED PLAN. ALL AREAS DISTURBED BY CONSTRUCTION SHALL BE STABILIZED WITHIN THE SAME PERIOD OF CONSTRUCTION AS SOON AS POSSIBLE AFTER CONSTRUCTION ACTIVITIES ARE COMPLETED. DISTURBED AREAS WITH STEEP OR LONG SLOPES AND OTHER AREAS WITH SIGNIFICANT POTENTIAL FOR CAUSING SEDIMENTATION SHALL BE PROTECTED WITH TEMPORARY STRAW MULCH, WOOD CHIPS, EROSION CONTROL MATTING, OR OTHER SUITABLE MATERIALS PRIOR TO SIGNIFICANT FORECASTED RAIN STORM EVENTS TO REDUCE EROSION POTENTIAL.
 - 4. DRAINAGE WAYS: CONSTRUCTION OF DITCHES, CHANNELS, THAT ACTIVELY CONVEY FLOW SHALL BE PERFORMED SUCH THAT THE PORTION OF DRAINAGE WAY DISTURBED DURING A GIVEN DAY IS COMPLETED WITH THE PERMANENT LINING BY DAYS END, OR OTHERWISE AS NECESSARY TO PROVIDE FOR TEMPORARY BYPASS OF STORMWATER AND ENSURE THAT DOWNSTREAM WETLAND AREAS ARE PROTECTED FROM SEDIMENTATION AND EROSION OF THE CHANNEL.
 - 5. SEVERE WEATHER CONTINGENCY PLAN: IN ADVANCE OF A SEVERE WEATHER EVENT, ALL EROSION CONTROLS DESCRIBED ABOVE AND ELSEWHERE ON THE PLANS SHALL BE INSPECTED AND ADJUSTED AS NECESSARY.

RESPONSIBLE PARTIES:
THE DEPARTMENT OF PHYSICAL SERVICES SHALL PROVIDE A REPRESENTATIVE WHO IS RESPONSIBLE FOR IMPLEMENTING THE EROSION AND SEDIMENTATION CONTROL PLAN. THIS INCLUDES THE INSTALLATION AND MAINTENANCE OF ALL CONTROL MEASURES, INFORMING ALL PARTIES ENGAGED ON THE CONSTRUCTION SITE OF THE REQUIREMENTS AND OBJECTIVES OF THE PLAN.

Town of Glastonbury
PROJECT/APPLICANT
2155 & 2143 Main Street
PROJECT ADDRESS
Town Hall & Academy Building
Section 12
SPECIAL PERMIT SECTION
TPZ CHAIRPERSON
January 17, 2017
DATE SPECIAL PERMIT APP'D DIRECTOR OF COMMUNITY DEVELOPMENT
FILE NO.

FOR INFORMATION ONLY

THIS MAP PRODUCED BY ORIGINAL INK DRAWING ON POLY FILM OR LINEN TOWN OF GLASTONBURY 2155 MAIN STREET GLASTONBURY, CT 06033

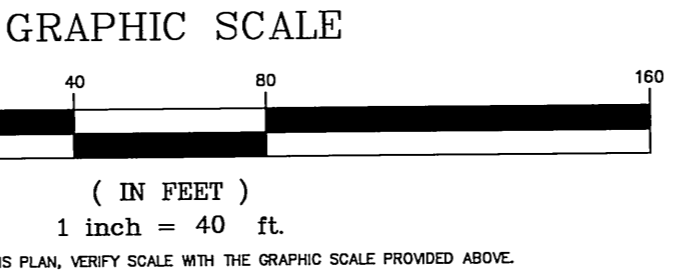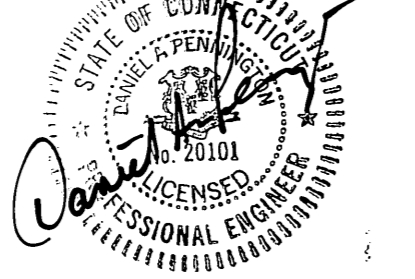


ALL UTILITY INFORMATION AND DATA SHOWN OR INDICATED IN THE CONTRACT DOCUMENTS ARE COMPILED FROM MAPS AND DATA FURNISHED BY OTHERS. ANY SUCH INFORMATION SHOULD NOT BE CONSIDERED AS COMPLETE OR ACCURATE AND THE CONTRACTOR SHALL VERIFY ALL LOCATIONS PRIOR TO CONSTRUCTION.

MANUAL REVISIONS TO THIS DOCUMENT ARE PROHIBITED.
ALL REVISIONS MUST BE PERFORMED ON CADD FILE.
H:\DWG\Streets\Main St\PW-0908 ACADEMY SCHOOL SITE IMPROVEMENTS\TownHall-Academy-Filing-2017.dwg


PW-0908

| NO. | DESCRIPTION | DATE |
|-----|----------------------------|------------|
| 3. | ISSUED FOR LANDSCAPING BID | 5/5/2017 |
| 2. | CONDITIONS OF APPROVAL | 3/28/2017 |
| 1. | ISSUED FOR PERMITTING | 12/16/2016 |

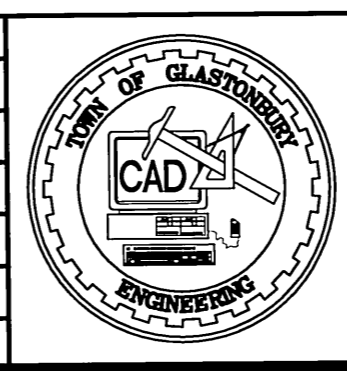

| SCALE: AS SHOWN | DATE: |
|---------------------|------------|
| DRAWN BY: C.F.S. | 11/18/2016 |
| CHECKED BY: S.M.B. | 11/18/2016 |
| APPROVED BY: D.A.P. | 11/18/2016 |

ST. FILE:
DO NOT SCALE THIS DRAWING. USE THE DIMENSIONS GIVEN. IF THERE ARE ANY DISCREPANCIES OR QUESTIONS, CONTACT THE TOWN OF GLASTONBURY, ENGINEERING OFFICE.

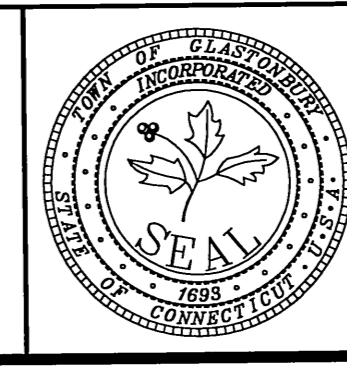

EROSION AND SEDIMENTATION CONTROL AND PHASING PLAN
TOWN HALL / ACADEMY COMPLEX DRIVE & PARKING RECONFIGURATION
LOCATED AT
2155 / 2143 MAIN STREET
GLASTONBURY, CONNECTICUT
SHEET NO. 7 OF 12

NOTES:

- PRECAST CATCH BASIN TOPS MUST BE PROPERLY ALIGNED AS SHOWN AND SHALL CONFORM TO CONDOT STANDARD DETAIL SHEETS 507-A AND 507-B. CAPE COD CATCH BASIN TOPS SHALL HAVE AN OPEN FRONT.
- ALL FRAMES AND GRATES SHALL BE GALVANNEZED. FOR DETAILS OF FRAMES AND GRATES, SEE CONDOT STANDARD DETAIL SHEETS 507-D AND 507-E.
- DOUBLE CATCH BASINS SHALL CONFORM TO CONDOT STANDARD DETAIL SHEETS 507-D AND 507-E.
- WHEN TYPE 'C' CATCH BASINS ARE CONSTRUCTED IN PARALLEL TO THE NORMAL GUTTER OF THE ROADWAY, THE NORMAL GUTTER OF THE ROADWAY SHALL BE VARED TO PROVIDE AN ADDITIONAL 1/8" DEEP DEPRESSION GUTTER AT THE CATCH BASIN.
- WALL THICKNESS TO BE 12 INCHES WHEN HEIGHT OF STRUCTURE EXCEEDS 10 FEET FROM TOP OF FRAME TO BOTTOM OF BASE.
- CATCH BASINS LEFT ABOVE THE FINISHED GUTTER GRADE FOR THE WATER MUST BE PROPERLY SHIMMED FOR PLUMB AS SHOWN IN PLATE 4.
- MORTAR MIX SHALL NOT CONTAIN LIME.
- SIZE OF PIPE SHALL BE SAWCUT FLUSH WITH INSIDE WALLS.
- IF CONCRETE MASONRY UNITS ARE USED THE FOLLOWING ADDITIONAL REQUIREMENTS SHALL BE OBSERVED:
 - MAXIMUM CORREL SHALL NOT EXCEED 2"
 - WHERE NECESSARY, BLOCKS MAY BE CUT OR CONCRETE BRICK USED (NO RED BRICK PERMITTED).
 - CORNERS SHALL BE SQUARE, COURSES LEVEL, AND JOINTS PROPERLY STAGGERED.
 - RODS IN EXTERIOR WALLS SHALL BE GROUTED, AND CORBELS SHALL BE GROUTED.

SCALE: NONE
TOWN OF GLASTONBURY
 DEPARTMENT OF PHYSICAL SERVICES
 ENGINEERING DIVISION
CATCH BASIN
 PLATE NO. 21

NOTES:

- BAFFLE CONSTRUCTION TO BE OF CAST MATERIAL WITH THRU HOLES ABOVE OUTLET FLOW LINE OR MORTARED CEMENT BLOCKS WITH WEEP HOLES ABOVE OUTLET FLOW LINE.
- ADJUST M.A. FRAME TO SUIT REQUIRED FIGHT HEIGHT.
- CONSTRUCTION JOINT - SEALED WITH 1" DIA. BUTYL RUBBER OR ACCEPTABLE EQUIVALENT.
- DESIGN LOADING - AASHTO HS20-44.
- STEEL REINFORCEMENT - ASTM A-615-75, GRADE 60, 2" MIN. COVER.
- CONCRETE MINIMUM STRENGTH - 5,000 P.S.I. @ 28 DAYS.
- MAXIMUM HEIGHT OF EACH ADDITIONAL PIECE 4'-0".
- MAXIMUM INSIDE HEIGHT FOR 2 PIECE CHAMBER 8'-0".
- ROOF AND SIDE WALL OPENINGS AS SPECIFIED.

SCALE: NONE
TOWN OF GLASTONBURY
 DEPARTMENT OF PHYSICAL SERVICES
 ENGINEERING DIVISION
SEDIMENTATION STRUCTURE
 PLATE NO. 22

NOTES:

- FRAME & COVER TO BE HEAVY DUTY TOTAL WEIGHT APPROX. 60 LBS.
- ALL SURFACES TO BE MACHINE FINISHED.
- LABORON FOUNDRY L105 S OR CAMPBELL FOUNDRY 1221 5012 OR EQUAL.
- STORM COVER MUST HAVE "STORM" OR "DRAIN" EMBOSSED ON IT.
- MANHOLE FRAMES WITH 24" I.D. FLANGES MAY BE USED ON STRUCTURES THAT ARE NOT MANHOLES (E.G. SEW. STRUCTURE, FIRE TANK, CB CONVERSIONS, ETC.)

SCALE: NONE
TOWN OF GLASTONBURY
 DEPARTMENT OF PHYSICAL SERVICES
 ENGINEERING DIVISION
MANHOLE FRAME AND COVER
 PLATE NO. 33

NOTES:

- PERFORATIONS TO BE PLACED UP OR DOWN AS SPECIFIED BY THE ENGINEER.
- HOLES ARE TO BE 1/2" DIA. OR 3/8" DIA.
- PIPE SHALL BE MIN. 6" DIA.
- SLOTTED REINFORCED CONC. PIPE (SRCP) CAN BE USED AS A COMBINED STORM AND UNDERDRAIN SYSTEM.
- ALL UNDERDRAIN TO BE OUTLETTED DIRECTLY INTO A CATCH BASIN. THE TOP OF THE UNDERDRAIN PIPE IS TO MATCH THE TOP OF THE OUTLET PIPE.
- INCLUDE CLEANOUTS AT SPACING NOT TO EXCEED 150 FEET.

SCALE: NONE
TOWN OF GLASTONBURY
 DEPARTMENT OF PHYSICAL SERVICES
 ENGINEERING DIVISION
TRENCH FOR STORM DRAIN AND UNDER DRAIN
 PLATE NO. 20

NOTES:

- CONCRETE WING TO BE SLOPED AS FOLLOWS:
 - USE 1/12 TO 2 INCHES PER FOOT WHERE GRASS STRIP SEPARATES SIDEWALK FROM CURB.
 - USE 1 INCH PER FOOT MAX. WHERE SIDEWALK ADJUTS CURB.
- DETECTABLE WARNING STRIP SHALL BE PREPARED SURFACE TILE AS MANUFACTURED BY ENGINEERED PLASTICS INC., ADA FABRICATORS INC. OR APPROVED EQUAL. TILE SHALL BE BRICK RED IN COLOR.

SCALE: NONE
TOWN OF GLASTONBURY
 DEPARTMENT OF PHYSICAL SERVICES
 ENGINEERING DIVISION
CONCRETE SIDEWALK RAMPS
 PLATE NO. 7

NOTES:

- CONCRETE SHALL BE CONDOT CLASS F, (4,000 PSI, 28 DAY STRENGTH).
- FORMS ARE TO BE SET TRUE TO LINE AND GRADE ON WELL COMPACTED BASE. FORMS SHALL BE 2" STEEL OR 2"x4" LUMBER.
- PROPER FINISHING PROCEDURES WILL BE FOLLOWED INCLUDING JOINTING, EDGING, AND BROOMING. A FINE BRISTLE BROOM SHOULD BE USED. ALL EDGING TOOL IMPRINTS SHOULD BE STEEL TROWELED PRIOR TO BROOMING.
- CURING COMPOUND MAY BE REQUIRED AS DIRECTED BY THE ENGINEER.
- CONTRACTOR SHALL TAKE ALL NECESSARY PRECAUTIONS TO PROTECT SURFACE FROM DAMAGE.
- WALKS SHALL BE BACKFILLED AS SOON AS FORMS ARE REMOVED.
- ALL CONCRETE SIDEWALK SLABS SHALL BE RECTANGULAR IN SHAPE. NO FIGURE 1 SLABS ARE TO BE CONSTRUCTED.
- SIDEWALK SLABS SHOULD NOT EXCEED 5' IN WIDTH IF SIDEWALK SLABS GREATER THAN 5' IN WIDTH ARE TO BE CONSTRUCTED. A LONGITUDINAL EXPANSION JOINT SHALL BE CONSTRUCTED TO FORM ACCEPTABLE SLABS.
- INSERT 1/4" LONG SMOOTH METAL DOWELS AT ALL EXPANSION JOINTS, AT SEWER RAMP AND AT THE END OF EACH SLAB. DOWELS SHALL ALSO BE INSTALLED BETWEEN NEW AND EXISTING CONCRETE SLABS.
- EXPANSION JOINT SHALL BE 3/8" ASPHALT IMPREGNATED CELLULAR FIBER AND 1/2" DIMENSION EQUAL TO THE FULL SLAB DEPTH.

SCALE: NONE
TOWN OF GLASTONBURY
 DEPARTMENT OF PHYSICAL SERVICES
 ENGINEERING DIVISION
CONCRETE SIDEWALKS
 PLATE NO. 6

NOTES:

- ALL BITUMINOUS CURBING IS TO BE SET ON THE BRICK COURSE.
- ROADWAY SHALL BE SWEPT CLEAN AND PROPERLY TACK COATED PRIOR TO BITUMINOUS CURB INSTALLATION.

SCALE: NONE
TOWN OF GLASTONBURY
 DEPARTMENT OF PHYSICAL SERVICES
 ENGINEERING DIVISION
TYPICAL CURBING DETAILS
 PLATE NO. 5

NOTES:

- PIPE INLET SHALL HAVE 6" DIAMETER KNOCKOUTS.
- REINFORCING STEEL DEFORMED BARS CONFORM TO LATEST ASTM SPECIFICATION A615.
- CONCRETE COMPRESSIVE STRENGTH - 4,000 PSI AT 28 DAYS.
- METHOD OF MANUFACTURE: WET CAST.
- SECTION IS MONOLITHIC. GALLEY SHALL BE DESIGNED FOR HS-20 LOADING W/16" OF SOIL COVER.

SCALE: 1"=5'
TOWN OF GLASTONBURY
 DEPARTMENT OF PHYSICAL SERVICES
 ENGINEERING DIVISION
STORM WATER INFILTRATION SYSTEM LAYOUT PLAN
 PLATE NO. 1

NOTES:

- ALL MANHOLE FRAMES AND COVERS TO BE SET FLUSH WITH BINDER COURSE. A MANHOLE RISER RING SHALL BE USED TO BRING MANHOLE COVER TO FINISHED GRADE PRIOR TO THE COMPLETION OF THE FINAL SURFACE COURSE.
- TOP STEP TO BE 4" BELOW FRAME, 12" O.C. BELOW TOP STEP.
- MANHOLE TO BE SET ON A BASE OF 3/4" CRUSHED STONE AS SHOWN.

SCALE: NONE
TOWN OF GLASTONBURY
 DEPARTMENT OF PHYSICAL SERVICES
 ENGINEERING DIVISION
MANHOLE VERTICAL SECTION B-B
 PLATE NO. 31

NOTES:

- PRECAST TOP (TYPE 'C-L')
- TYPICAL CB CONSTRUCTED WITH WEIR OPENINGS
- WEIR ELEV.
- 4" UNDER-DRAIN ELEV.
- 12" OUTLET ELEV.
- 2" SUMP MIN.
- SET ON A 6" THICK BASE OF 3/4" CRUSHED STONE.

SCALE: NONE
TOWN OF GLASTONBURY
 DEPARTMENT OF PHYSICAL SERVICES
 ENGINEERING DIVISION
OUTLET STRUCTURE No. 1 & No. 2 DETAIL
 N.T.S.

NOTES:

- PIPE INLET SHALL HAVE 6" DIAMETER KNOCKOUTS.
- REINFORCING STEEL DEFORMED BARS CONFORM TO LATEST ASTM SPECIFICATION A615.
- CONCRETE COMPRESSIVE STRENGTH - 4,000 PSI AT 28 DAYS.
- METHOD OF MANUFACTURE: WET CAST.
- SECTION IS MONOLITHIC. GALLEY SHALL BE DESIGNED FOR HS-20 LOADING W/16" OF SOIL COVER.

SCALE: NONE
TOWN OF GLASTONBURY
 DEPARTMENT OF PHYSICAL SERVICES
 ENGINEERING DIVISION
STORM WATER INFILTRATION SYSTEM TYPICAL DETAIL
 N.T.S.

NOTES:

- PERFORATED PIPE SHALL BE 24" HOPE PERFORATED PIPE (LEVEL).
- PIPE SHALL BE SET ON A 6" THICK BASE OF 3/4" CRUSHED STONE.
- PIPE SHALL BE SET ON A 6" THICK BASE OF 3/4" CRUSHED STONE.

SCALE: NONE
TOWN OF GLASTONBURY
 DEPARTMENT OF PHYSICAL SERVICES
 ENGINEERING DIVISION
SECTION VIEW PERFORATED PIPE INFILTRATION SYSTEM DETAIL
 (BETWEEN SED. STRUCT. C-CB 5 AND C-CB 6)
 N.T.S.

THIS MAP PRODUCED BY ORIGINAL INK DRAWING ON POLY FILM OR LINEN TOWN OF GLASTONBURY 2155 MAIN STREET GLASTONBURY, CT 06033

SCALE: NONE
TOWN OF GLASTONBURY
 DEPARTMENT OF PHYSICAL SERVICES
 ENGINEERING DIVISION
PRECAST CONCRETE MANHOLE (STORM & SANITARY)
 PLATE NO. 31

Town of Glastonbury Reserved Land Zone
PROJECT/APPLICANT ZONE
 2155 & 2143 Main Street **Town Hall & Academy Building**
PROJECT ADDRESS
 Section 12
SPECIAL PERMIT SECTION TPZ CHAIRPERSON

January 17, 2017
 DATE SPECIAL PERMIT APP'D **DIRECTOR OF COMMUNITY DEVELOPMENT**

FILE NO.

FOR INFORMATION ONLY

DRAWING ISSUE STATUS

| NO. | DESCRIPTION | DATE |
|-----|----------------------------|------------|
| 3. | ISSUED FOR LANDSCAPING BID | 5/5/2017 |
| 2. | CONDITIONS OF APPROVAL | 3/28/2017 |
| 1. | ISSUED FOR PERMITTING | 12/16/2016 |

SCALE: AS SHOWN **DATE:** 11/23/2016
DRAWN BY: C.F.S. **CHECKED BY:** S.M.B. **APPROVED BY:** D.A.P.
ST. FILE:

DO NOT SCALE THIS DRAWING. USE THE DIMENSIONS GIVEN. IF THERE ARE ANY DISCREPANCIES OR QUESTIONS, CONTACT THE TOWN OF GLASTONBURY, ENGINEERING OFFICE.

TYPICAL DETAILS
TOWN HALL / ACADEMY COMPLEX
DRIVE & PARKING RECONFIGURATION
 LOCATED AT
 2155 / 2143 MAIN STREET
GLASTONBURY, CONNECTICUT

SHEET NO. 8
 OF 12

ALL UTILITY INFORMATION AND DATA SHOWN OR INDICATED IN THE CONTRACT DOCUMENTS ARE COMPILED FROM MAPS AND DATA FURNISHED BY OTHERS. ANY SUCH INFORMATION SHOULD NOT BE CONSTRUED AS ACCURATE OR COMPLETE AND THE CONTRACTOR SHALL VERIFY ALL LOCATIONS PRIOR TO CONSTRUCTION.

MANUAL REVISIONS TO THIS DOCUMENT ARE PROHIBITED.
 ALL REVISIONS MUST BE PERFORMED ON CADD FILE.
 H:\DWG\Streets\Main ST\PW-0908 ACADEMY SCHOOL SITE IMPROVEMENTS\TownHall-Academy-Filing-2017.dwg

PW-0908

TOWN OF GLASTONBURY
 DEPARTMENT OF PHYSICAL SERVICES
 ENGINEERING DIVISION

TOWN OF GLASTONBURY
 DEPARTMENT OF PHYSICAL SERVICES
 ENGINEERING DIVISION










TOWN OF GLASTONBURY
 DEPARTMENT OF PHYSICAL SERVICES
 ENGINEERING DIVISION

TOWN OF GLASTONBURY
 DEPARTMENT OF PHYSICAL SERVICES
 ENGINEERING DIVISION

TOWN OF GLASTONBURY
 DEPARTMENT OF PHYSICAL SERVICES
 ENGINEERING DIVISION

TOWN OF GLASTONBURY
 DEPARTMENT OF PHYSICAL SERVICES
 ENGINEERING DIVISION

FILE: H:\DWG\Streets\Main St\PW-0908 ACADEMY SCHOOL SITE IMPROVEMENTS\TownHall-Academy-Filing-2017.dwg USER: Charles Stashly/pt DATE: 11/23/2017

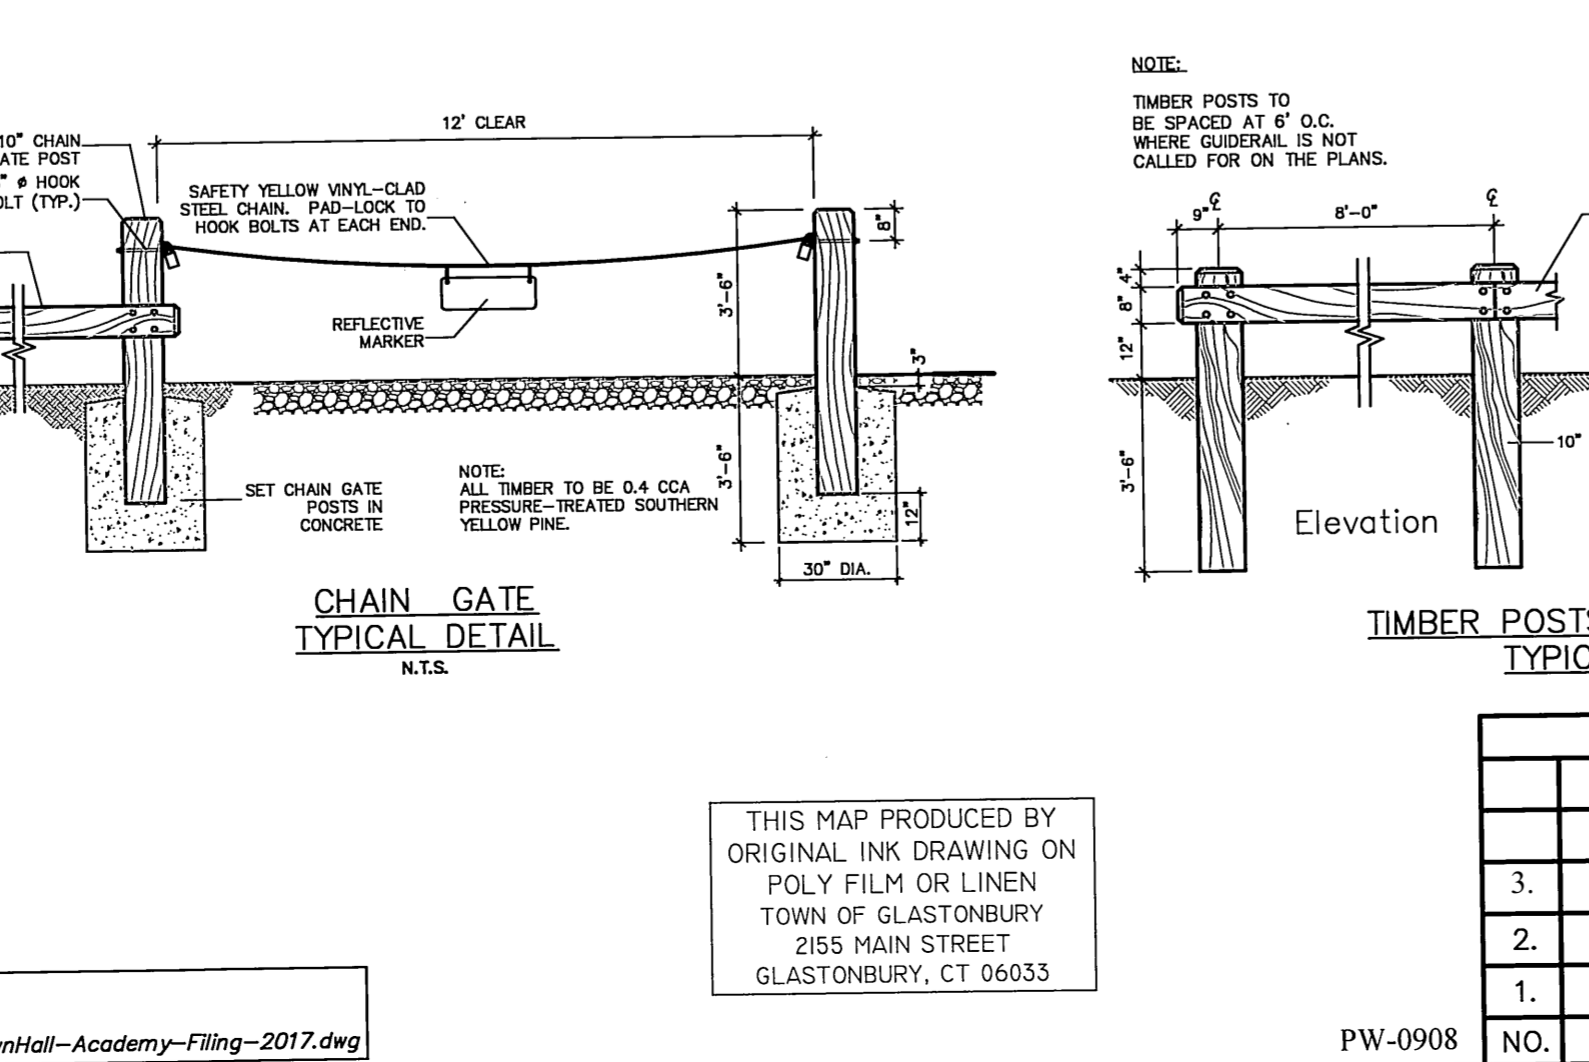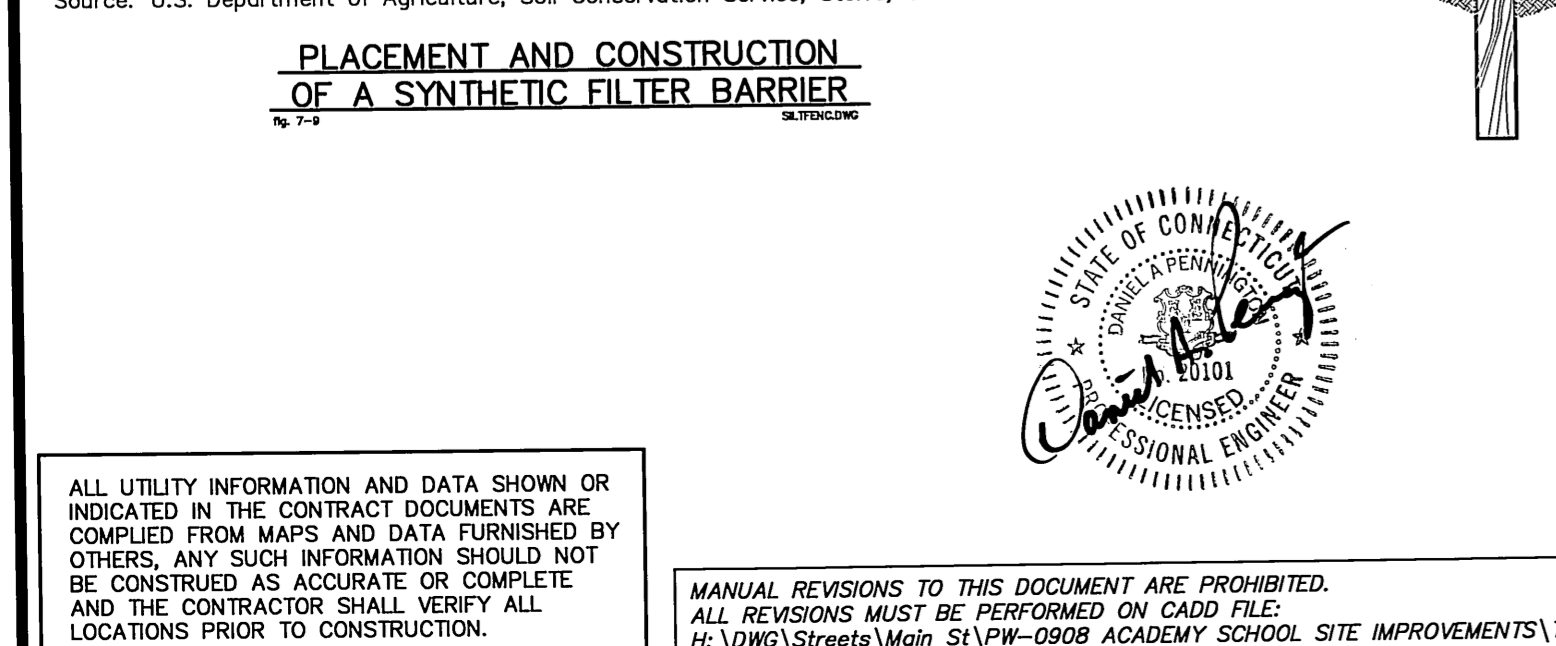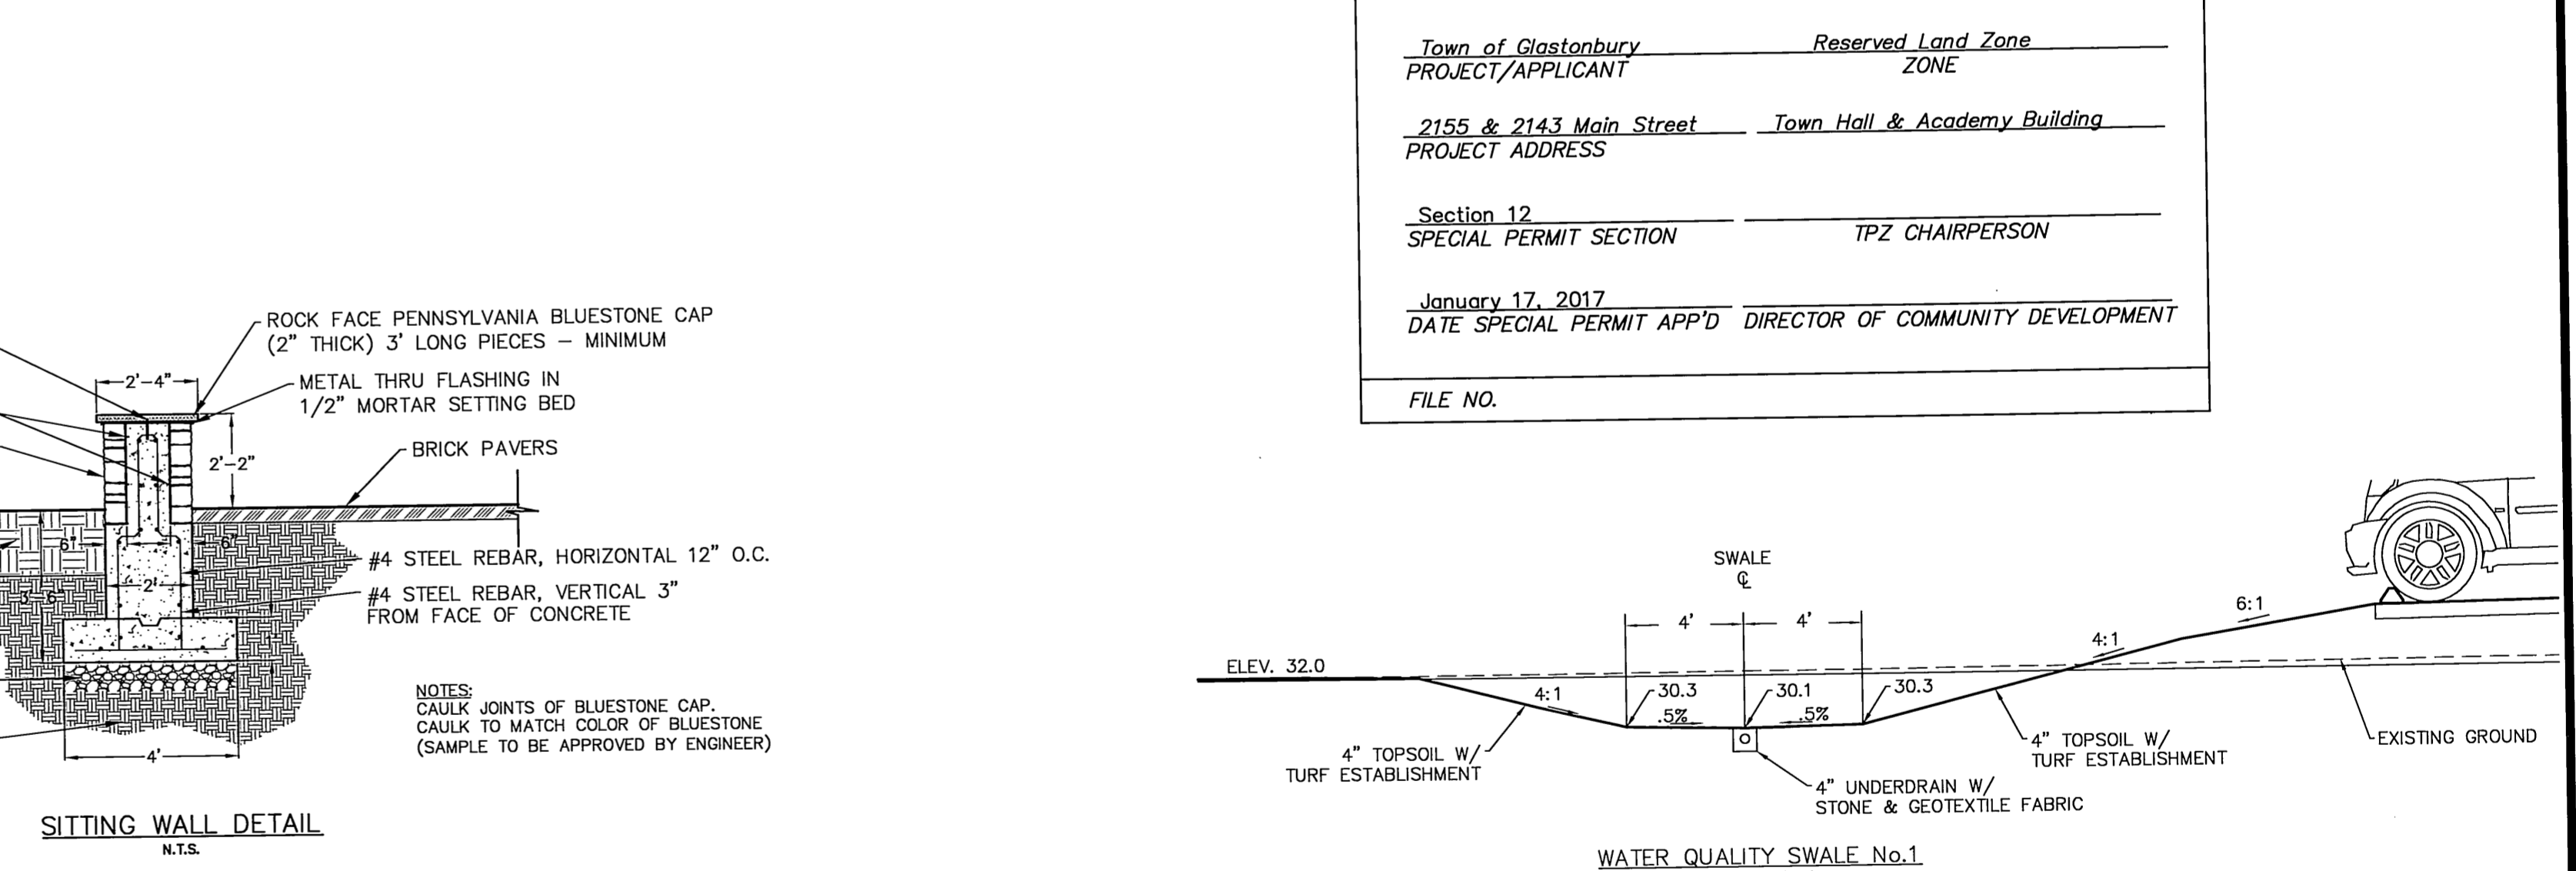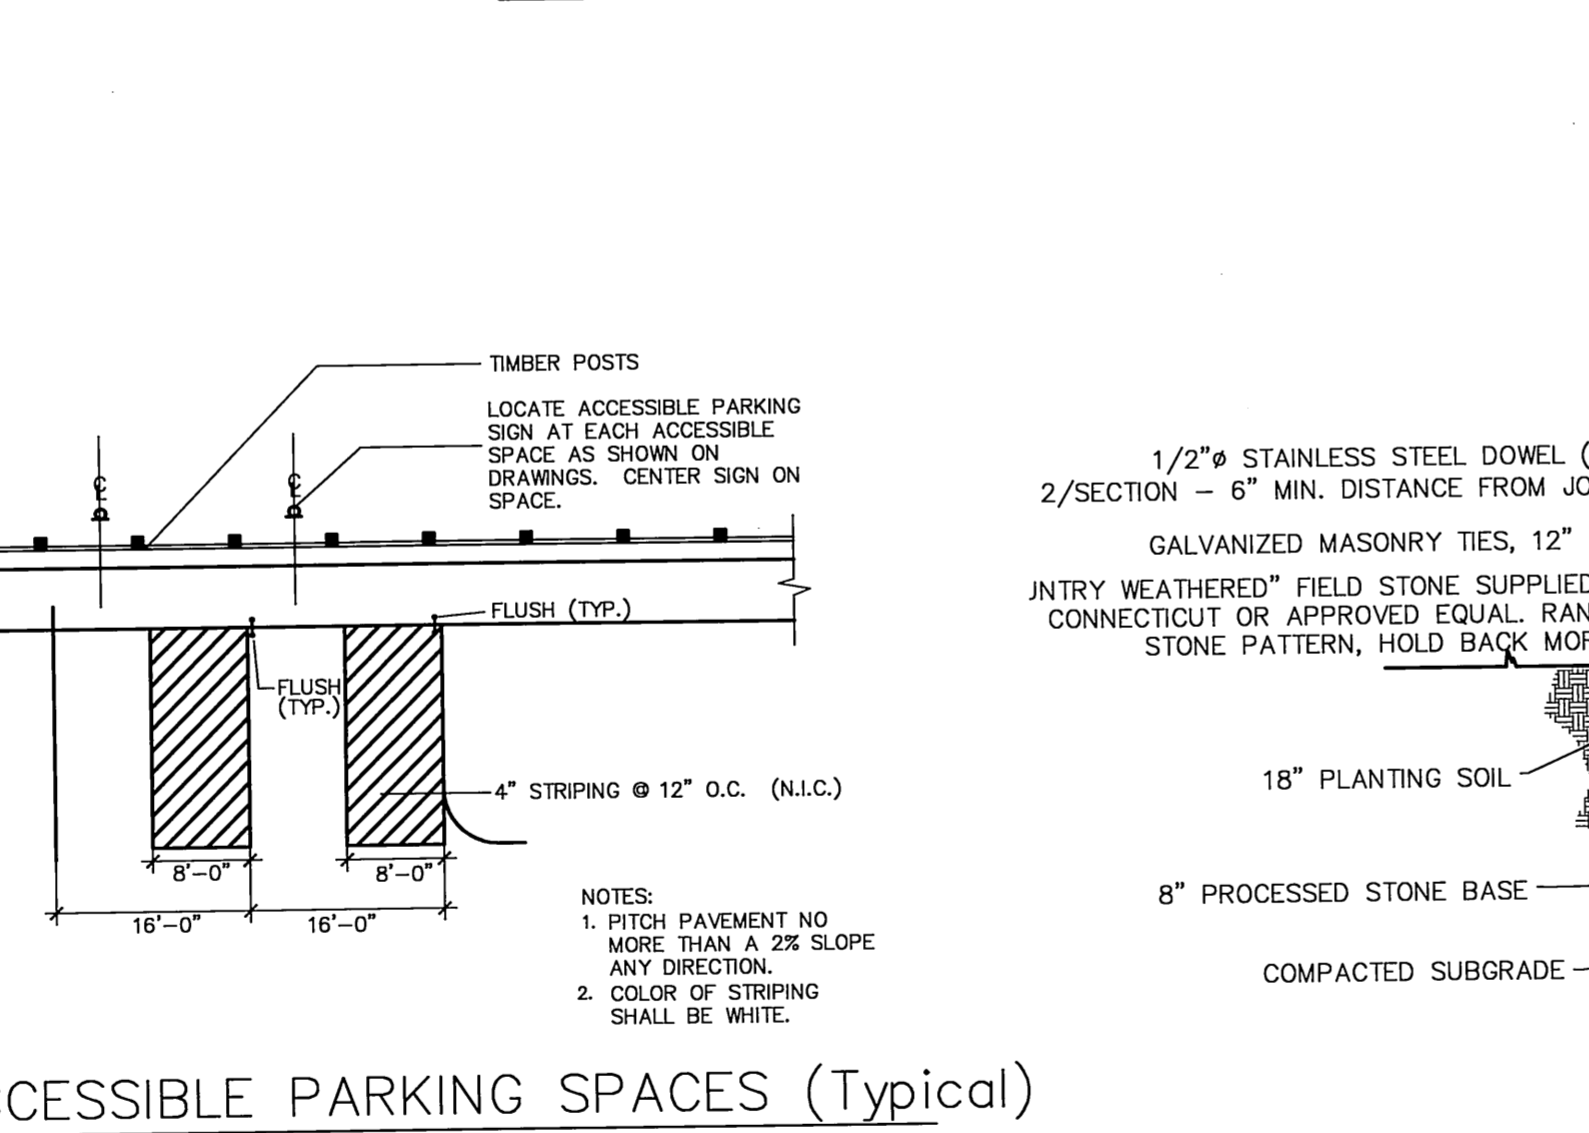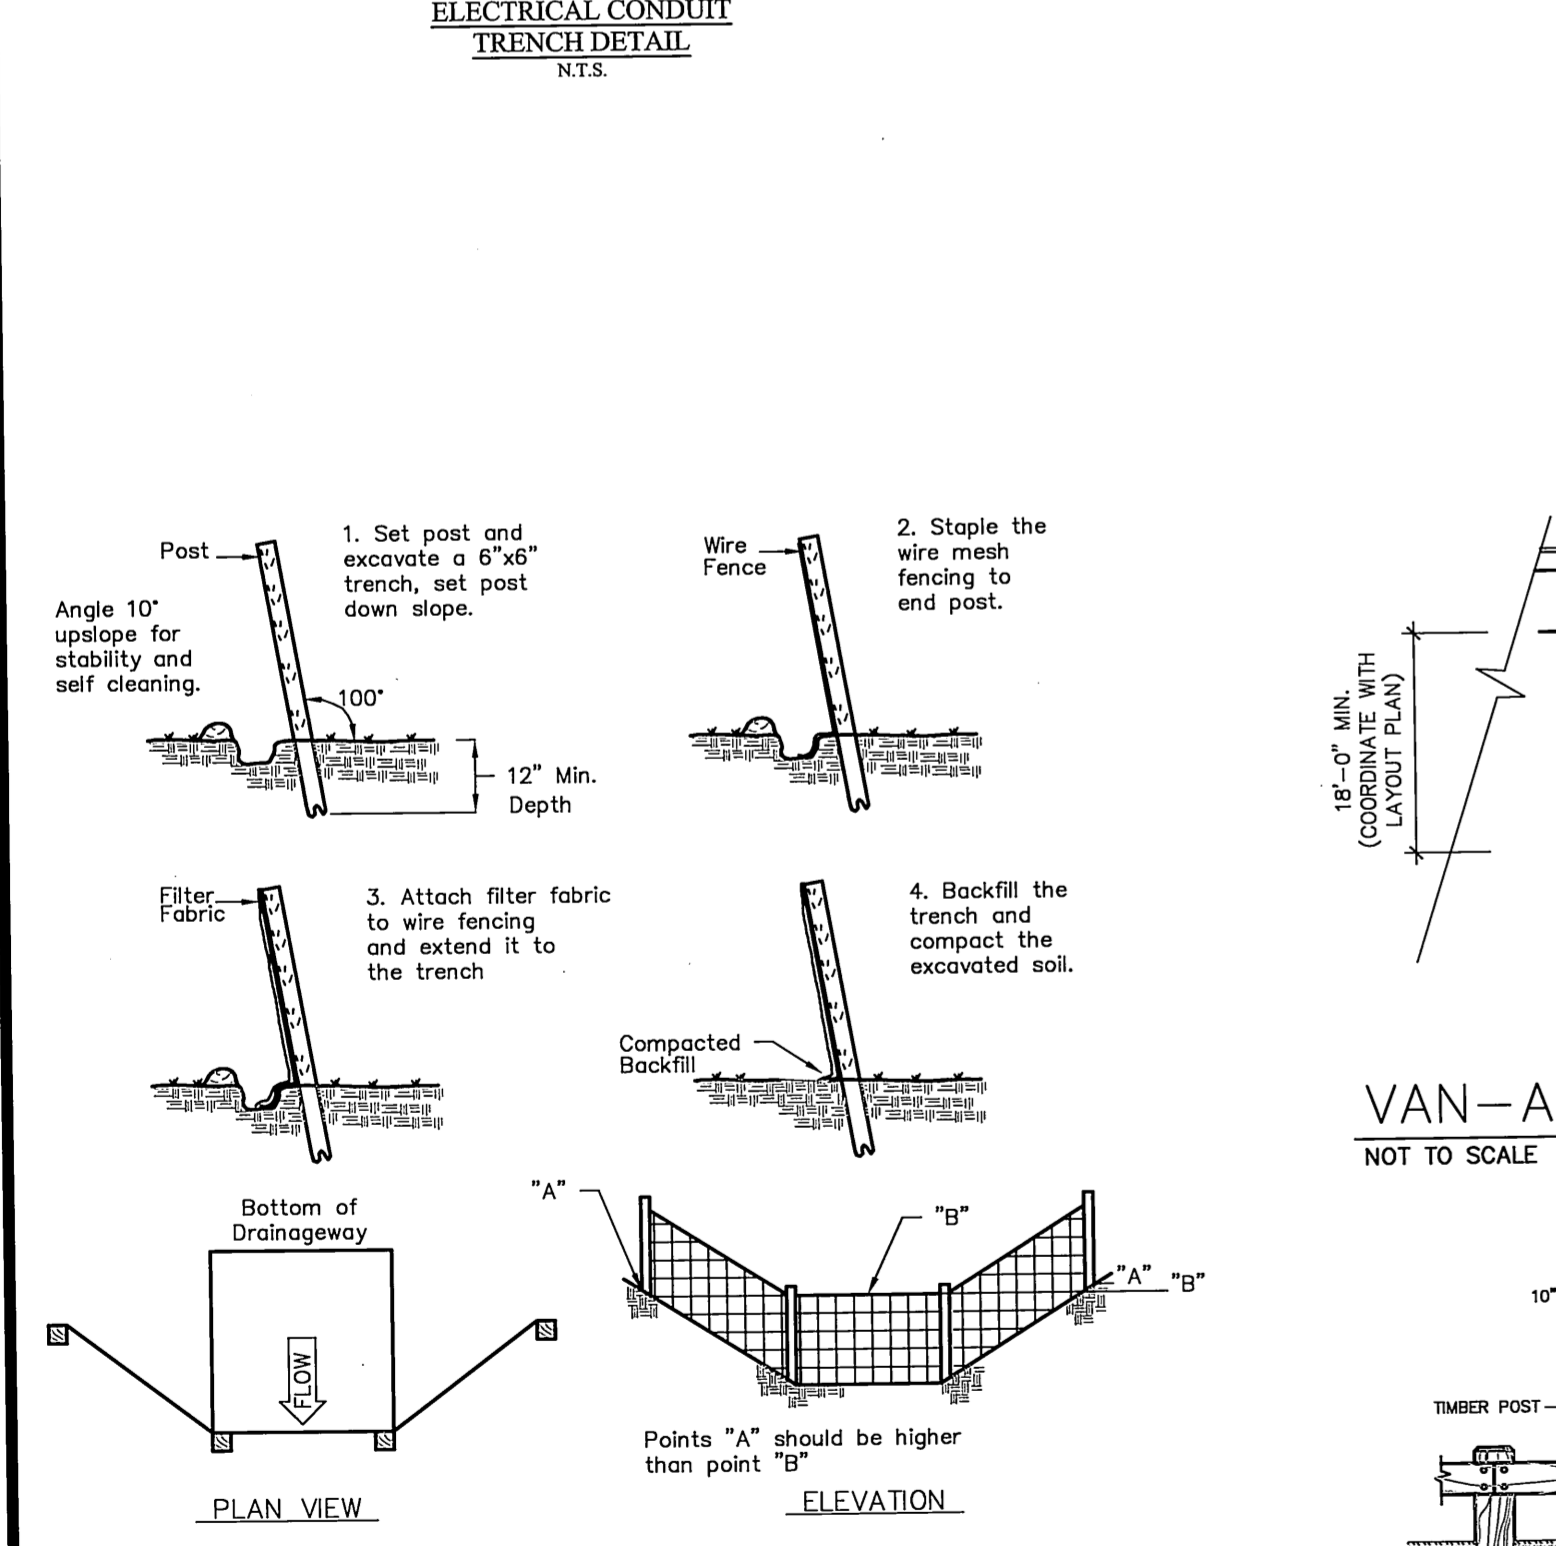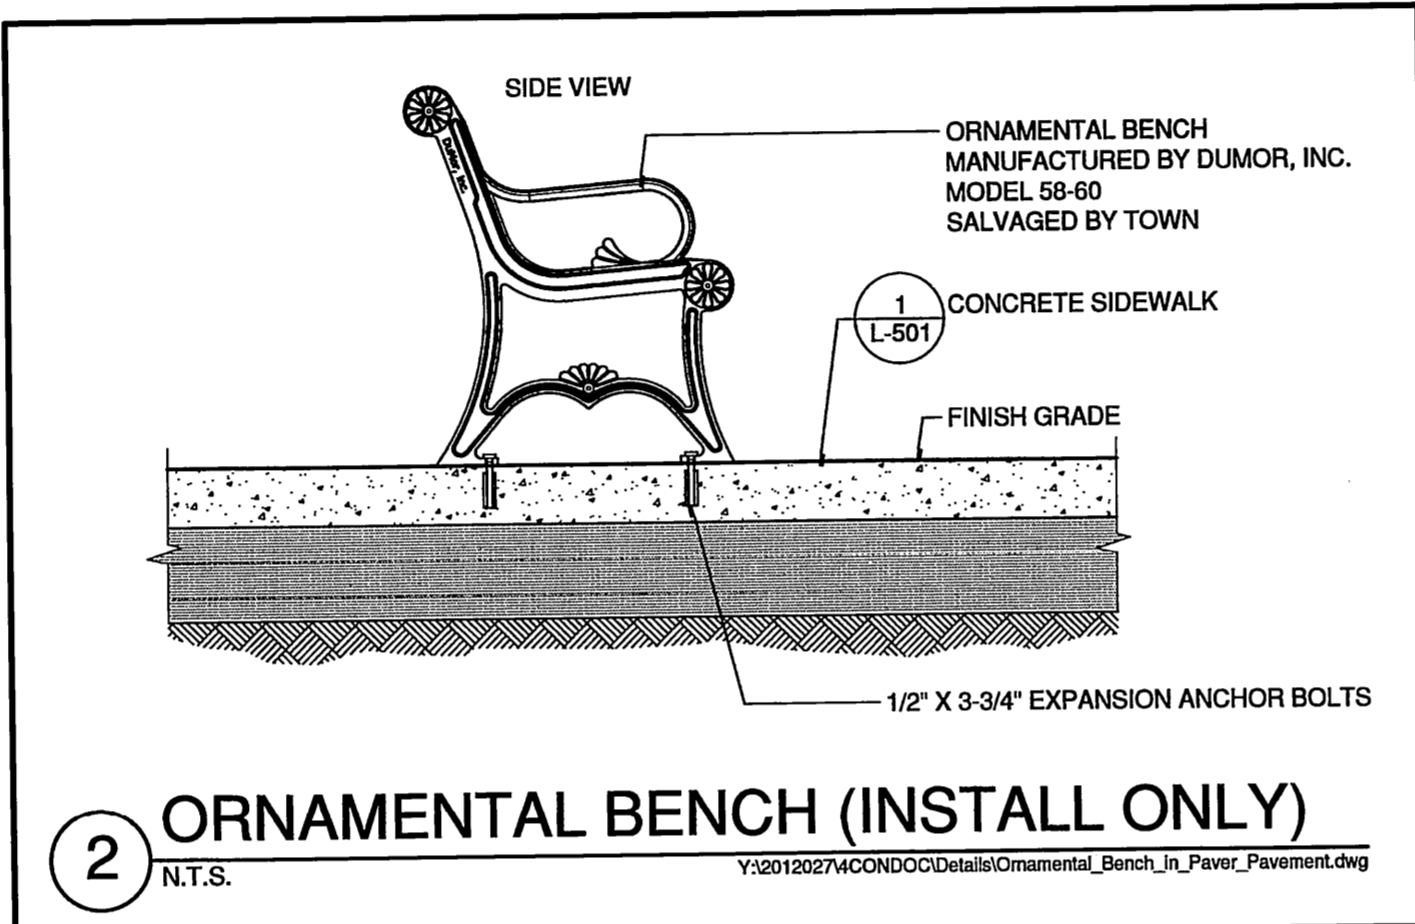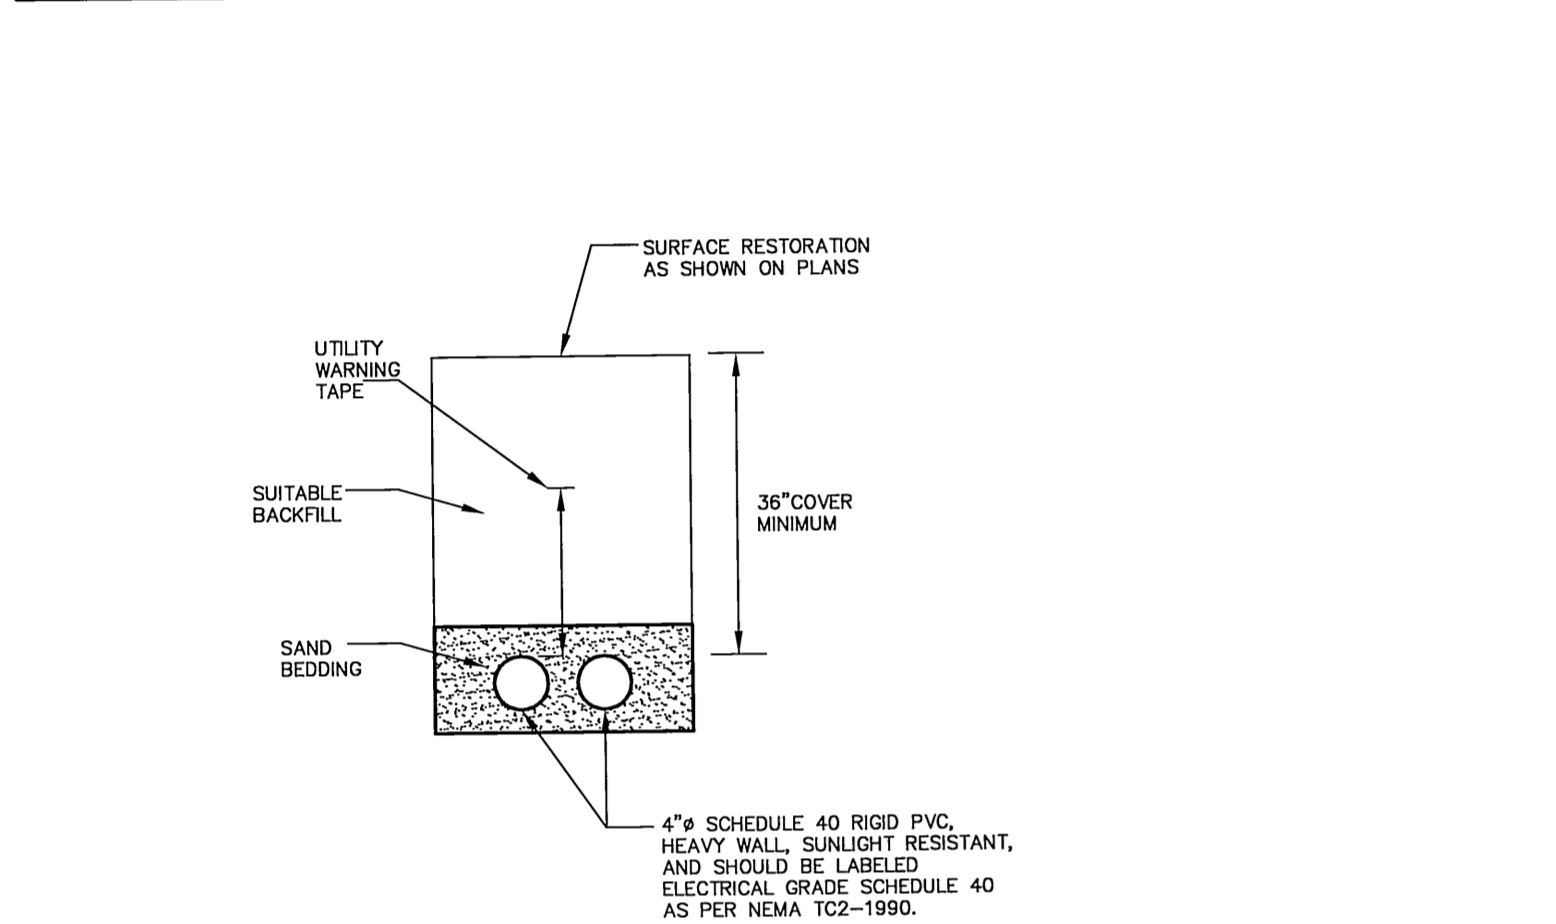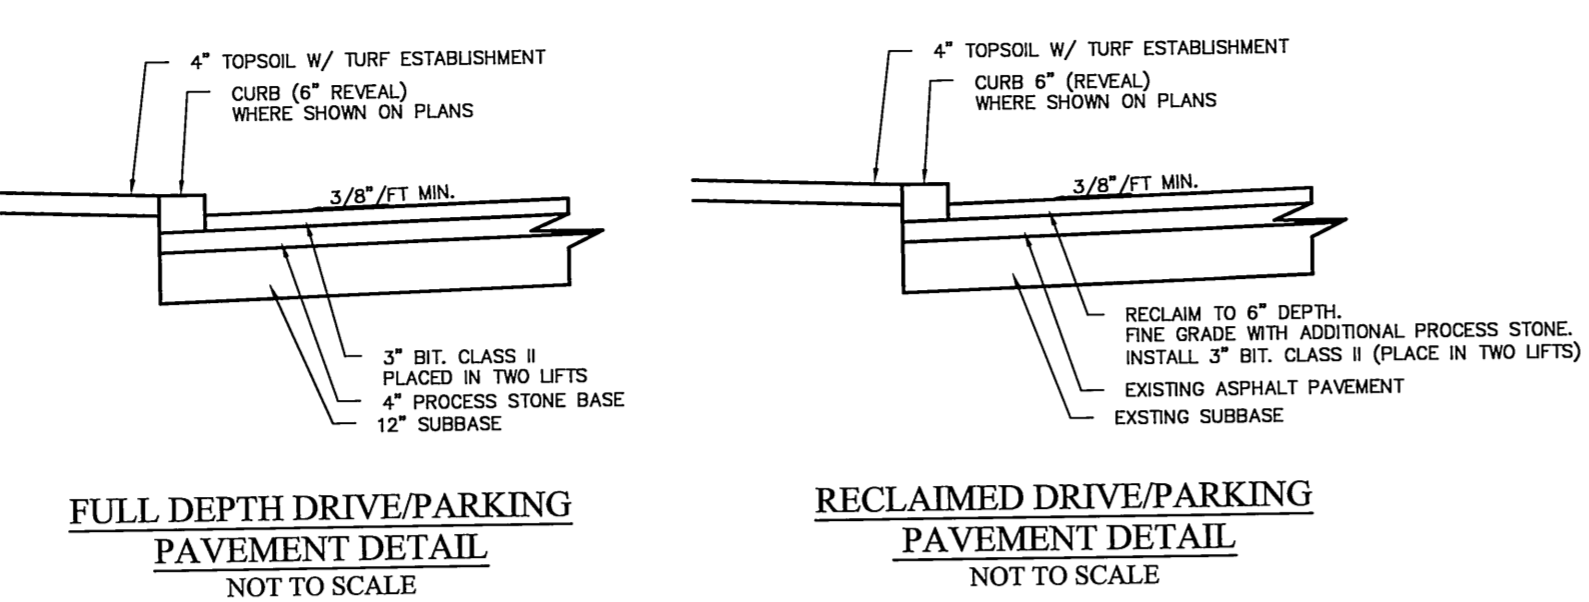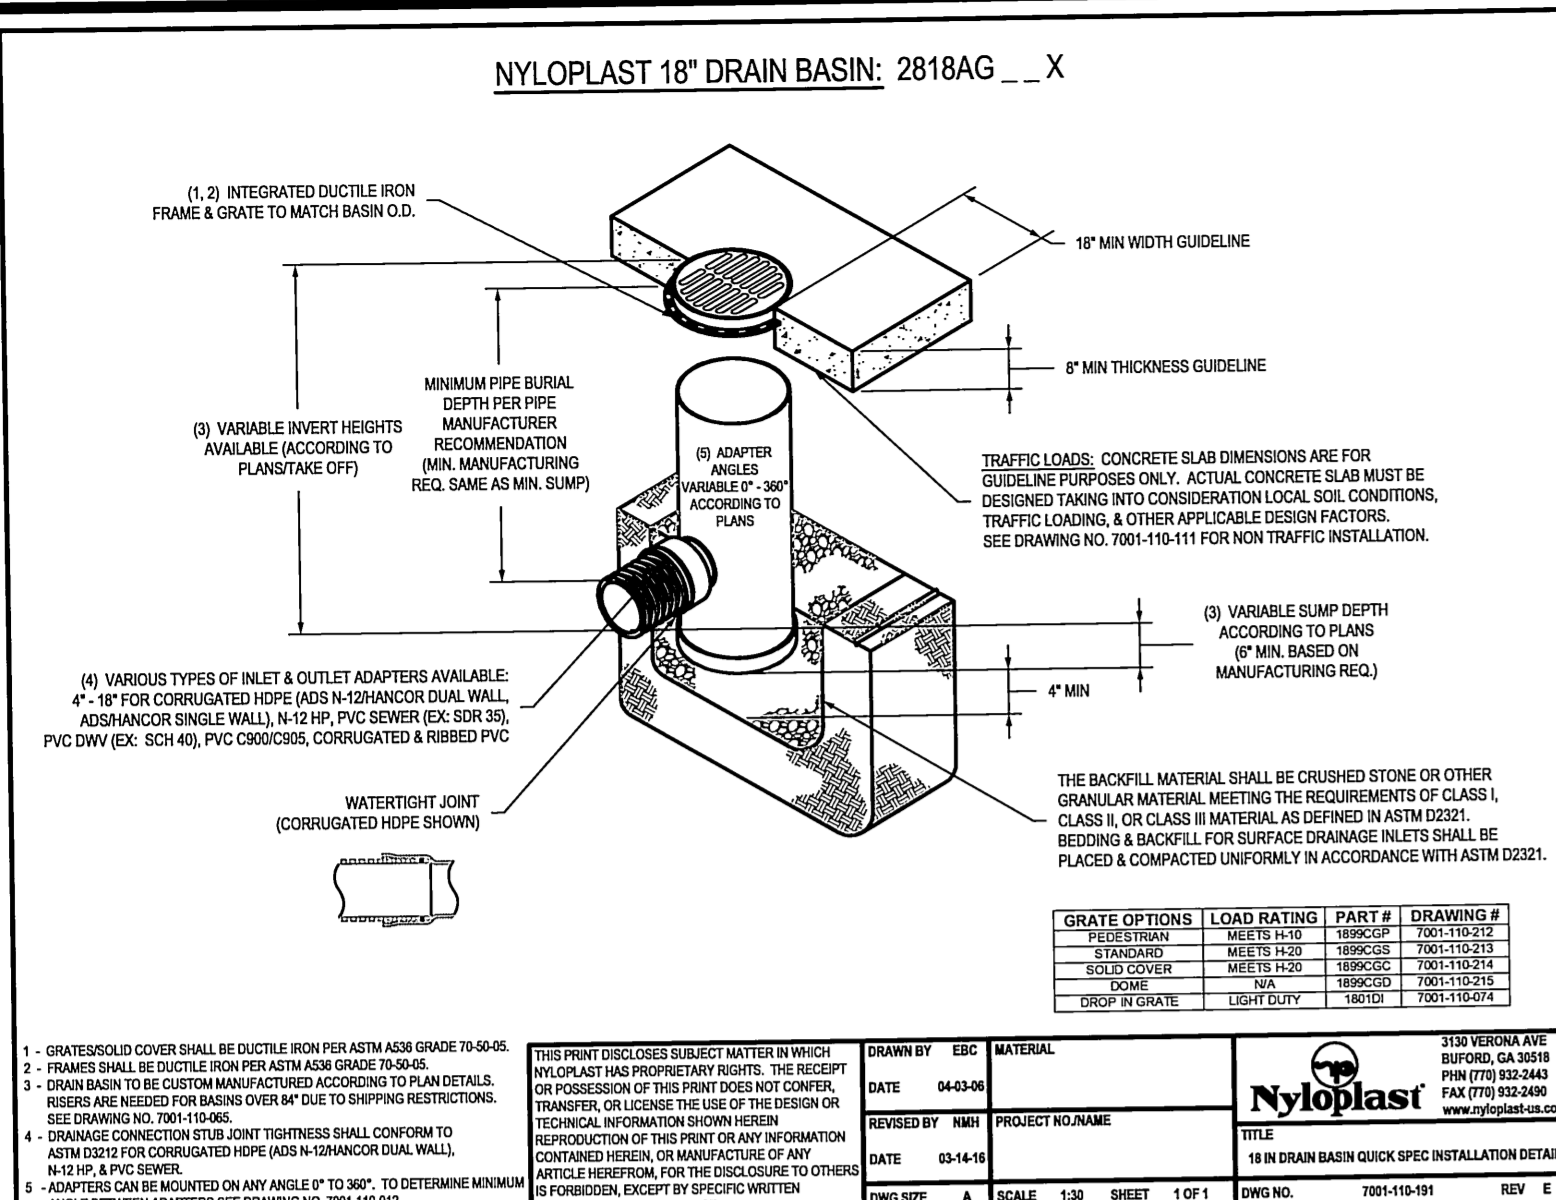

Town of Glastonbury Reserved Land Zone
 PROJECT/APPLICANT ZONE

2155 & 2143 Main Street Town Hall & Academy Building
 PROJECT ADDRESS

Section 12
 SPECIAL PERMIT SECTION TPZ CHAIRPERSON

January 17, 2017
 DATE SPECIAL PERMIT APP'D DIRECTOR OF COMMUNITY DEVELOPMENT

FILE NO.

FOR INFORMATION ONLY

| DRAWING ISSUE STATUS | | |
|----------------------|----------------------------|------------|
| NO. | DESCRIPTION | DATE |
| 3. | ISSUED FOR LANDSCAPING BID | 5/5/2017 |
| 2. | CONDITIONS OF APPROVAL | 3/28/2017 |
| 1. | ISSUED FOR PERMITTING | 12/16/2016 |
| NO. | DESCRIPTION | DATE |

SCALE: AS SHOWN DATE: 11/23/2016
 DRAWN BY: C.F.S.
 CHECKED BY: S.M.B.
 APPROVED BY: D.A.P.

GRID NORTH


TYPICAL DETAILS
 TOWN HALL / ACADEMY COMPLEX
 DRIVE & PARKING RECONFIGURATION
 LOCATED AT
 2155 / 2143 MAIN STREET
 GLASTONBURY, CONNECTICUT

SHEET NO.
9
 OF 12


ALL UTILITY INFORMATION AND DATA SHOWN OR INDICATED IN THE CONTRACT DOCUMENTS ARE COMPILED FROM MAPS AND DATA FURNISHED BY OTHERS. ANY SUCH INFORMATION SHOULD NOT BE CONSIDERED AS ACCURATE OR COMPLETE AND THE CONTRACTOR SHALL VERIFY ALL LOCATIONS PRIOR TO CONSTRUCTION.

MANUAL REVISIONS TO THIS DOCUMENT ARE PROHIBITED. ALL REVISIONS MUST BE PERFORMED ON CADD FILE:
 H:\DWG\Streets\Main St\PW-0908 ACADEMY SCHOOL SITE IMPROVEMENTS\TownHall-Academy-Filing-2017.dwg

THIS MAP PRODUCED BY ORIGINAL INK DRAWING ON POLY FILM OR LINEN
 TOWN OF GLASTONBURY
 2155 MAIN STREET
 GLASTONBURY, CT 06033

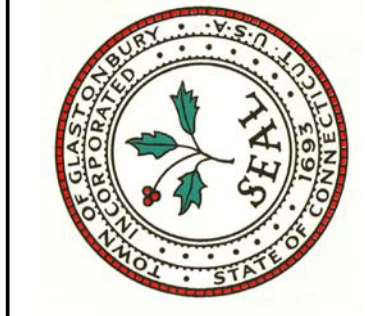

PROPOSED SITE DEVELOPMENT FOR THE:
GLASTONBURY TOWN HALL
GLASTONBURY, CONNECTICUT

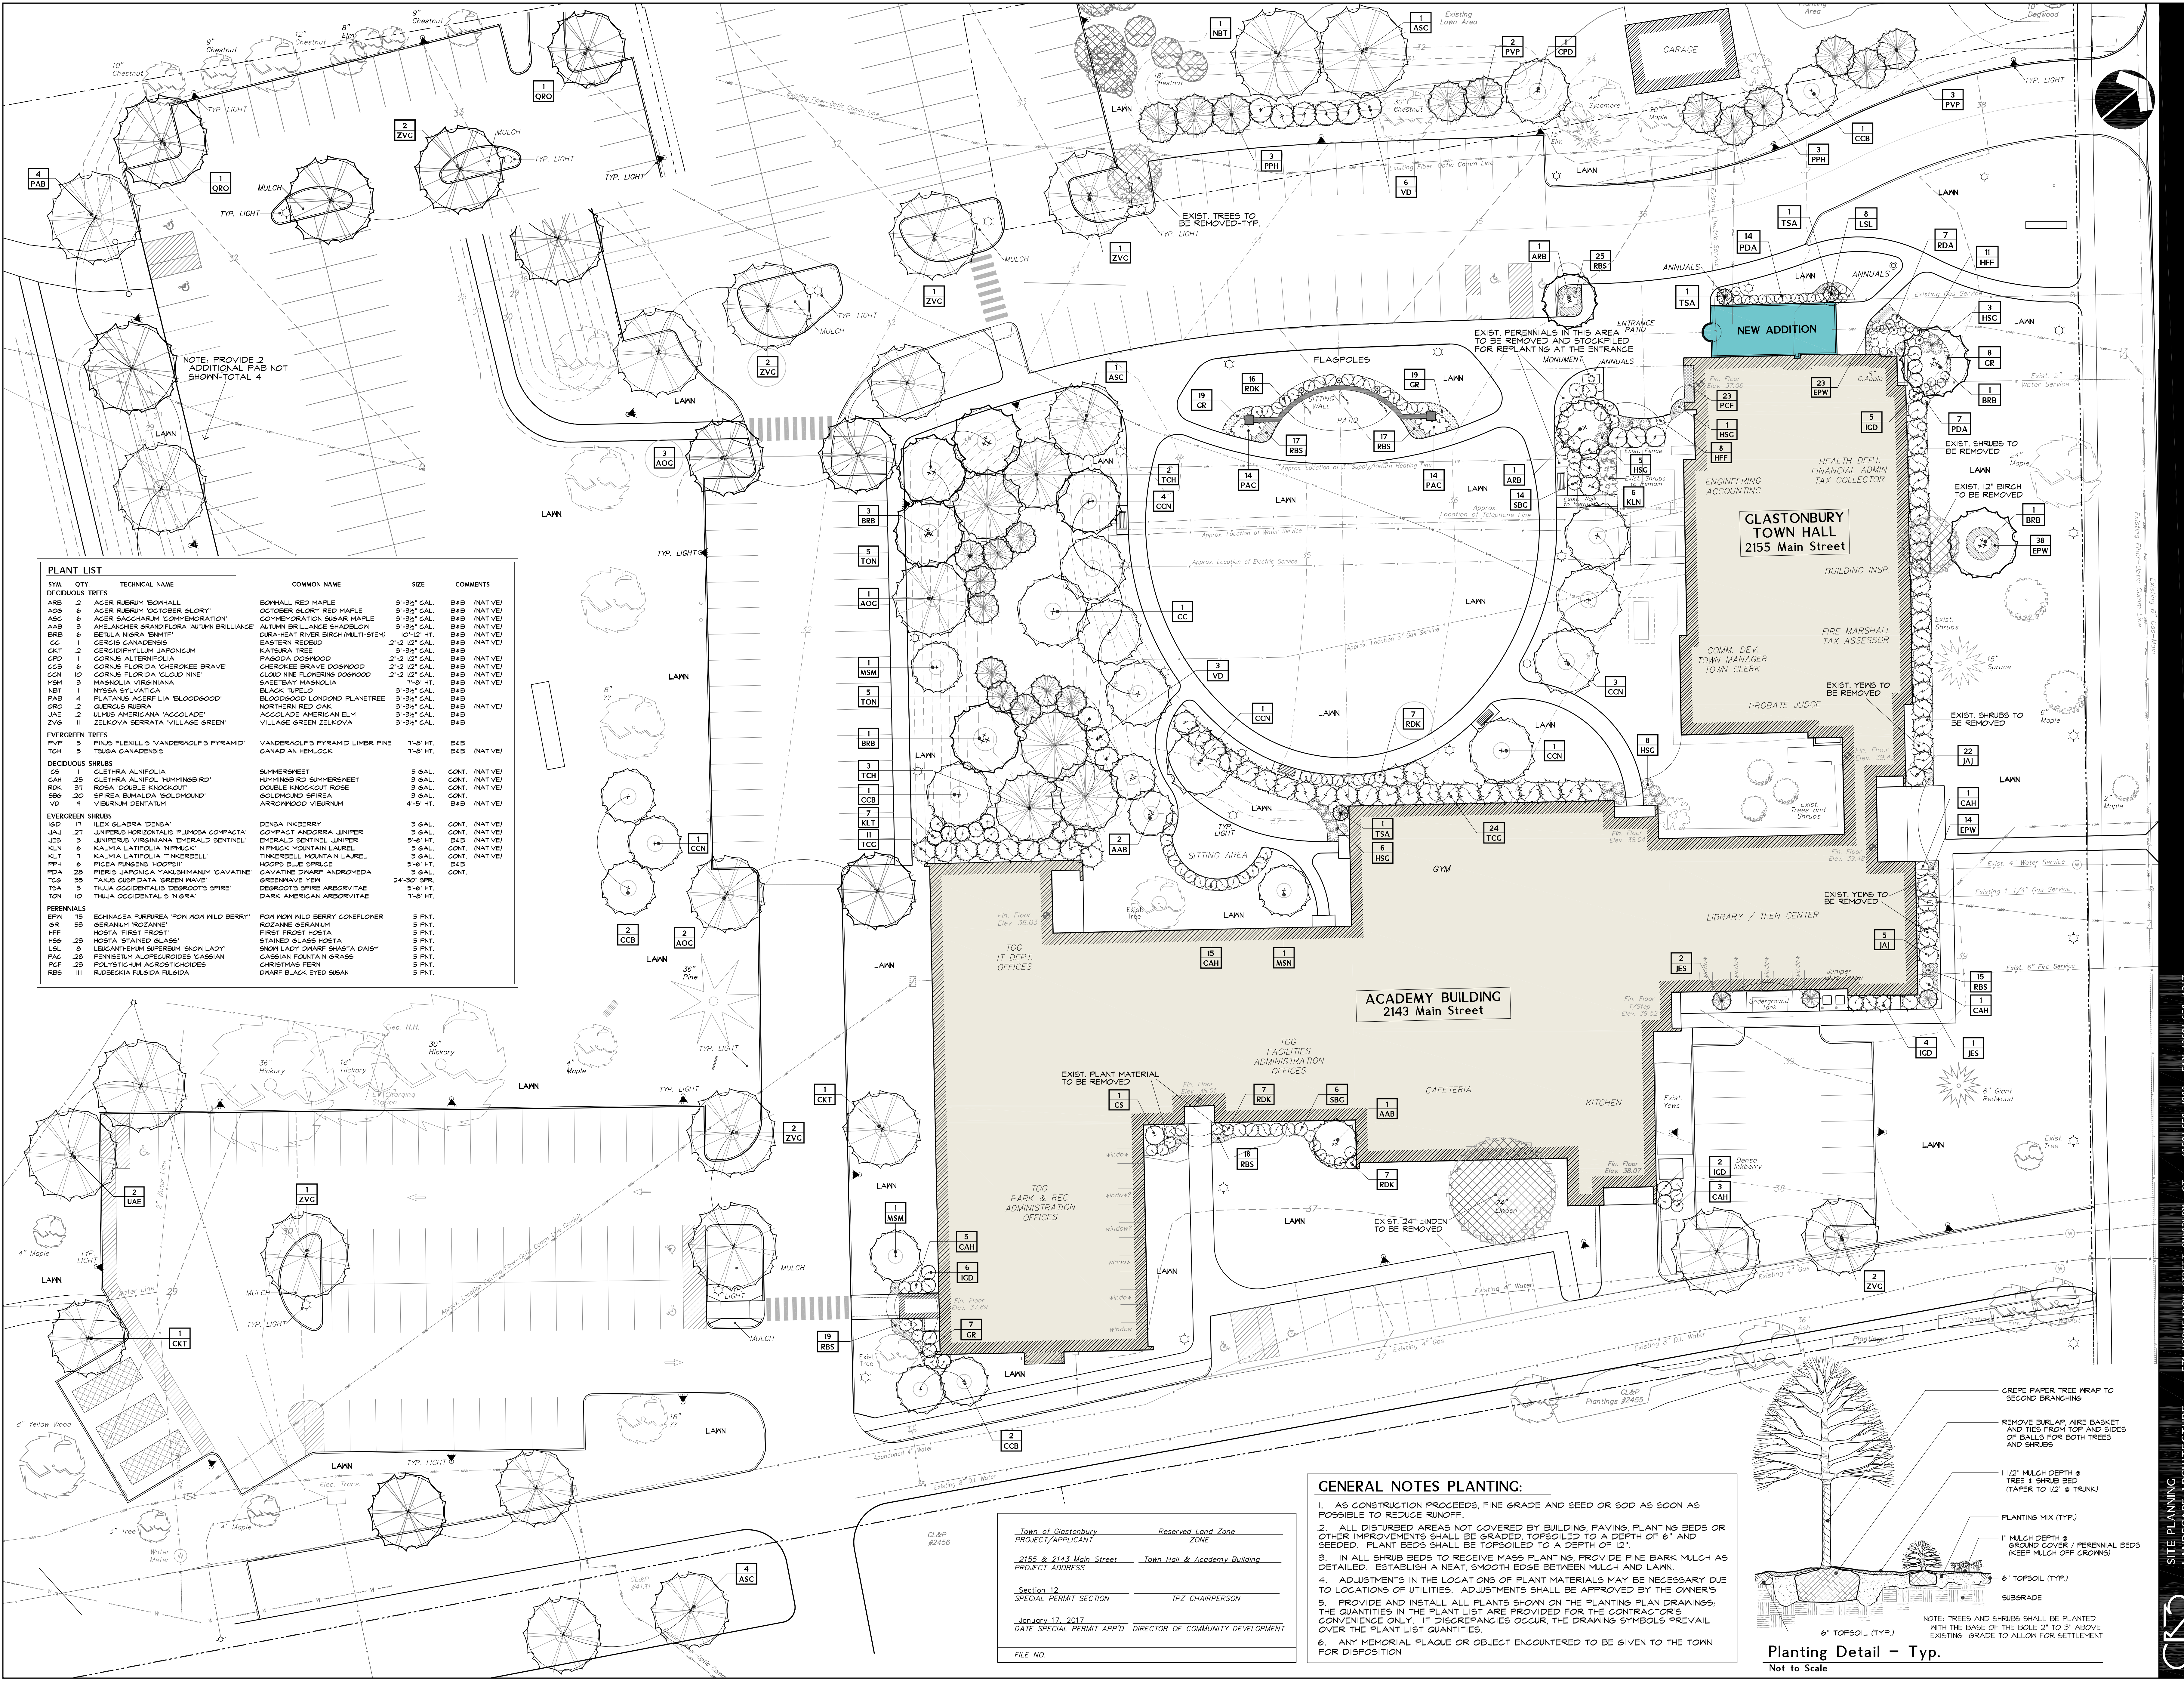


PLANT LIST


| SYM. | QTY. | TECHNICAL NAME | COMMON NAME | SIZE | COMMENTS |
|-------------------------|------|---|-------------------------------------|----------------|----------------|
| DECIDUOUS TREES | | | | | |
| ARB | 2 | ACER RUBRUM 'BOHALL' | BOHALL RED MAPLE | 3'-3 1/2' CAL. | B4B (NATIVE) |
| AOC | 6 | ACER RUBRUM 'OCTOBER GLORY' | OCTOBER GLORY RED MAPLE | 3'-3 1/2' CAL. | B4B (NATIVE) |
| ASC | 6 | ACER SACCHARINUM 'COMMEMORATION' | COMMEMORATION SUGAR MAPLE | 3'-3 1/2' CAL. | B4B (NATIVE) |
| AAS | 3 | AMELANCHIER GRANDIFLORA 'AUTUMN BRILLIANCE' | AUTUMN BRILLIANCE SHADBLOW | 3'-3 1/2' CAL. | B4B (NATIVE) |
| BRB | 6 | BETULA NIGRA 'BRNHT' | DURAH-HEAT RIVER BIRCH (MULTI-STEM) | 10'-12' HT. | B4B (NATIVE) |
| CC | 1 | CERCIS CANADENSIS | EASTERN REDBUD | 2'-2 1/2' CAL. | B4B (NATIVE) |
| CKT | 2 | CERCIDIPHYLLUM JAPONICUM | KATSURA TREE | 3'-3 1/2' CAL. | B4B |
| CPD | 6 | CORNUS ALTERNIFOLIA | PANOGDA DOGWOOD | 2'-2 1/2' CAL. | B4B (NATIVE) |
| CCB | 6 | CORNUS FLORIDA 'CHEROKEE BRAVE' | CHEROKEE BRAVE DOGWOOD | 2'-2 1/2' CAL. | B4B (NATIVE) |
| CGN | 10 | CORNUS FLORIDA 'CLOUD NINE' | CLOUD NINE FLOWERING DOGWOOD | 2'-2 1/2' CAL. | B4B (NATIVE) |
| MSM | 3 | MAGNOLIA VIRGINIANA | SWEETBAY MAGNOLIA | 7'-9' HT. | B4B |
| NSB | 1 | NYSSA SYLVATICA | BLACK TUPelo | 3'-3 1/2' CAL. | B4B |
| PAB | 4 | PLATANUS AGERIFOLIA 'BLOODGOOD' | BLOODGOOD LONDON PLANETREE | 3'-3 1/2' CAL. | B4B |
| ORQ | 2 | QUERCUS RUBRA | NORTHERN RED OAK | 3'-3 1/2' CAL. | B4B (NATIVE) |
| UAE | 2 | ULMUS AMERICANA 'AGCOLADE' | AGCOLADE AMERICAN ELM | 3'-3 1/2' CAL. | B4B |
| ZVG | 11 | ZELKOVA SERRATA 'VILLAGE GREEN' | VILLAGE GREEN ZELKOVA | 3'-3 1/2' CAL. | B4B |
| EVERGREEN TREES | | | | | |
| PVP | 5 | PINUS FLEXILIS 'VANDERVOELT'S PYRAMID' | VANDERVOELT'S PYRAMID LIMB PINE | 7'-8' HT. | B4B |
| TCH | 5 | TSUSA CANADENSIS | CANADIAN HEMLOCK | 7'-8' HT. | B4B (NATIVE) |
| DECIDUOUS SHRUBS | | | | | |
| CAH | 25 | CLETHRA ALNIFOLIA | SUMMERSWEET | 5 GAL. | CONT. (NATIVE) |
| RDK | 31 | ROSA 'DOUBLE ENOCHLOUT' | DOUBLE ENOCHLOUT ROSE | 3 GAL. | CONT. (NATIVE) |
| SBO | 20 | SPIREA BUMALDA 'GOLDMOUND' | GOLDMOUND SPIREA | 3 GAL. | CONT. (NATIVE) |
| VD | 4 | VIBURNUM DENTATUM | ARROWWOOD VIBURNUM | 4'-5' HT. | B4B (NATIVE) |
| EVERGREEN SHRUBS | | | | | |
| ISD | 17 | ILEX GLABRA 'DENSE' | DENSE INKBERRY | 3 GAL. | CONT. (NATIVE) |
| JAJ | 21 | JUNIPERUS HORIZONTALIS 'FLUMOSA COMPACTA' | COMPACT ANDORRA JUNIPER | 3 GAL. | CONT. (NATIVE) |
| JES | 3 | JUNIPERUS VIRGINIANA 'EMERALD SENTINEL' | EMERALD SENTINEL JUNIPER | 5'-6' HT. | B4B (NATIVE) |
| KLN | 6 | KALMIA LATIFOLIA 'NIPMUCK' | NIPMUCK MOUNTAIN LAUREL | 5 GAL. | CONT. (NATIVE) |
| KLT | 7 | KALMIA LATIFOLIA 'TINKERBELL' | TINKERBELL MOUNTAIN LAUREL | 5 GAL. | CONT. (NATIVE) |
| PRH | 6 | PIERIS ERIOBRYA 'HOOPS BLUE SPIRACE' | HOOPS BLUE SPIRACE | 5'-6' HT. | B4B |
| PDA | 25 | PIERIS JAPONICA 'YAKUSHIMANUM CAVATINE' | CAVATINE DWARF ANDROMEDA | 3 GAL. | CONT. |
| TCS | 35 | TAXUS CANADENSIS 'GREEN WAVE' | GREEN WAVE YEW | 5'-6' HT. | B4B |
| TSB | 3 | THUJA OCCIDENTALIS 'DEERROOTS SPIRE' | DEERROOTS SPIRE ARBORVITAE | 24'-30' SPIRE | B4B |
| TON | 10 | THUJA OCCIDENTALIS 'NON NON MILD BERRY' | NON NON MILD BERRY ARBORVITAE | 7'-8' HT. | B4B |
| PERENNIALS | | | | | |
| EPW | 75 | ECHINACEA PURPUREA 'ROSA NON MILD BERRY' | ROSA NON MILD BERRY CONEFLOWER | 5 PNT. | |
| GR | 55 | GERANIUM 'ROZANNE' | ROZANNE GERANIUM | 5 PNT. | |
| HFF | 1 | HOSTA 'FIRST FROST' | FIRST FROST HOSTA | 5 PNT. | |
| HSB | 25 | HOSTA 'STAINED GLASS' | STAINED GLASS HOSTA | 5 PNT. | |
| LSL | 5 | LEUCANTHEMUM SUPERBUM 'SNOW LADY' | SNOW LADY DWARF SHASTA DAISY | 5 PNT. | |
| PAC | 25 | PENSTEMON ALLEGRETTORIDES 'GASOSIAN' | GASOSIAN MOUNTAIN GRASS | 5 PNT. | |
| PCP | 25 | POLYSTICHUM ACROSTICHOIDES | CHRISTMAS FERN | 5 PNT. | |
| RBS | 11 | ROEBUCKIA FLUIDA FULGIDA | DWARF BLACK EYED SUSAN | 5 PNT. | |

GENERAL NOTES PLANTING:

- AS CONSTRUCTION PROCEEDS, FINE GRADE AND SEED OR SOD AS SOON AS POSSIBLE TO REDUCE RUNOFF.
- ALL DISTURBED AREAS NOT COVERED BY BUILDING, PAVING, PLANTING BEDS OR OTHER IMPROVEMENTS SHALL BE GRADED, TOPSOILED TO A DEPTH OF 6" AND SEEDED. PLANT BEDS SHALL BE TOPSOILED TO A DEPTH OF 12".
- IN ALL SHRUB BEDS TO RECEIVE MASS PLANTINGS, PROVIDE PINE BARK MULCH AS DETAILED. ESTABLISH A NEAT, SMOOTH EDGE BETWEEN MULCH AND LAWN.
- ADJUSTMENTS IN THE LOCATIONS OF PLANT MATERIALS MAY BE NECESSARY DUE TO LOCATIONS OF UTILITIES. ADJUSTMENTS SHALL BE APPROVED BY THE OWNER'S ARCHITECT.
- PROVIDE AND INSTALL ALL PLANTS SHOWN ON THE PLANTING PLAN DRAWINGS; THE QUANTITIES IN THE PLANT LIST ARE PROVIDED FOR THE CONTRACTOR'S CONVENIENCE ONLY. IF DISCREPANCIES OCCUR, THE DRAWING SYMBOLS PREVAIL OVER THE PLANT LIST QUANTITIES.
- ANY MEMORIAL PLAQUE OR OBJECT ENCOUNTERED TO BE GIVEN TO THE TOWN FOR DISPOSITION.

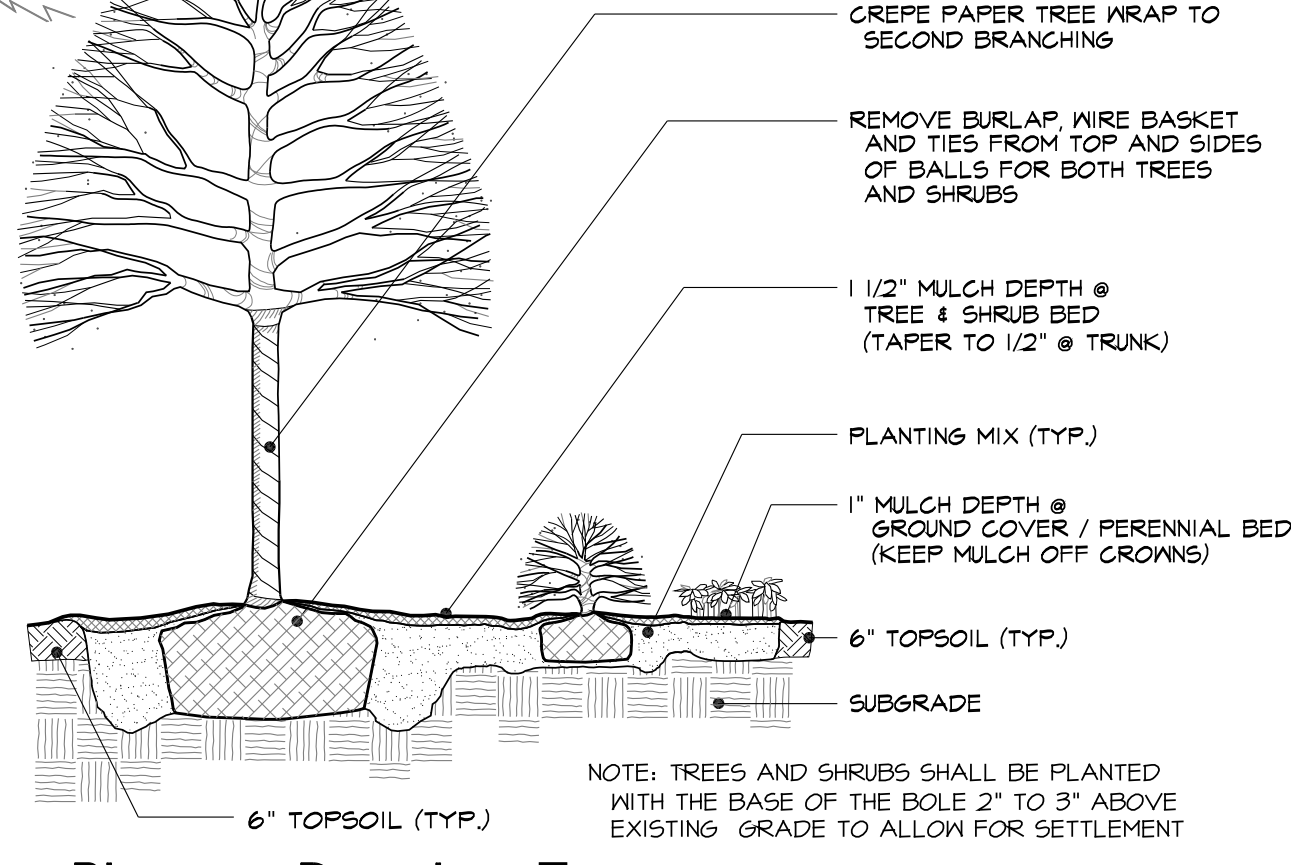

Town of Glastonbury
Reserved Land Zone
PROJECT/APPLICANT
2155 & 2143 Main Street Town Hall & Academy Building
PROJECT ADDRESS
Section 12
SPECIAL PERMIT SECTION
TPZ CHAIRPERSON
January 17, 2017
DATE SPECIAL PERMIT APP'D DIRECTOR OF COMMUNITY DEVELOPMENT
FILE NO.

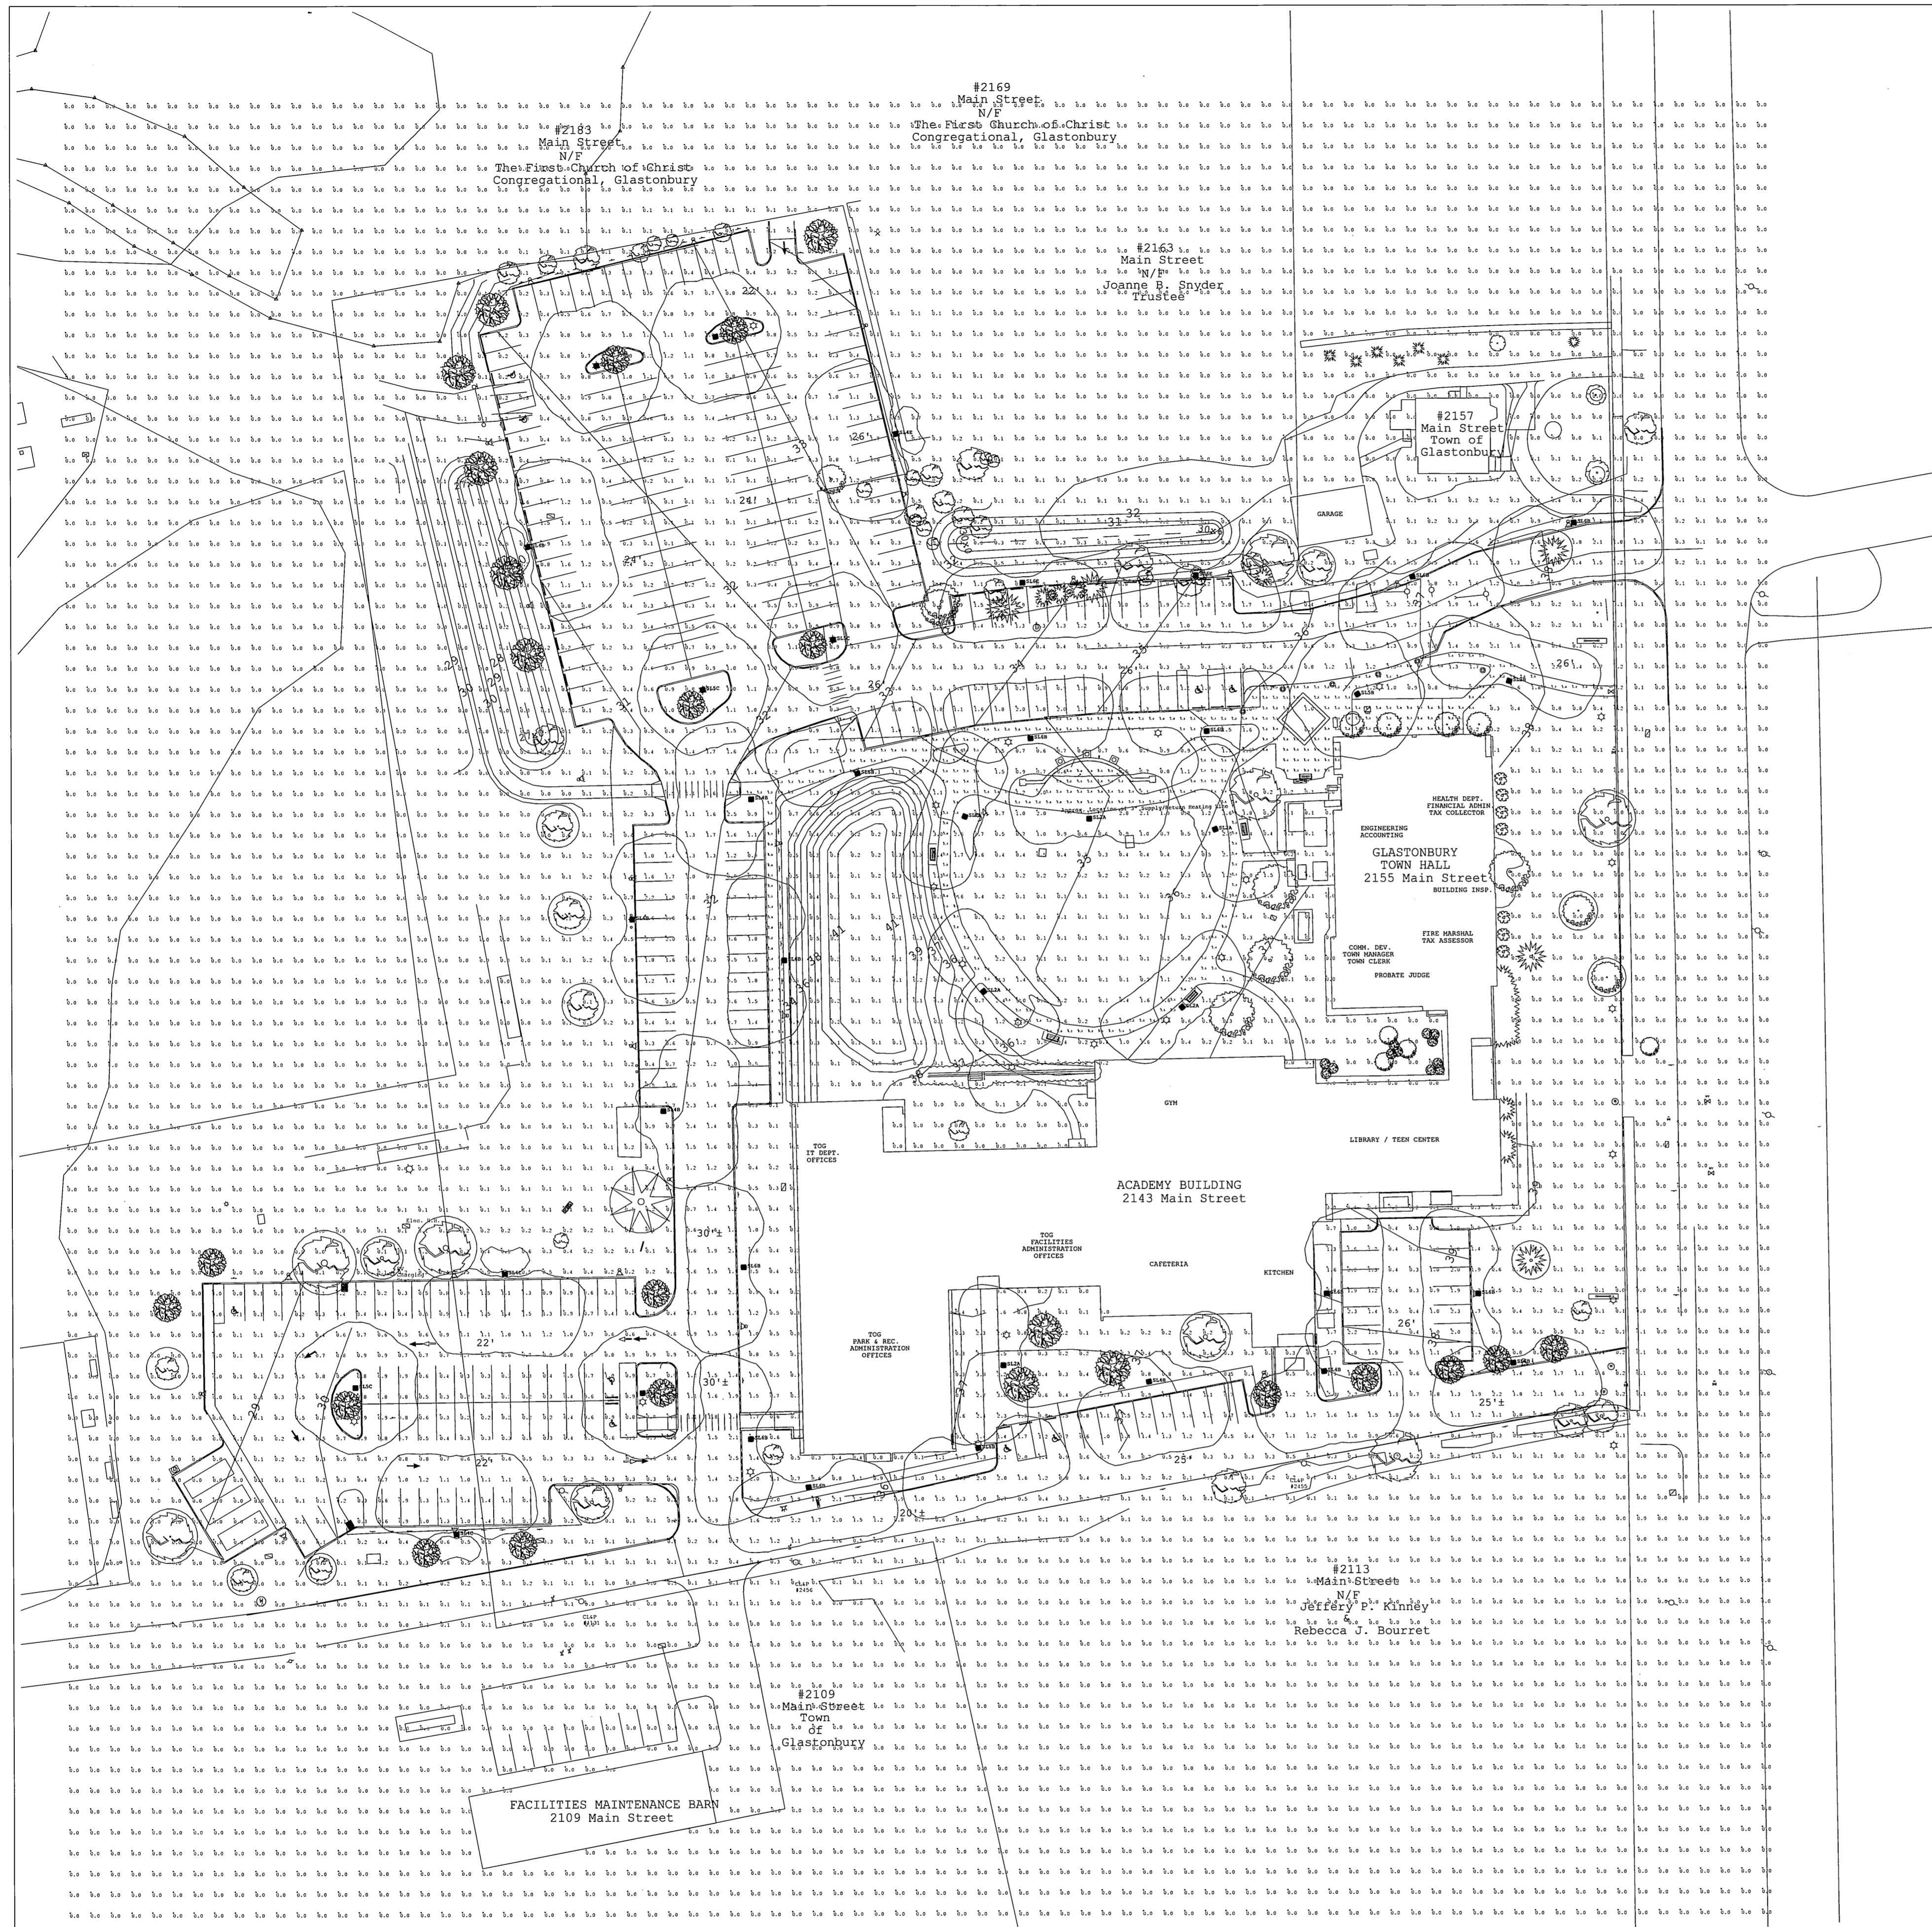

Town of Glastonbury
PROJECT/APPLICANT

Reserved Land Zone
ZONE

2155 & 2143 Main Street
PROJECT ADDRESS

Town Hall & Academy Building

Section 12
SPECIAL PERMIT SECTION

TPZ CHAIRPERSON

January 17, 2017
DATE SPECIAL PERMIT APP'D

DIRECTOR OF COMMUNITY DEVELOPMENT

FILE NO.

THIS MAP PRODUCED BY
ORIGINAL INK DRAWING ON
POLY FILM OR LINEN
TOWN OF GLASTONBURY
2155 MAIN STREET
GLASTONBURY, CT 06033

JOB NAME: GLASTONBURY TOWN HALL
AREA LIGHTING SOLUTIONS
WORKPLANE/CALC PLANE: AT FINISH GRADE
MOUNTING HEIGHT: SEE LUMINAIRE SCHEDULE
APPS: L&C
SCALE: 1/8"

| Luminaire Schedule | Qty | Label | Arrangement | Lumens | Input Watts | IEF | SPC Rating | Description |
|--------------------|-----|-------|-------------|--------|-------------|-------|------------|---|
| S2A | 1 | S2A | SINGLE | 6002 | 64.7 | 0.799 | R2-U3-G2 | STERNBERG 6130LED/ANC352/NDL03/FRC/CBA/FINISH / MTD TO 12FT POLE |
| S1B | 1 | S1B | SINGLE | 6002 | 64.7 | 0.799 | R2-U3-G2 | STERNBERG 6130LED/ANC352/NDL03/FRC/CBA/FINISH / MTD TO 12FT POLE |
| S1C | 3 | S1C | SINGLE | 5927 | 65.2 | 0.799 | R2-U3-G2 | STERNBERG 6130LED/ANC354/NDL03/FRC/CBA/FINISH / MTD TO 12FT POLE |
| S1C | 2 | S1C | SINGLE | 5927 | 65.2 | 0.799 | R2-U3-G2 | STERNBERG 6130LED/ANC354/NDL03/FRC/CBA/FINISH / MTD TO 14FT POLE |
| S2B | 1 | S2B | SINGLE | 5951 | 65.1 | 0.799 | R3-U3-G3 | STERNBERG 6130LED/ANC353/NDL03/FRC/CBA/FINISH / MTD TO 12FT POLE |
| S1C | 6 | S1C | SINGLE | 5951 | 65.1 | 0.799 | R3-U3-G3 | STERNBERG 6130LED/ANC353/NDL03/FRC/CBA/FINISH / MTD TO 14FT POLE |
| S1B | 14 | S1B | SINGLE | 5928 | 64.7 | 0.799 | R2-U3-G2 | STERNBERG 6130LED/ANC353R/NDL03/FRC/CBA/FINISH / MTD TO 12FT POLE |
| S1C | 2 | S1C | SINGLE | 5928 | 64.7 | 0.799 | R2-U3-G2 | STERNBERG 6130LED/ANC353R/NDL03/FRC/CBA/FINISH / MTD TO 12FT POLE |

| Calculation Summary | Label | Grid Height | Avg | Max | Min | Avg/Min | Max/Min |
|-----------------------|-------|-------------|------|-----|-----|---------|---------|
| CalcPts_1 | 0 | | 0.23 | 3.6 | 0.0 | N.A. | N.A. |
| WALKWAY | 0 | | 1.50 | 3.8 | 0.0 | N.A. | N.A. |
| PARKING & DRIVE LANES | | | 0.80 | 2.5 | 0.0 | N.A. | N.A. |

FOR INFORMATION ONLY

GENERAL DISCLAIMER:
Calculations have been performed according to IES standards and good practice. The user is responsible for providing accurate data and for verifying the results. The user is responsible for providing accurate data and for verifying the results. The user is responsible for providing accurate data and for verifying the results.



PROJECT TITLE:
GLASTONBURY TOWN HALL

DRAWING TITLE:
SITE LIGHTING PHOTOMETRIC CALCULATION

SCALE: None
DATE: 4/24/17
DRAWN BY: LRE
SHEET: 11 of 12

SL-1A

FILE: H:\DWG\Streets\Main\SI\PW-0908 ACADEMY SCHOOL SITE IMPROVEMENTS\Transfers\Irrigation\Town Hall Academy Ed-Chehire-17-080-2-CFS.dwg USER: Charles Steinhauser DATE: 5/5/2017

LEGEND FOR IRRIGATION
Irrigation Pipe Table

| Quantity | Symbol | Pipe |
|-------------|-------------|---|
| 2120' | | PVC MAIN: CLASS 200 2" SW PVC PIPE W/ WIRE |
| 3500' | | DRIPPERLINE: NETAFIM TLDL-6-18, 18" ROW, STAPLE EVERY 2' |
| 300' | | POLY LATERALS FOR DRIP: 100 PSI 1" POLY PIPE |
| 1140' | | PVC LATERALS: CLASS 200 1 1/2" SW PVC PIPE |
| 5500' | | POLY LATERALS: 100 PSI 1" POLY PIPE |
| 440' | | PVC SLEEVES: CLASS 200 4" PVC PIPE (BY OWNER) |
| 3000' 2500' | (no symbol) | WIRE: #18/16 UF MULTI-STRAND (3-RUNS) & #12/1 UF WHITE COMMON |

* PIPE & WIRE QUANTITIES ARE ROUNDED TO THE NEAREST ROLL OR LENGTH.

Irrigation Equipment Table

| Quantity | Symbol | Equipment |
|----------|--------|--|
| 17 | | ZONE VALVE: HUNTER PGV-151G 1 1/2" W/ BALL VALVE |
| 9 | | ZONE VALVE: HUNTER PGV-101G 1" W/ BALL VALVE |
| 6 | | DRIP VALVE: HUNTER PCZ-101-40 1" W/ BALL VALVE |
| 5 | | ISOLATION VALVES: APOLLO BALL VALVE, LINE SIZED |
| 3 | | QUICK COUPLER VALVE: HUNTER 1" HQ-44 W/ HK-44 KEY |
| 2 | | CONTROLLER: WEATHERMATIC SMARTLINE SL1624 (SEE NOTES) |
| 2 | | RAIN SENSOR: WEATHERMATIC SLW1 |
| 1 | | NEW POINT OF CONNECTION: 2" @ 85 PSI, INSTALL BALL VALVE W/ DRAIN. |
| 1 | | NEW BLOW OUT: TEE CONNECTION |
| 1 | | EXISTING BACKFLOW AT BALLFIELDS |
| 1 | | DRIP INDICATORS & FLUSH VALVES AS NEEDED FOR DRIP ZONES |

Irrigation Heads Table

| Quantity | Symbol | Sprinkler Heads |
|----------|--------|--|
| 15 | | MEDIUM ROTARY SPRINKLER: HUNTER PGR-04-S, FULL CIRCLE |
| 131 | | MEDIUM ROTARY SPRINKLER: HUNTER PGR-04-2.5, ADJUSTABLE |
| 138 | | SPRAY HEAD: HUNTER PROS-04-PRS40-CV, MP2000 |
| 14 | | SPRAY HEAD: HUNTER PROS-04-PRS40-CV, MP1000 |
| 9 | | SPRAY HEAD: HUNTER PROS-04, SS530 |
| 3 | | SPRAY HEAD: HUNTER PROS-04, RCS515 |
| 17 | | SPRAY HEAD: HUNTER PROS-04, 12A |


NOTES FOR IRRIGATION

- SYSTEM IS DESIGNED FOR 2 TO 37 GPM PER ZONE. PRESSURE HAS BEEN REPORTED AS 100 PSI STATIC, 85 PSI RESIDUAL WATER (EX. 2" @ SOFTBALL) & POWER (EX. ELECTRIC ON POLE) ARE EXISTING. FIELD LOCATE WEATHER SENSOR, 1 SENSOR PER CONTROLLER, ON POLE, WIRES, CONNECTORS, & CONDUIT AS NEEDED. SLEEVES: ALL 4" CL 200 PVC, BY OWNER ROAD CUTS, SLEEVE LOCATING, BORING BY THE TOWN.
- FOLLOW ALL MANUFACTURER'S INSTALLATION INSTRUCTIONS.
- DESIGN IS DIAGRAMMATIC. INSTALLER SHALL FIELD LOCATE ALL ITEMS WITHOUT COMPROMISING THE INTEGRITY OF THIS DESIGN. ANY CHANGES TO THE NUMBER OF HEADS OR VALVES, OR TO THE HYDRAULICS SHALL BE SUBMITTED TO THE ARCHITECT PRIOR TO THE COMMENCEMENT OF WORK. PIPE ROUTING, HEAD AND VALVE PLACEMENT SHALL BE THE RESPONSIBILITY OF THE INSTALLER, USING THIS DESIGN AS A GUIDE.
- AVERAGE RUN TIMES PER ZONE TO ACHIEVE 1" OF WATER PER WEEK IS AS FOLLOWS: ROTARY & MP: 30 MINUTES PER DAY (MINI-DAY); SPRAY: 15 MIN/DAY; DRIP: 30 MIN/DAY. END USER SHALL PROPERLY ADJUST RUN TIMES FOR CHANGING FIELD AND SEASONAL CONDITIONS.
- IRRIGATION INSTALLER IS RESPONSIBLE FOR, BUT NOT LIMITED TO THE COMPLETE INSTALLATION OF THIS IRRIGATION SYSTEM. FOLLOW ALL APPLICABLE CODES AND LAWS. CONTACT A UTILITY MARKING COMPANY PRIOR TO THE COMMENCEMENT OF WORK. IRRIGATION WORK TO INCLUDE ATTACHING TO THE WATER SUPPLY, VERIFYING THE PRESSURE, CONTROLLER INSTALLATION, WEATHER SENSOR INSTALLATION, VALVES, SPRINKLERS, DRIP, PIPE & WIRE, AND RELATED ITEMS.
- ALL WORK SHALL BE COORDINATED WITH THE TOWN PRIOR TO THE BID FINALIZATION.
- CONTROLLER TO INCLUDE THE FOLLOWING: FLOW BUNDLE PACKAGE, WIRELESS WEATHER SENSOR, AIR CARD, 2 YEAR SMARTLINK SERVICE, MASTER VALVE & FLOW SENSOR AND REQUIRED MODULES FOR (2) 24 STATION CONTROLLERS. THERE WILL BE (2) CONTROLLERS, THERE ARE (8) ZONES ON THE TOWN ACADEMY FIELD THAT SHALL BE ADDED TO THIS NEW SYSTEM. CONTROLLER DETAILS AND INSTALLATION INSTRUCTIONS ARE AVAILABLE AT WWW.WEATHERMATIC.COM






EXISTING ELECTRIC SERVICE. INSTALL NEW CONTROLLER IN STRONG BOX ENCLOSURE SB24SS W/ CONDUIT AS NEEDED. FIELD LOCATE WEATHER SENSORS.

MASTER VALVE: HUNTER ICV-151G FLOW SENSOR: SLFSI-T20 IN STANDARD VALVE BOXES

WATER: EX. 2" W/ BACKFLOW. LOCATE & ATTACH NEW 2" PVC MAIN.

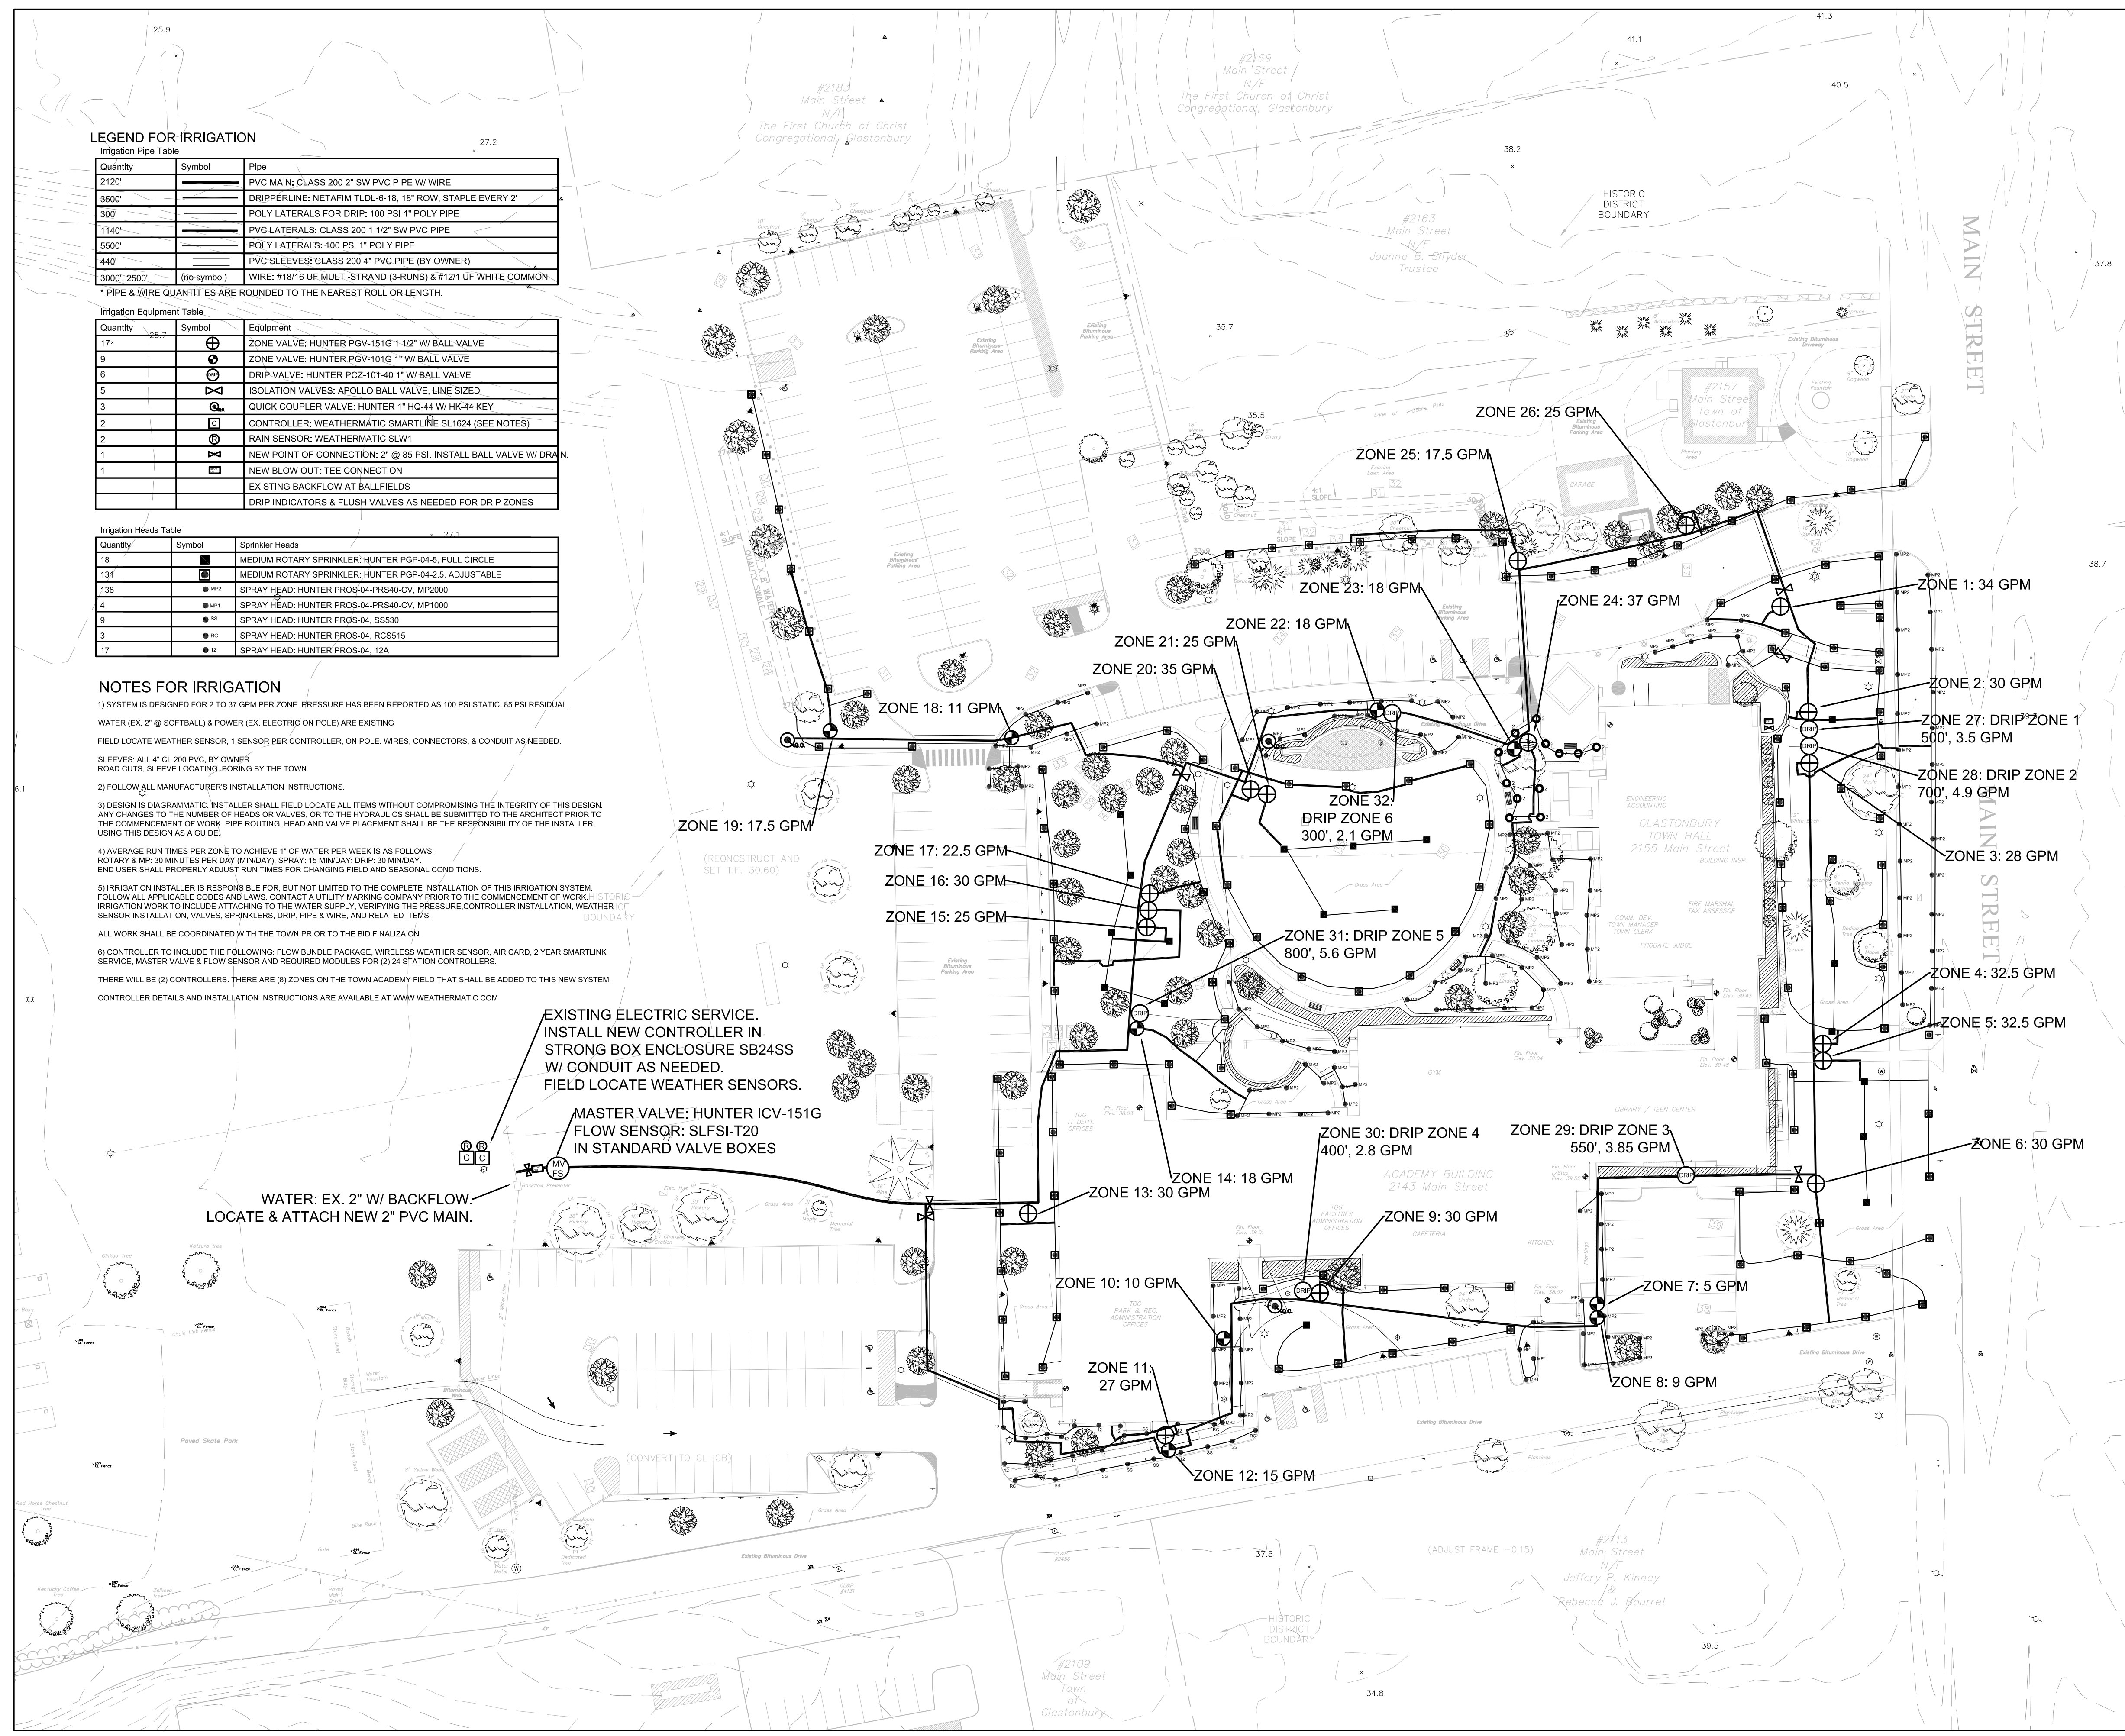


DETAILS FOR IRRIGATION
(not to scale)

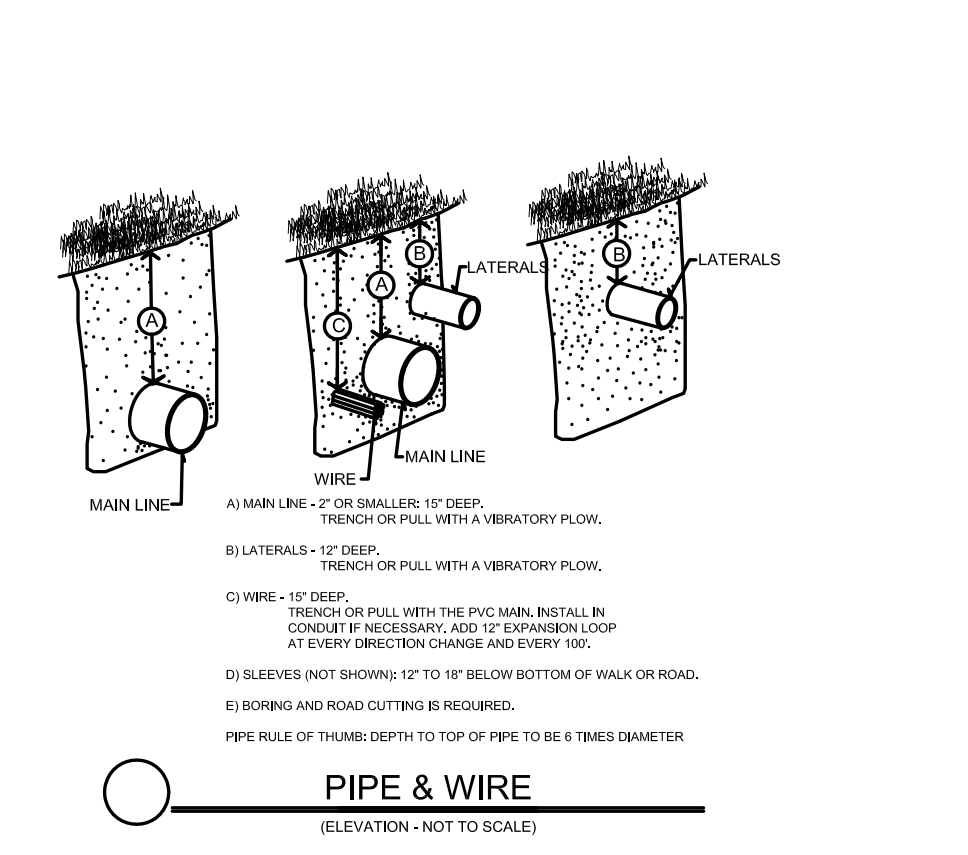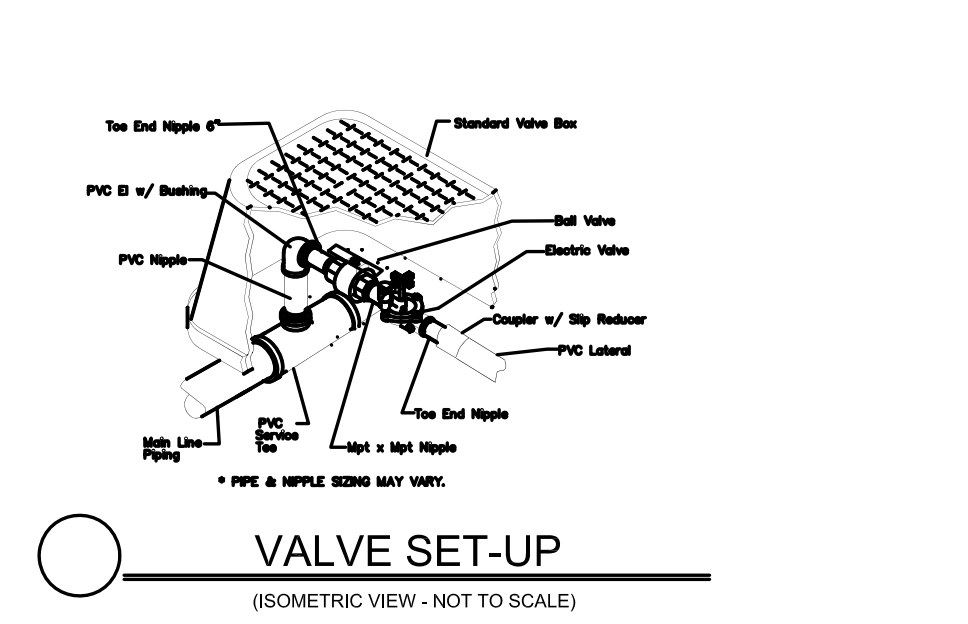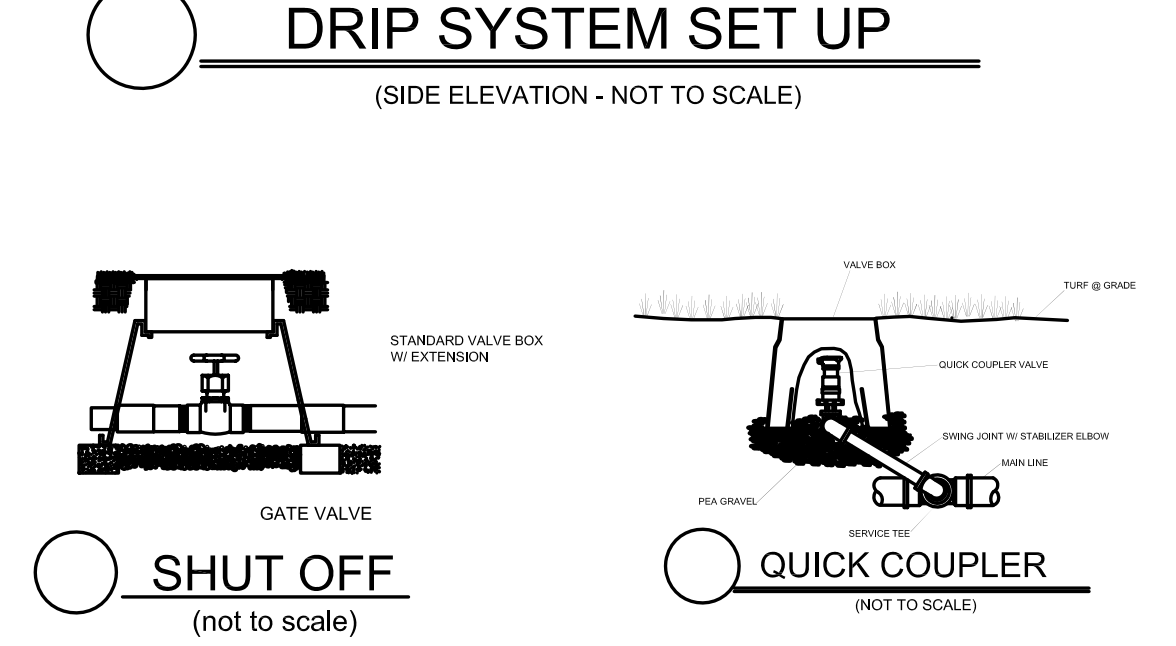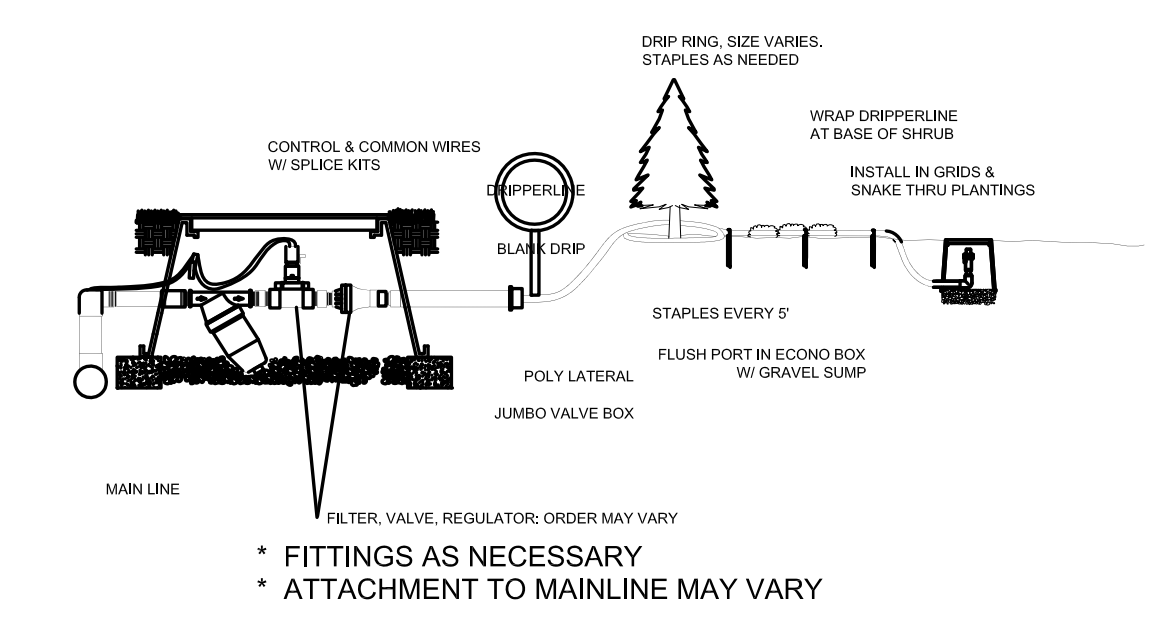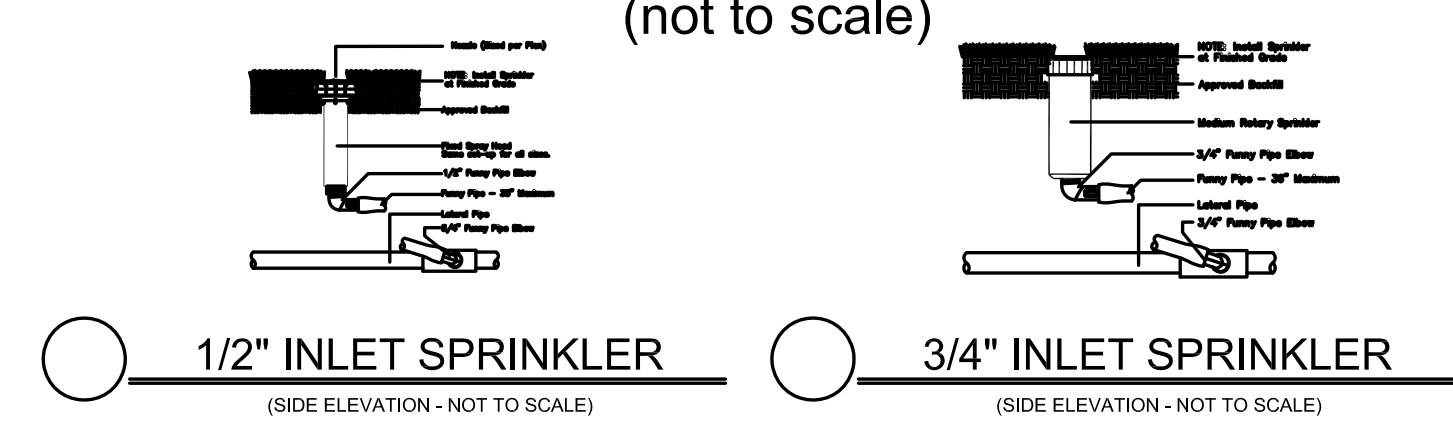


IRRIGATION CONTROLLER DETAILS AVAILABLE AT: WWW.WEATHERMATIC.COM

ALL UTILITY INFORMATION AND DATA SHOWN OR INDICATED IN THE CONTRACT DOCUMENTS ARE COMPILED FROM MAPS AND DATA FURNISHED BY OTHERS. ANY SUCH INFORMATION SHOULD NOT BE CONSIDERED AS ACCURATE OR COMPLETE AND THE CONTRACTOR SHALL VERIFY ALL LOCATIONS PRIOR TO CONSTRUCTION.

MANUAL REVISIONS TO THIS DOCUMENT ARE PROHIBITED. ALL REVISIONS MUST BE PERFORMED ON CADD FILE. H:\DWG\Streets\Main\SI\PW-0908 ACADEMY SCHOOL SITE IMPROVEMENTS\Transfers\Irrigation\Town Hall Academy Ed-Chehire-17-080-2-CFS.dwg


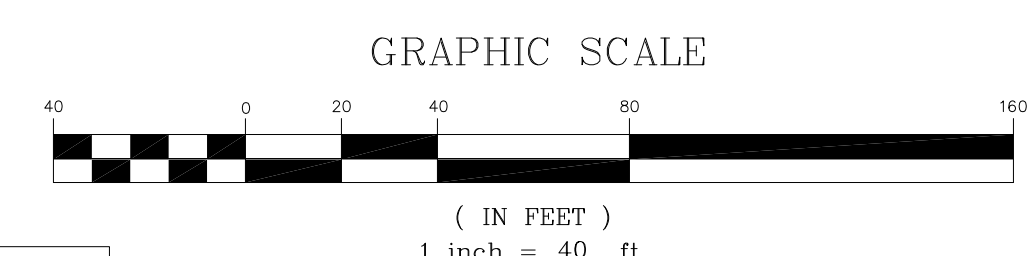


| DRAWING ISSUE STATUS | | |
|----------------------|----------------------------|----------|
| NO. | DESCRIPTION | DATE |
| 1. | ISSUED FOR LANDSCAPING BID | 5/5/2017 |

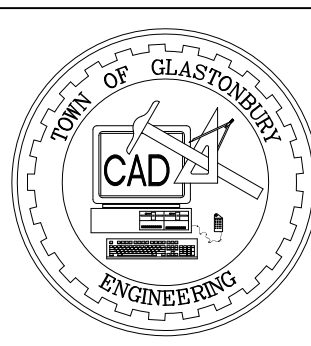

| | |
|------------------|-----------------|
| SCALE: AS SHOWN | DATE: 4/18/17 |
| DRAWN BY: ELB | CHECKED BY: ELB |
| APPROVED BY: ELB | ST. FILE: |

DO NOT SCALE THIS DRAWING. USE THE DIMENSIONS GIVEN. IF THERE ARE ANY DISCREPANCIES OR QUESTIONS, CONTACT THE TOWN OF GLASTONBURY, ENGINEERING OFFICE.

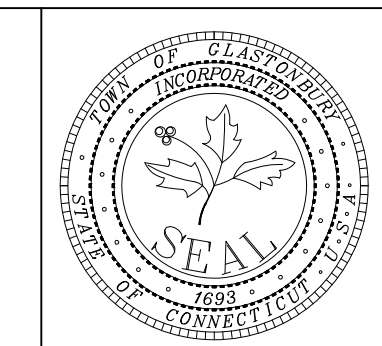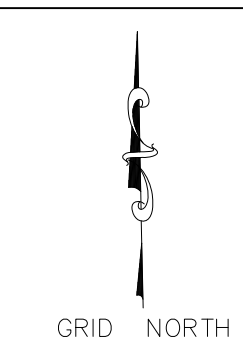

IRRIGATION
PLAN DEPICTING NEW IRRIGATION TOWN HALL / ACADEMY COMPLEX DRIVE & PARKING RECONFIGURATION
LOCATED AT
2155 / 2143 MAIN STREET
GLASTONBURY, CONNECTICUT

SHEET NO. **12**
OF 12