TOWN OF GLASTONBURY GL-2015-14 NEW TOWN FACILITIES AND MAINTENANCE BARN ADDENDUM NO. 1 OCTOBER 31, 2014

Bid Due Date: 11/12/14 @ 11:00 A.M.

The attention of bidders submitting proposals for the above-referenced project is called to the following Addendum to the specifications. The items set forth herein, whether of omission, addition, substitution or other change, are all to be included in and form a part of the proposed Contract Documents for the work. Bidders shall acknowledge this Addendum in the Bid Proposal by inserting its number on Page BP-1.

BIDDERS ARE ADVISED THAT SITE PLAN SHEET NO. C-1 WAS REVISED:

The attached plan has been REVISED to include the lines depicting the silt fence / clearing limit. These lines are not visible on the original plan that was included with the bid.

This addendum consists of 1 page of text and 1 revised plan titled Sheet No. C-1

END OF TEXT

SURVEY NOTES:

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LOCATION OF FEATURES AND CONTOUR DATA DEPICTED HEREON WHERE ACQUIRED THROUGH FIELD SURVEY CONDUCTED IN MAY 2014.

THERE IS NO BOUNDARY/DETERMINATION OPINION.

NOT ALL IMPROVEMENTS ARE DEPICTED HEREON.

HORIZONTAL CONTROL IS BASED ON THE CONNECTICUT GEODETIC SURVEY STATE PLANE COORDINATES, NORTH AMERICAN DATUM OF 1983 - (NAD83). ELEVATIONS AND VERTICAL CONTROL IS BASED ON THE NORTH AMERICAN VERTICAL DATUM 1988 - (NAVD88).

THE 100 FOOT UPLAND REVIEW LINE WAS OBTAINED FROM A PLAN TITLE "SITE DEVELOPMENT PLAN CARSON SUBDIVISION PREPARED FOR CAROL E. CARSON GLASTONBURY, CONN. REINO E. HYYPPA & ASSOCIATES CIVIL ENGINEERS & LAND SURVEYORS 124 HEBRON AVENUE GLASTONBURY, CONN 06033 (203) 633-5218 SCALE: 1"=40' DATE: 11-8-94 MAP No. 66-93-1A"

THIS PLAN WAS COMPILED FROM OTHER MAPS, RECORD RESEARCH OR OTHER SOURCES OF INFORMATION. IT IS NOT TO BE CONSTRUED AS HAVING BEEN OBTAINED AS THE RESULT OF A FIELD SURVEY, AND IS SUBJECT TO SUCH CHANGE AS AN ACCURATE FIELD SURVEY MAY DISCLOSE.

REPRODUCTIONS OF THIS PLAN ARE INVALID IF THEY DO NOT BEAR THE IMPRESSION SEAL OF THE UNDERSIGNED LAND SURVEYOR AND/OR PROFESSIONAL ENGINEER.


LIGHTING NOTES:

SITE LIGHTING SHALL CONSIST OF MOUNTED LIGHTING FIXTURES DIRECTED AT THE PARKING LOT AREAS. SUCH LIGHTING FIXTURES WILL BE DARK SKY COMPLIANT.

SCOPE OF WORK / CONSTRUCTION SEQUENCE

NOTE: ALL WORK DESCRIBED BELOW IS INCLUDED IN THE CONTRACT UNLESS SPECIFICALLY NOTED AS "BY TOWN".

- CONTACT "CALL BEFORE DIG" A MINIMUM OF 48 HOURS PRIOR TO ANY EXCAVATION ACTIVITIES. LOCATION OF UNDERGROUND UTILITIES SHOWN ON THE PLAN IS FROM RECORD DRAWINGS AND OTHER SOURCES AND SHOULD BE CONSIDERED APPROXIMATE.
- 2. STAKE LIMITS OF CLEARING AND LOCATION OF PERIMETER SILT FENCE (ALL CONSTRUCTION STAKING BY TOWN).
- . Contractor to flag trees to be removed for review by town tree
- WARDEN. (10 DAY POSTING OF TREES TO BE REMOVED IS REQUIRED). 4. INSTALL SEDIMENTATION CONTROL SYSTEM AT LIMITS SHOWN. MATERIALS AND CONSTRUCTION METHODS SHALL COMPLY WITH SECTION 2.19 OF THE CONNDOT
- FORM 816. 5. INSTALL TEMPORARY CONSTRUCTION ENTRANCE AT THE LOCATION INDICATED. STONE SHALL BE NO. 3 STONE AS PER SECTION MOI.01 OF THE CONNDOT FORM 816. GEOTEXTILE SHALL MEET REQUIREMENTS OF THE CONNDOT PUBLICATION "QUALIFIED PRODUCTS LIST FOR CONNECTICUT DEPARTMENT OF TRANSPORTATION PRODUCTS", LATEST EDITION FOR THE CATEGORY "SEPARATION - MEDIUM SURVIVABILITY"
- PERFORM CLEARING AND GRUBBING WITHIN THE LIMITS SHOWN ON THE PLAN AS PER SECTION 2.01 OF THE CONNDOT FORM 816. PROTECT TREES TO REMAIN WITH ORANGE CONSTRUCTION FENCE. (BRUSH, STUMPS, WOOD, AND EXCESS OR UNSUITABLE SOIL CAN BE DISPOSED OF BY THE CONTRACTOR AT THE TOWN BULKY WASTE FACILITY ON TRYON STREET AT NO CHARGE.)
- REMOVE AND DISPOSE OF SOD WITHIN LIMITS OF CONSTRUCTION. STRIP AND STOCKPILE TOPSOIL FOR REUSE BY OWNER. PROTECT TOPSOIL STOCKPILE WITH SILT FENCE.
- 8. EXCAVATE AND INSTALL CONCRETE FOOTINGS AND FOUNDATION. BACKFILL AND ROUGH GRADE AROUND FOUNDATION AS PER PROJECT SPECIFICATIONS. 9. SAWCUT AND REMOVE PAVEMENT WITHIN EXISTING BITUMINOUS DRIVEWAY AS
- NECESSARY FOR UTILTY INSTALLATION. PERFORM TEMPORARY BITUMINOUS PAVEMENT PATCH ACCORDING TO PROJECT PLANS AND TOWN OF GLASTONBURY STANDARDS AFTER UTILITY INSTALLATION IS COMPLETE.
- 10. INSTALL SEWER LATERAL AND PRECAST CONCRETE MANHOLE ACCORDING TO PROJECT PLANS AND TOWN OF GLASTONBURY STANDARDS AS DESCRIBED IN THE "PUBLIC IMPROVEMENT STANDARDS MANUAL" AVAILABLE FROM THE ENGINEERING DEPARTMENT HOMEPAGE. (TOWN OF GLASTONBURY SEWER PERMIT IS REQUIRED FOR THIS WORK). EXTEND SEWER PIPE TO TOILET ROOM LOCATION SHOWN ON THE ARCHITECTURAL PLANS.
- 11. INSTALL DOMESTIC AND FIRE PROTECTION WATER SERVICES AS SHOWN ON THE PLANS. COORDINATE ALL WORK WITH THE UTILITY COMPANY AND OBTAIN ALL PERMITS AS REQUIRED. ALL WATER SERVICE MATERIALS, EQUIPMENT, AND INSTALLATION METHODS SHALL CONFORM TO THE "MDC WATER SERVICE STANDARDS / APPROVED MATERIALS LIST" AS PUBLISHED ON THE METROPOLITÁN DISTRICT COMMISSION WEBSITE, LATEST EDITION, AND ALL
- APPLICABLE PUBLIC HEALTH CODE REQUIREMENTS. 12. WATER PIPES SHALL BE FLUSHED PER AWWA C-651. TESTING AND DISINFECTION SHALL BE PER ASTM 651-86 SECTION 1-10 AND AS REQUIRED BY PUBLIC HEALTH CODE AND THE MDC. PRESSURE TESTING SHALL BE PERFORMED BY THE CONTRACTOR IN ACCORDANCE WITH AWWA C-600 (150 PSI FOR 2 HOURS). BACTERIOLOGICAL TESTING AS REQUIRED FOR MDC AND PUBLIC HEALTH CODE IS INCLUDED IN THE CONTRACT.
- 13. INSTALL CONDUITS AND GALVANIZED SWEEPS FOR ELECTRIC, TELEPHONE, AND CATV SERVICE AS SHOWN ON THE PLANS AND AS REQUIRED BY APPLICABLE UTILITY COMPANIES.
- 14. COORDINATE WITH CL&P FOR INSTALLATION OF NEW ELECTRIC SERVICE. INCLUDING REQUEST FOR NEW SERVICE AND ALL COSTS ASSOCIATED THEREWITH. ELECTRIC SERVICE MATERIALS, EQUIPMENT, AND CONSTRUCTION METHODS SHALL CONFORM TO THE DOCUMENT TITLED "INFORMATION AND REQUIREMENTS FOR ELECTRIC SUPPLY BELOW 600 VOLTS", LATEST EDITION, AS PUBLISHED BY NORTH EAST UTILITIES, AND ALL BUILDING CODE REQUIREMENTS.
- 15. PERFORM TRENCH EXCAVATION AND BACKFILL FOR PROPOSED GAS SERVICE PER CNG REQUIREMENTS AS DESCRIBED IN THE PROJECT SPECIFICATIONS. COORDINATE WITH CONNECTICUT NATURAL GAS FOR INSTALLATION OF GAS SERVICE TO NEW BUILDING. (INSTALLATION OF PIPING IS BY CNG).
- 16. INSTALL PROPOSED STORM DRAINAGE SYSTEM, INCLUDING DRYWELL, CATCH BASIN, LEACHING GALLEY, SWALE WITH EROSION CONTROL MATTING, AND ROOF LEADER PIPING (BY TOWN). EROSION CONTROL MATTING SHALL BE EAST COAST EROSION BLANKETS MODEL ECL-2B OR OTHER APPROVED "TYPE E" MATTING AS LISTED IN THE CONNDOT PUBLICATION ""QUALIFIED PRODUCTS LIST FOR CONNECTICUT DEPARTMENT OF TRANSPORTATION PRODUCTS", LATEST EDITION.
- 17. FORM SUBGRADE FOR PARKING LOT, INSTALL BASE MATERIAL AND PAVE PARKING LOT AS PER PROJECT DETAILS AND RELEVANT SECTIONS OF THE CONNDOT FORM 816 (BY TOWN). 18. FINE GRADE WITHIN LIMITS OF DISTURBANCE, INSTALL 4" OF TOPSOIL AND TURF
- ESTABLISHMENT (BY TOWN). 19. INSTALL PROPOSED PLANTINGS AS SHOWN ON THE PLAN (BY TOWN).

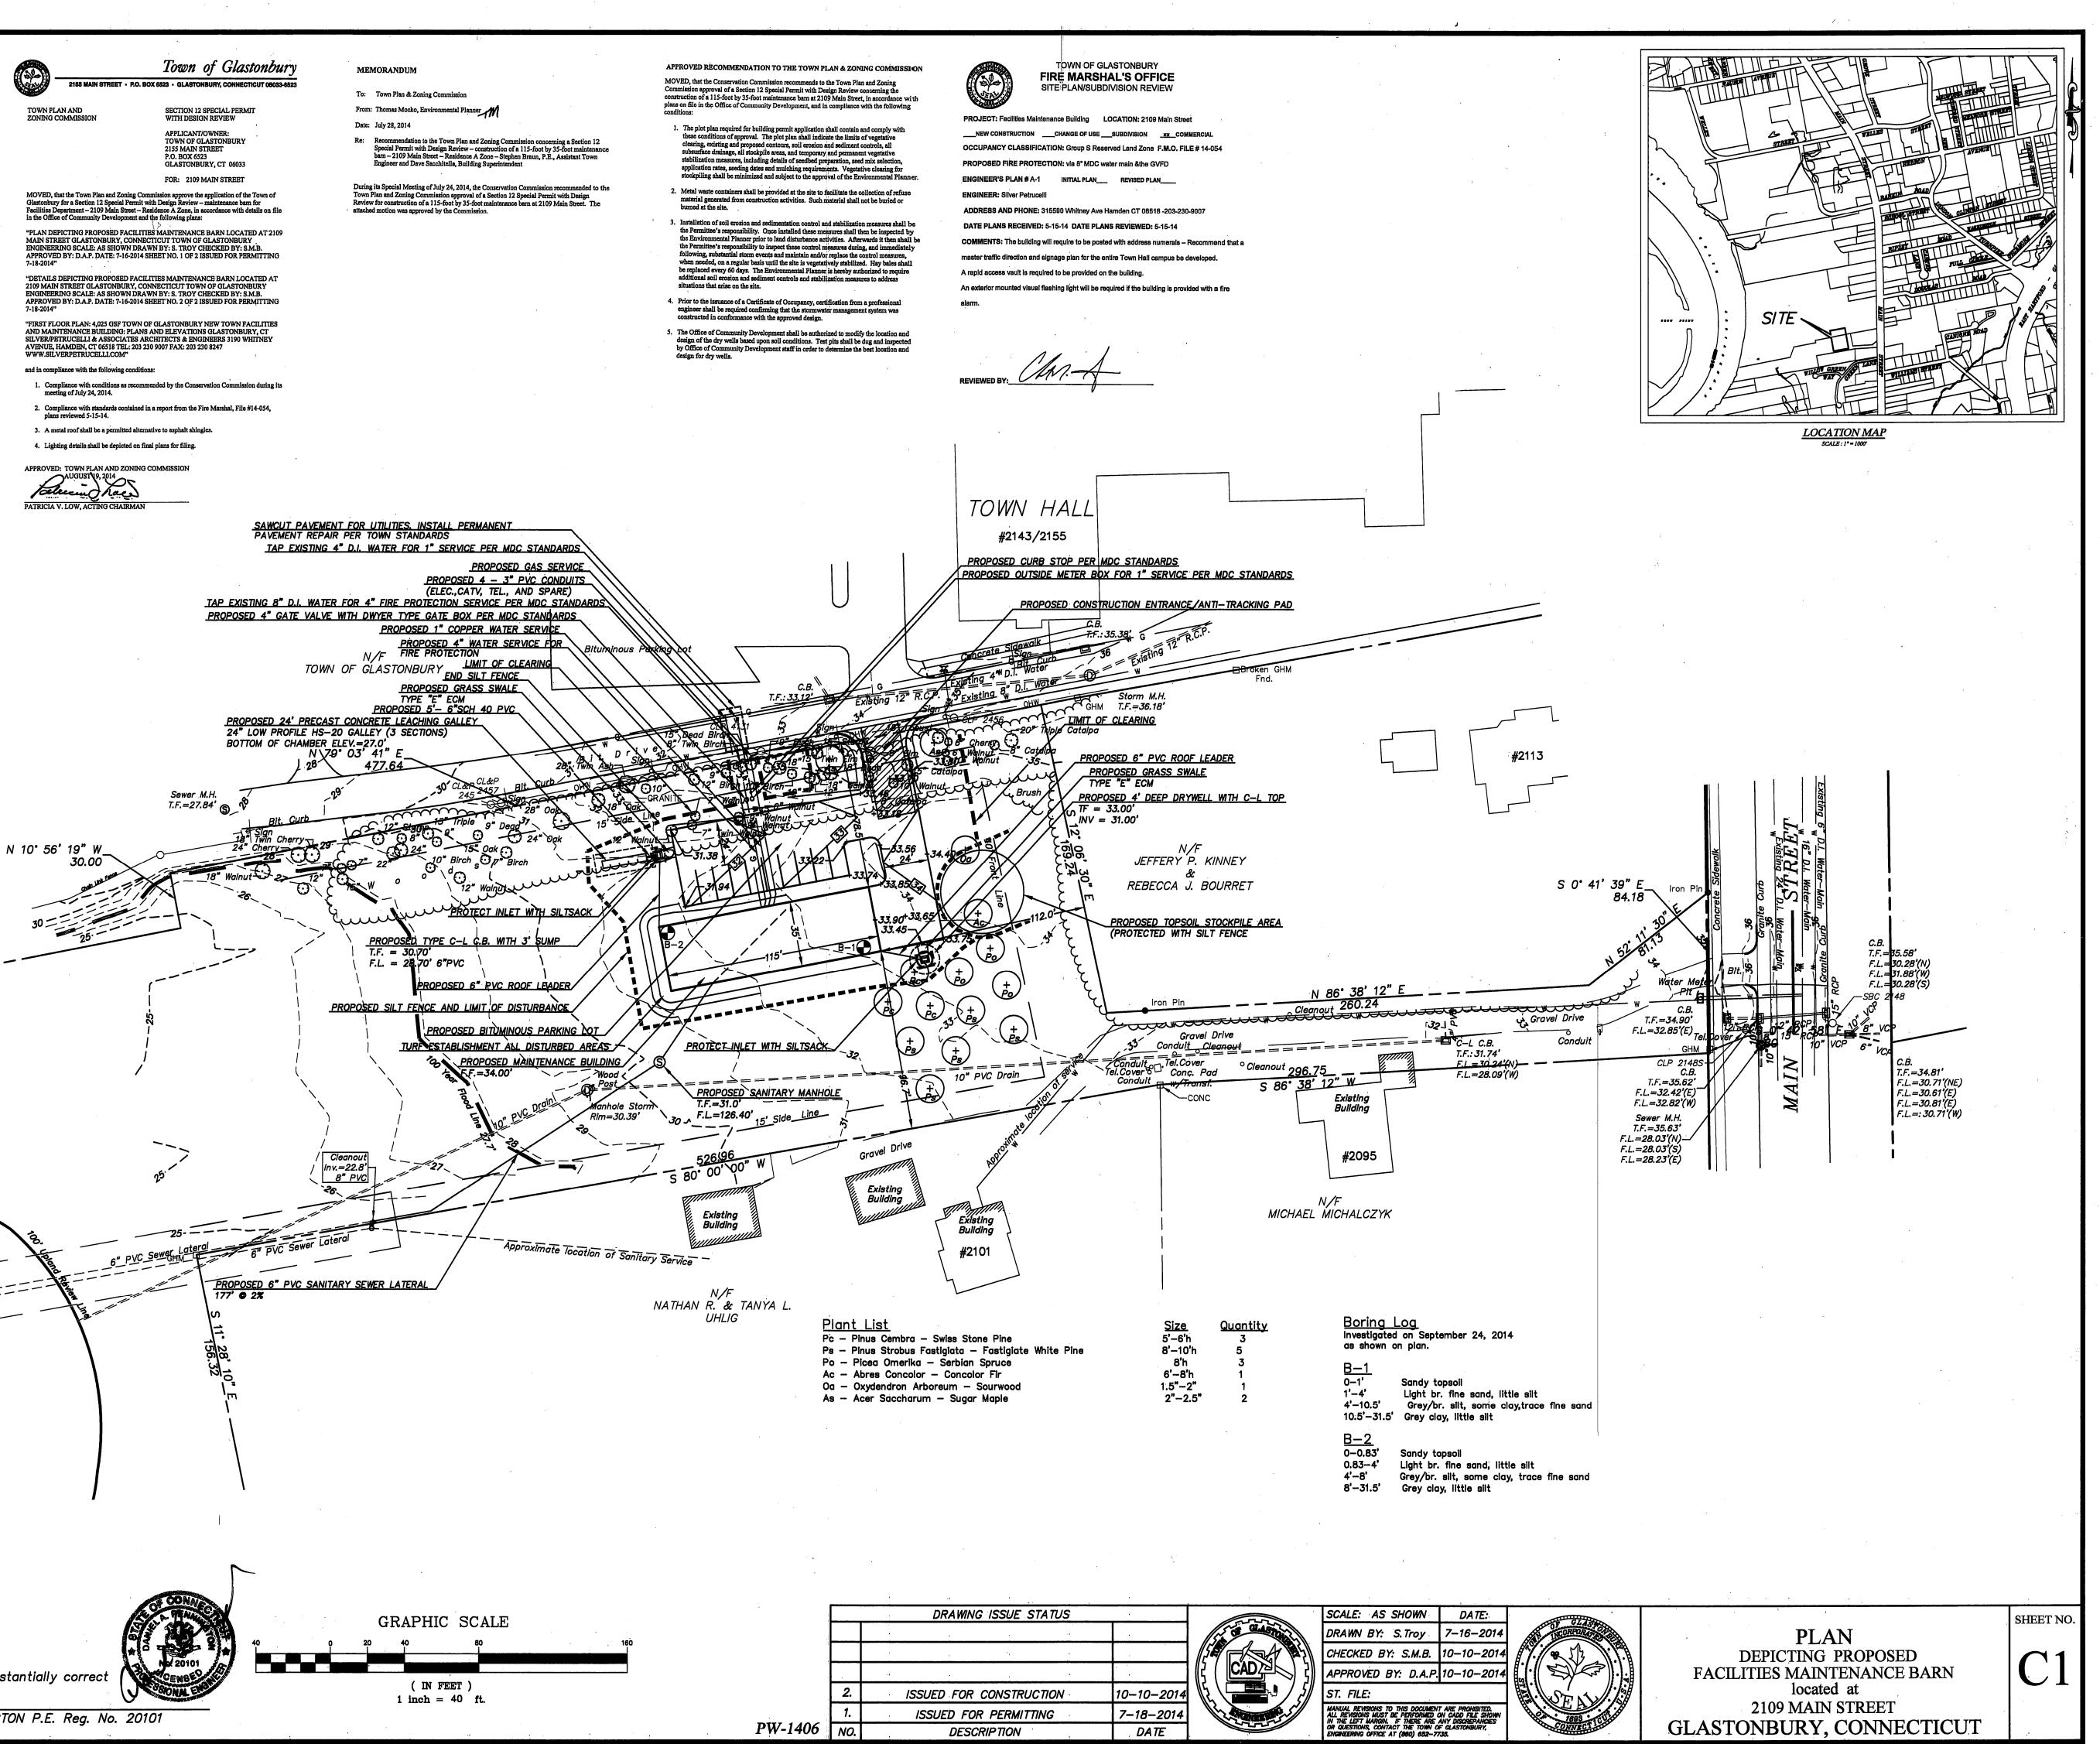



Certified to be substantially correct

DANIEL A. PENNINGTON P.E. Reg. No. 20101

RAPHIC SCALE			DRAWING ISSUE STATUS			(arrow)
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			- 4			[[{ ([CAD /⊉ ⌒) }]
(IN FEET $)1 inch = 40 ft.$		<i>2</i> .		ISSUED FOR CONSTRUCTION	10-10-2014	
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	PW-1406	NO.		DESCRIPTION	DATE	
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